

BRIAN SILVI CAL

SITE PLAN

SCALE,
AS SHOWN
DRAWN BY:
D. JOHNSON
PROJECT:
BRIAN ARDEN WINERY

## **EXAMINATION OF SITE DOCUMENTS**

EACH BIDDER SHALL VISIT THE SITE OF THE PROPOSED WORK AND FULLY ACQUAINT HIMSELF WITH THE CONDITIONS AS THEY EXIST SO THAT HE MAY FULLY UNDERSTAND THE FACILITIES, DIFFICULITIES, AND RESTRICTIONS ATTENDING TO THE EXECUTION OF THE WORK UNDER THE CONTRACT.


THE CONTRACTOR SHALL VERIFY ALL DIMENSIONS AT THE JOBSITE AND SHALL BE RESPONSIBLE FOR ALL THE DISCREPANCIES BETWEEN DIMENSIONS OF THE ACTUAL WORK AND THOSE SHOWN ON THE DRAWINGS.

## INSTALLATION OF MATERIALS


ALL MATERIALS AND EQUIPMENT SPECIFIED AND/OR SUBSTITUTED SHALL BE INSTALLED AS SPECIFIED BY MANUFACTURER'S SPECIFICATIONS AND REFERENCE STANDARDS.

# PROTECTION OF NATURAL FEATURES

ALL TREES AND OTHER NATURAL FEATURES ON THE SITE AND ADJACENT AREAS NOTED OR DESIGNATED TO REMAIN SHALL BE PROTECTED FROM ALL INJURY, THE CONTRACTOR SHALL TAKE ALL NECESSARY PRECAUTIONS TO PRESERVE THE TREES. NO DIESEL OR GASOLINE ENGINES SHALL BE LEFT RUNNING UNDER TREES TO REMAIN.

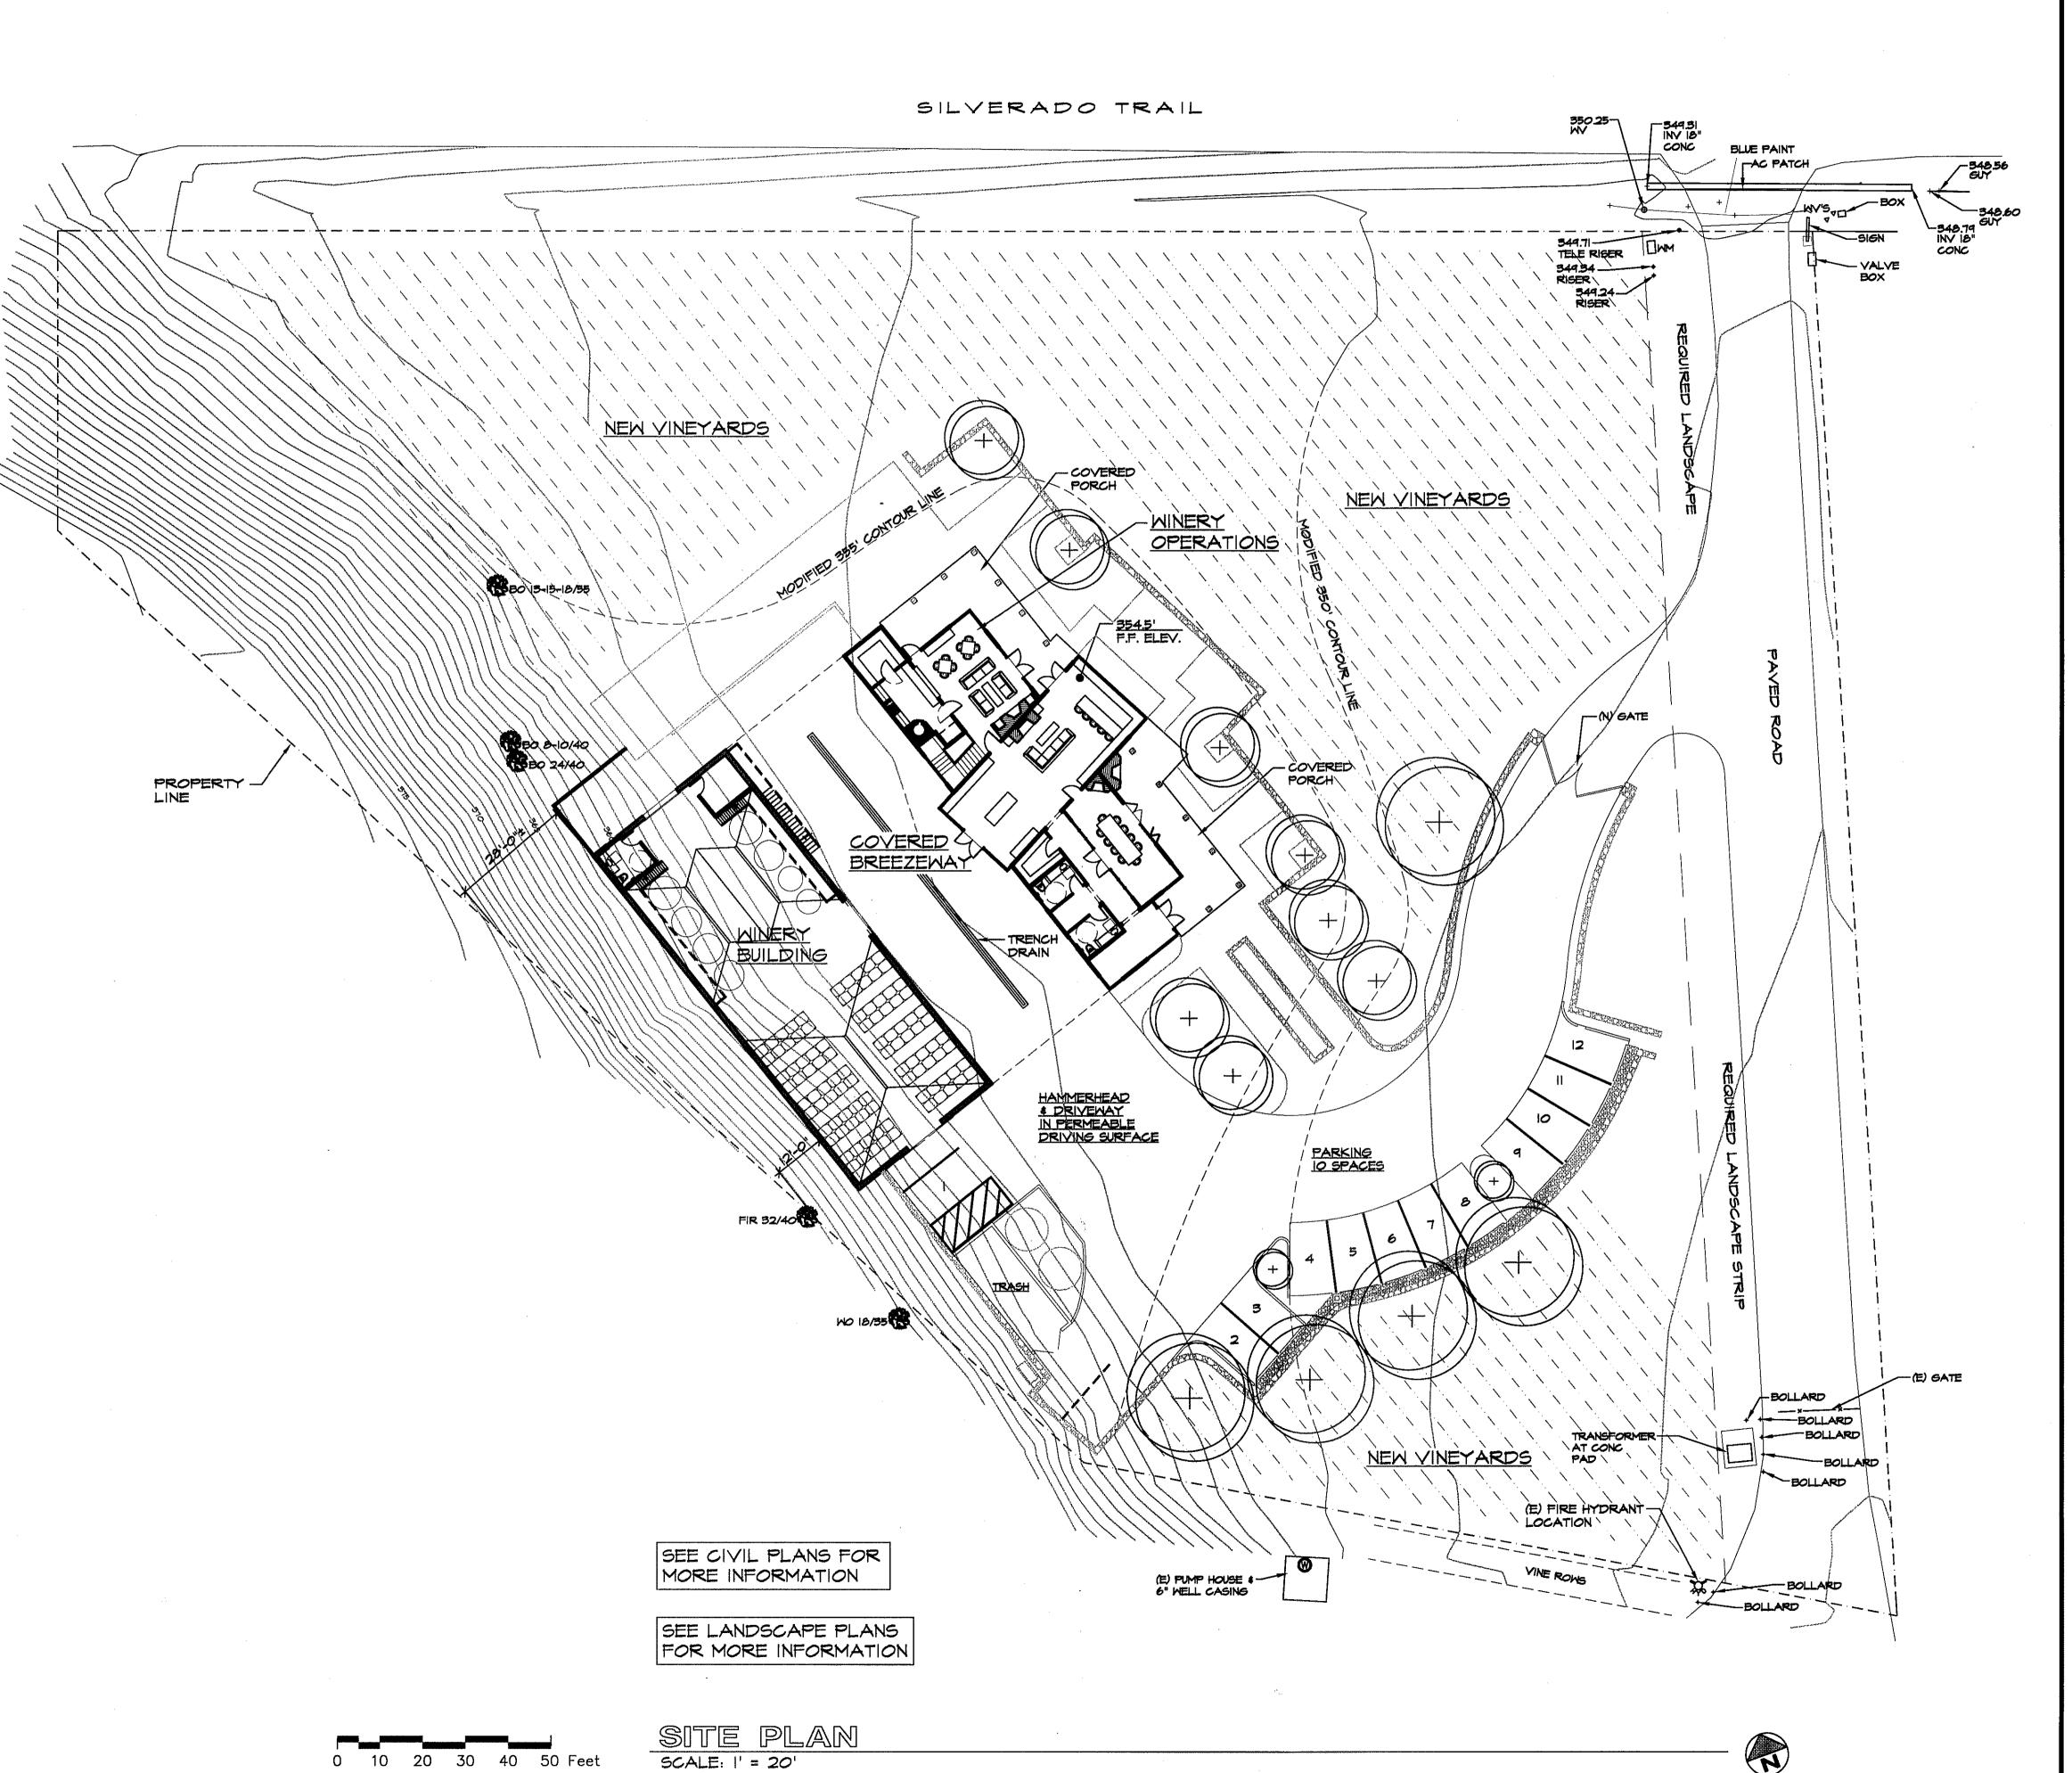


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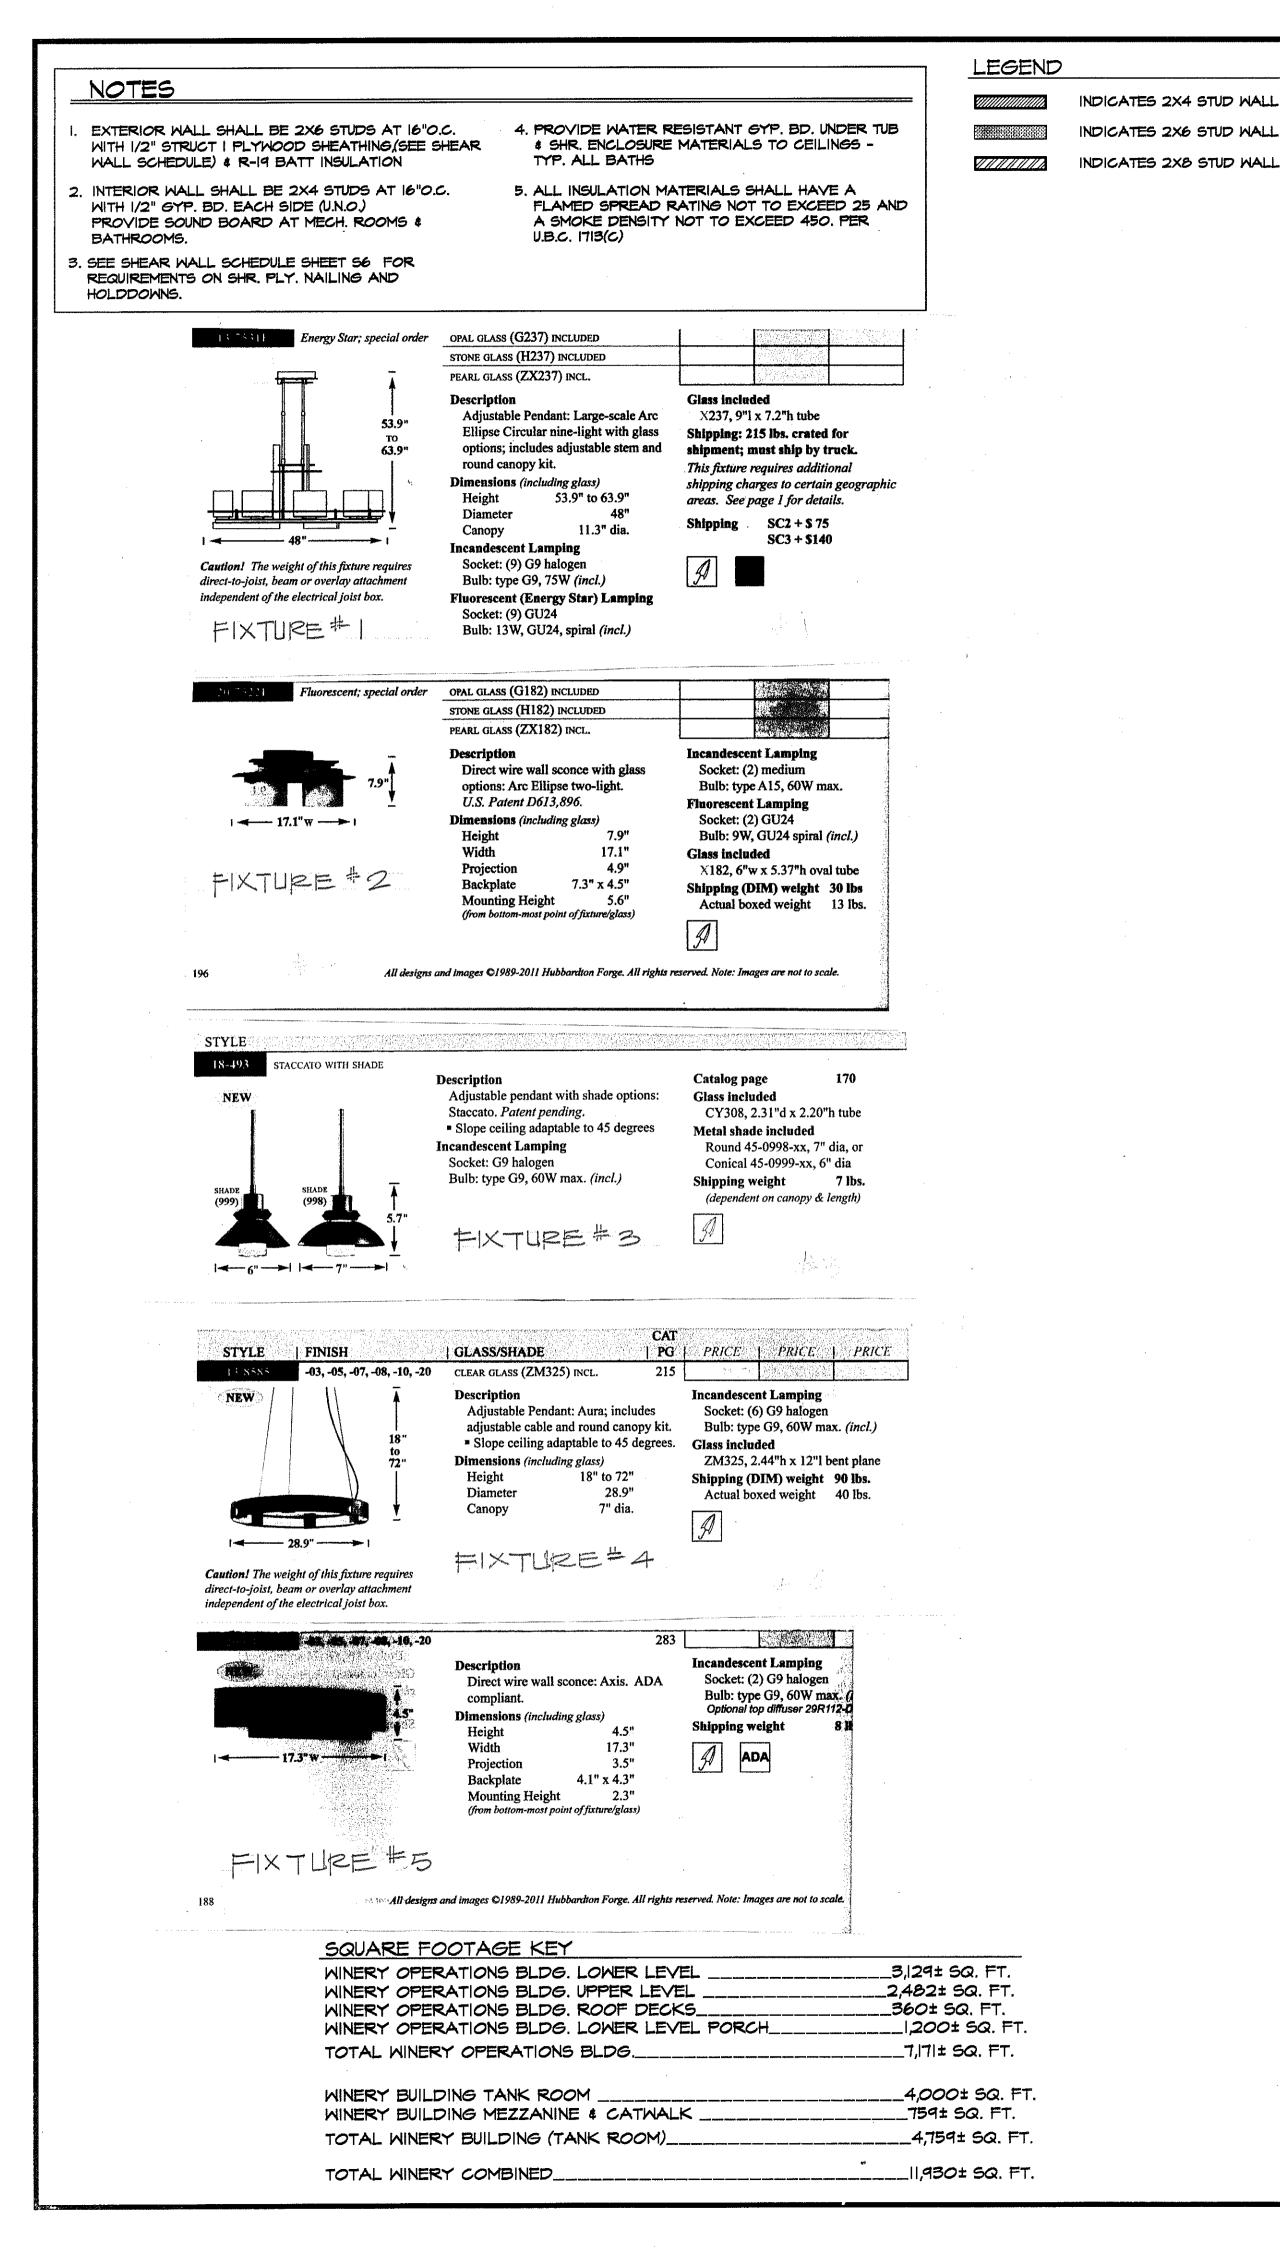


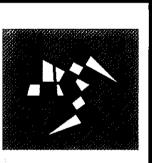
SITE PLAN


SCALE: AS SHOWN DRAWN BY:

D. JOHNSON FROJECT: BRIAN ARDEN WINERY



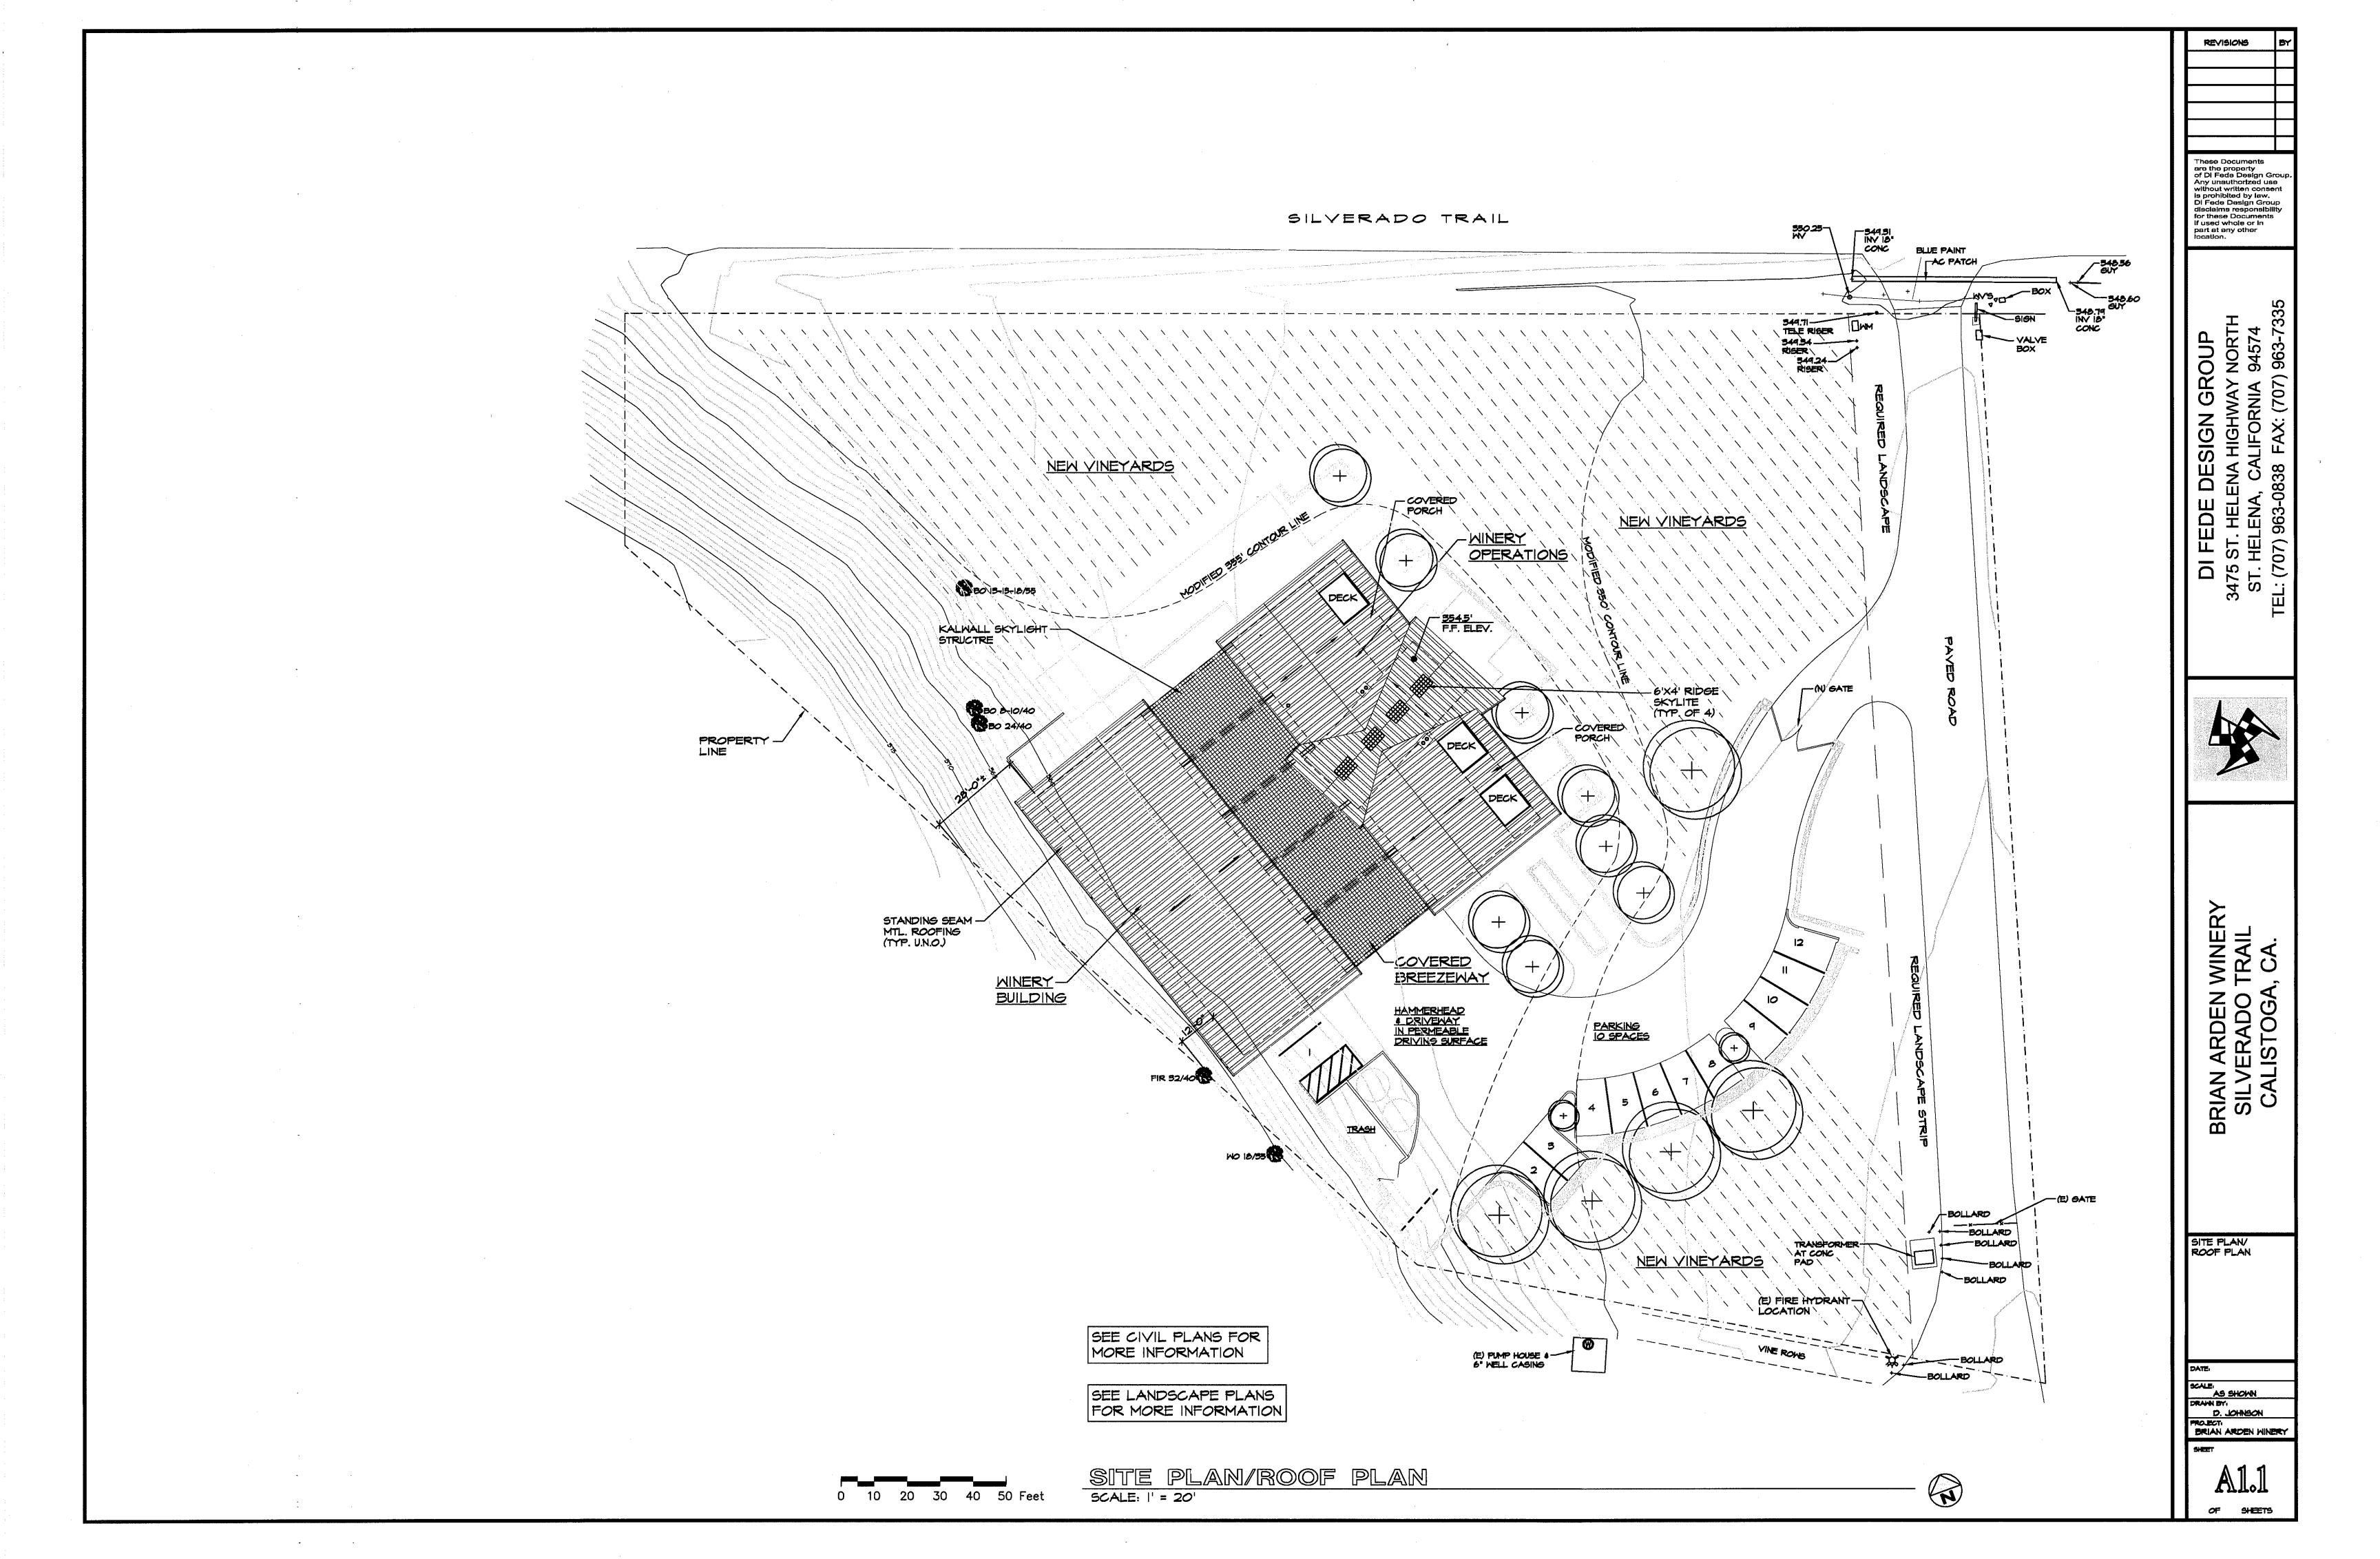

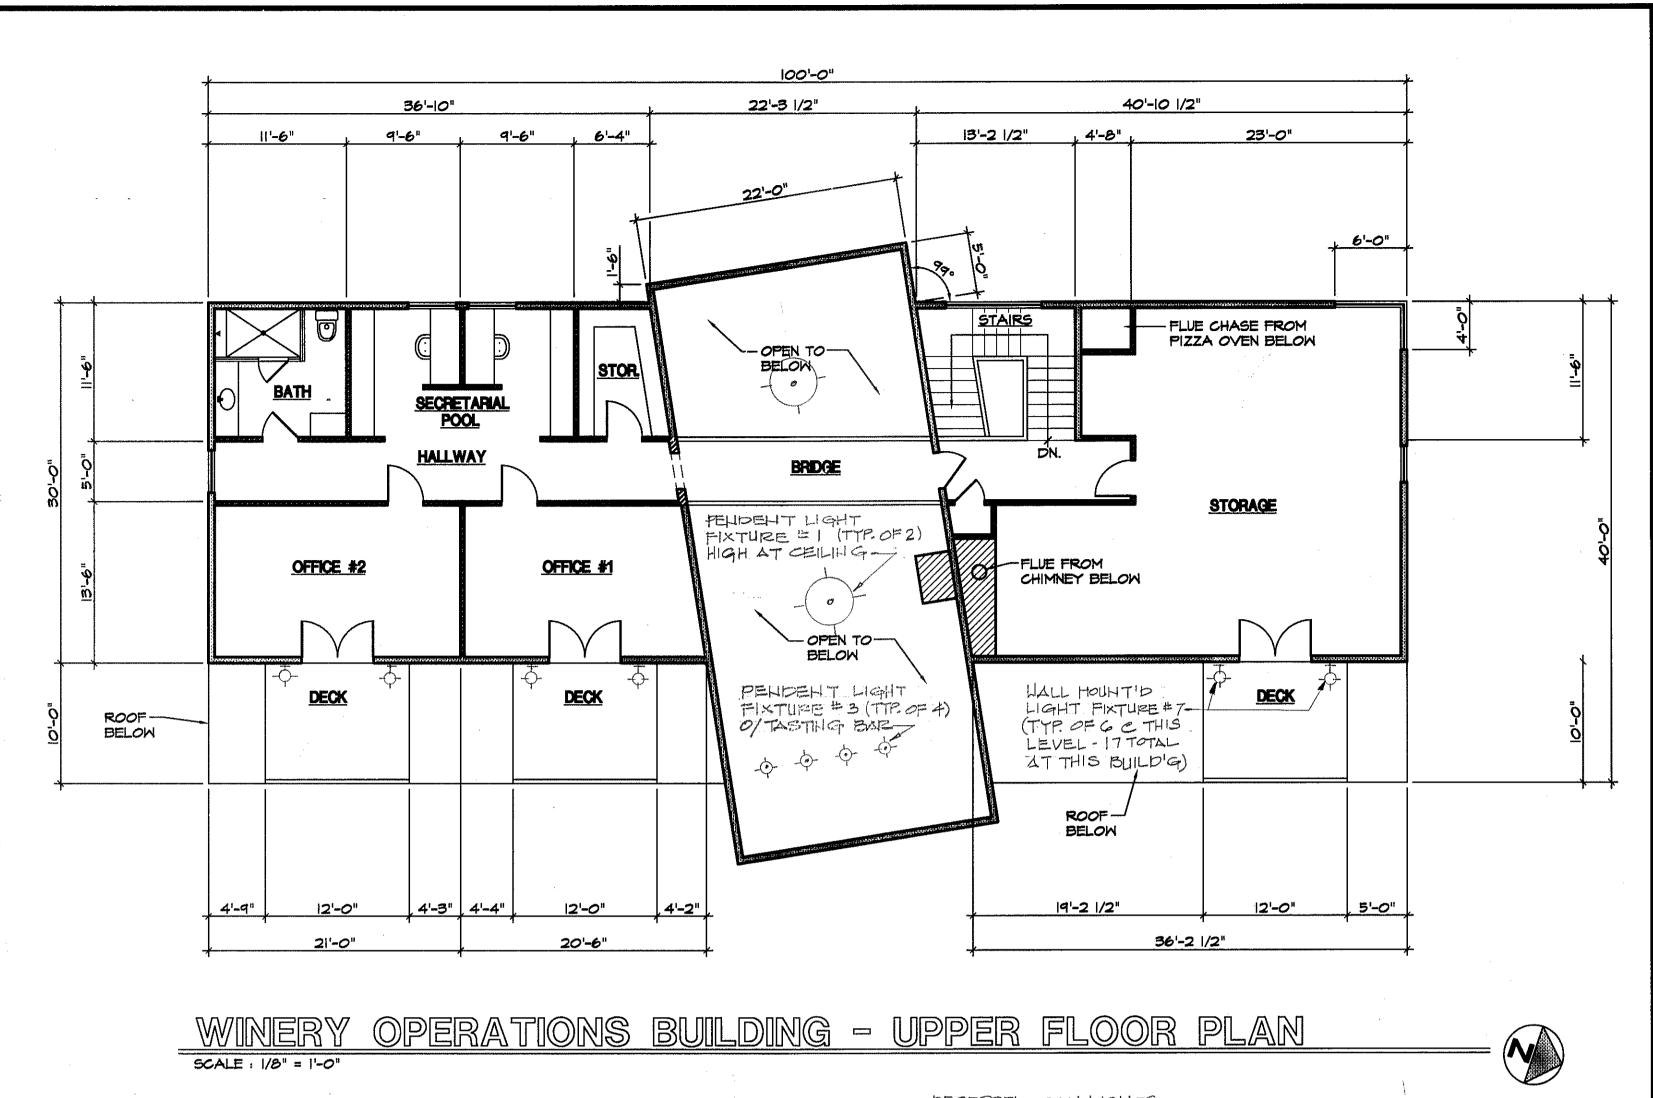

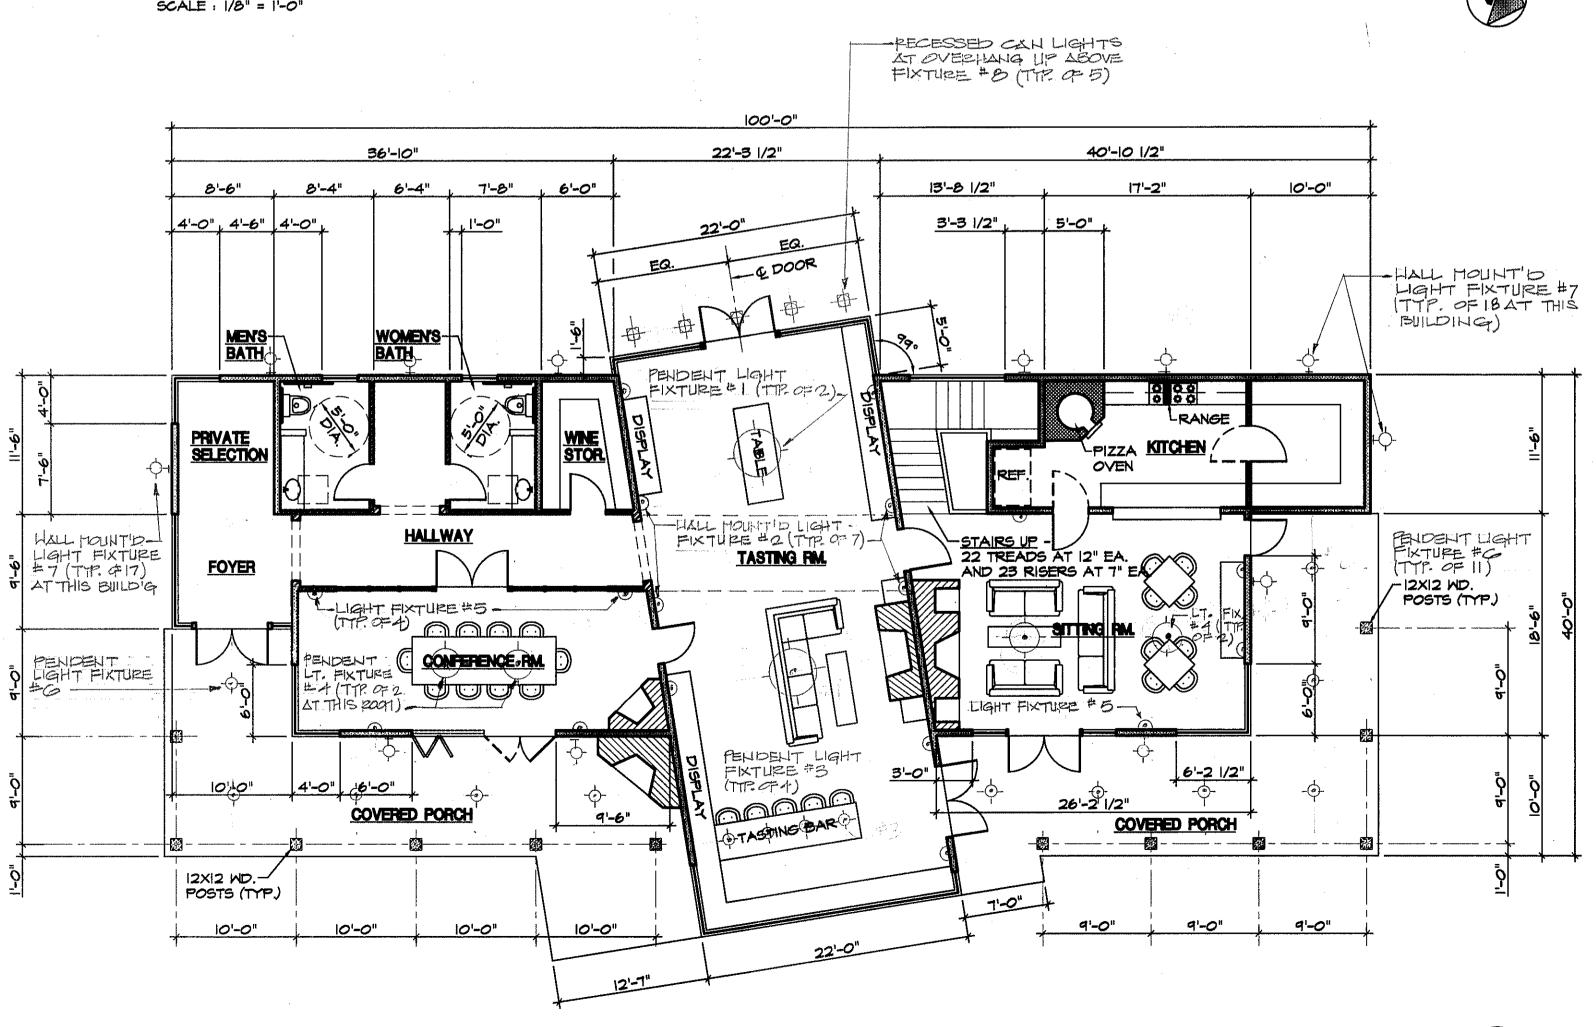

<u>WINERY OPERATIONS BUILDING - LOWER LEVEL FLOOR PLAN</u>

SCALE : 1/8" = 1'-0"

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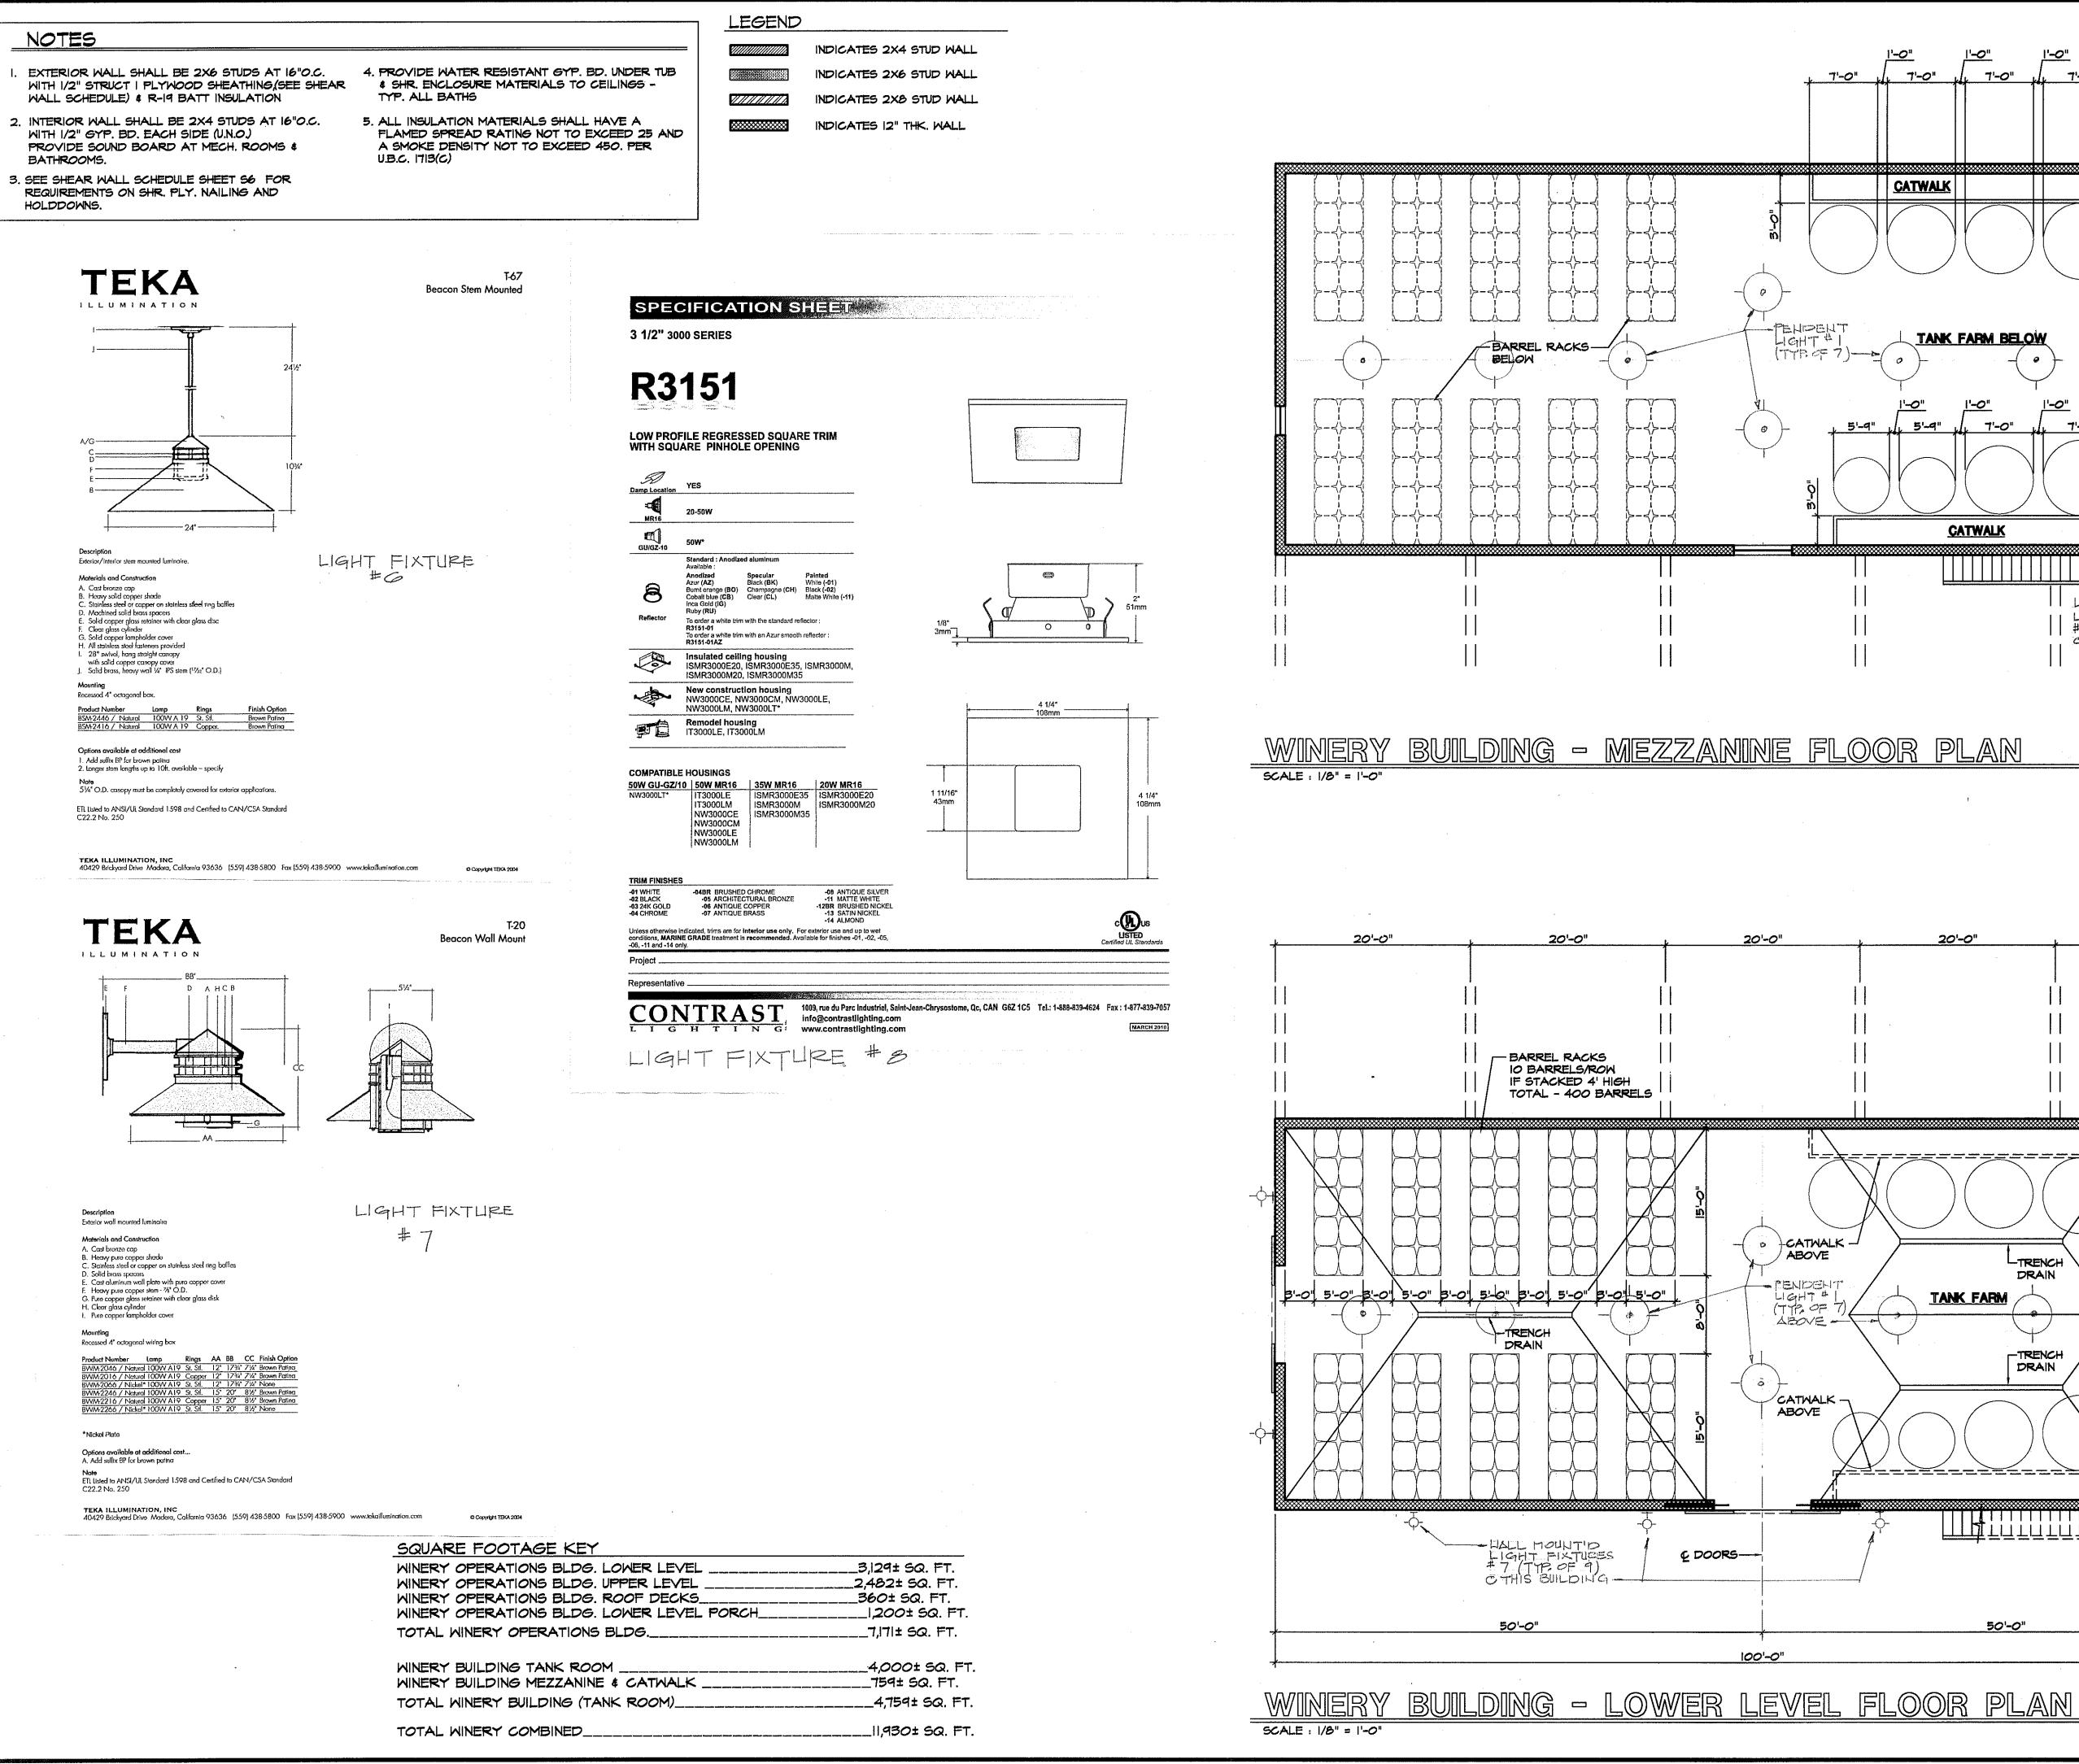
347 S


BRIAN ARDEN WINERY SILVERADO TRAIL CALISTOGA, CA.


MINERY OPERATIONS BLDG. LOWER LEVEL & UPPER LEVEL FLOOR PLANS

DATE:
SCALE,
AS SHOWN
DRAWN BY:
D. JOHNSON
FROJECT:
BRIAN ARDEN WINERY

A2



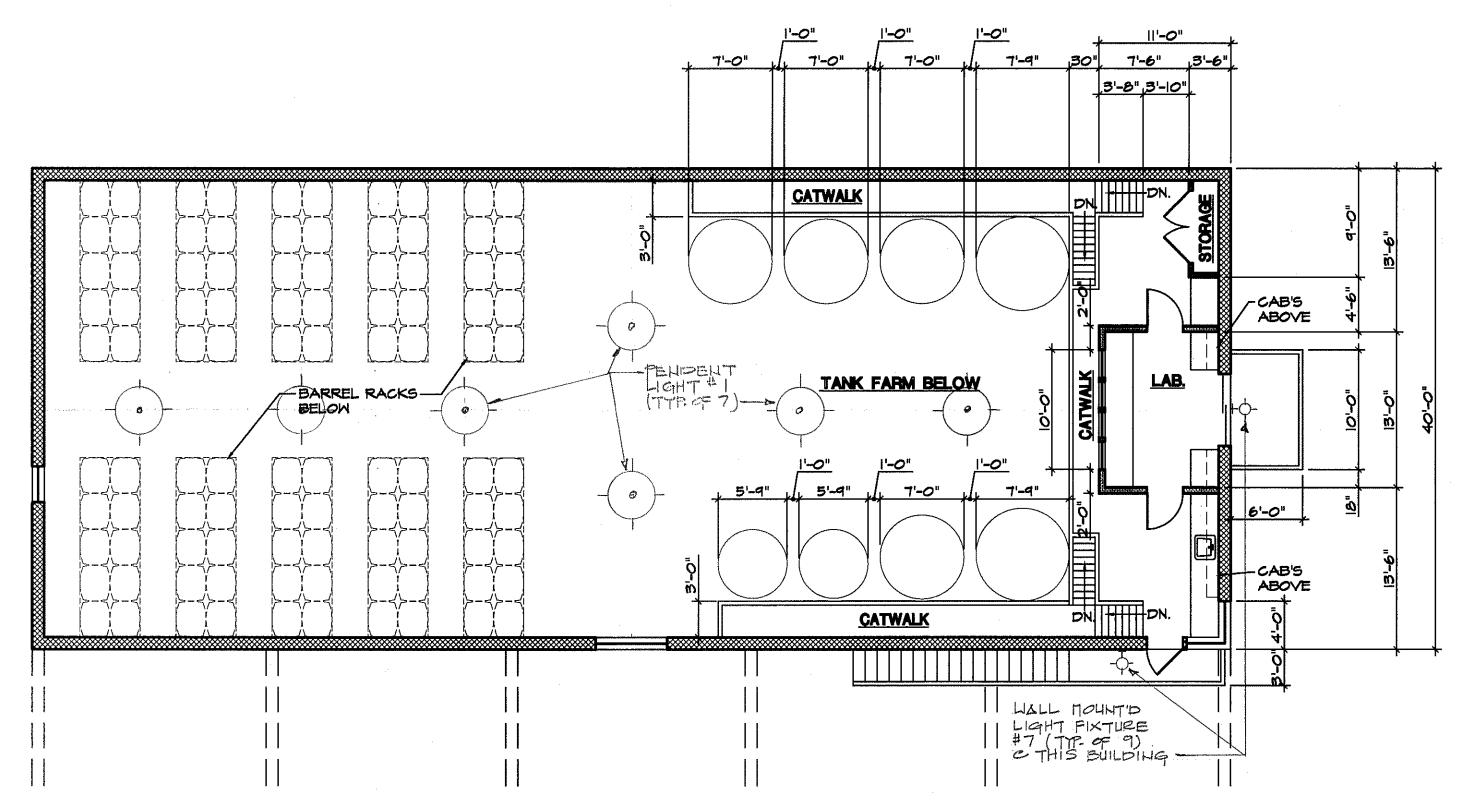

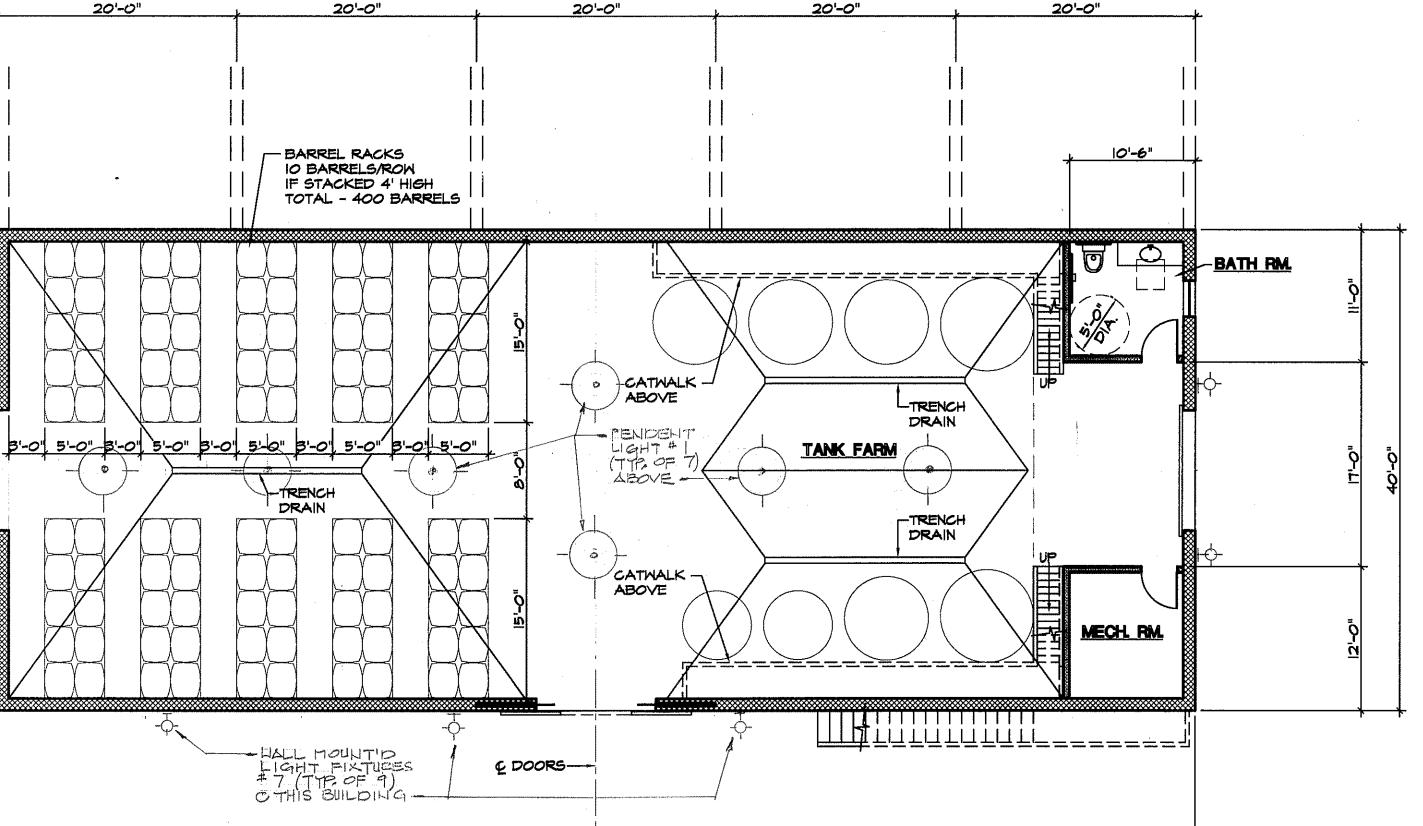

100'-0"



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WINERY TRAIL A, CA.


BRIAN AF SILVER CALIST

MINERY BLDG. LOWER LEVEL FLOOR PLAN/ MEZZANINE LEVEL FLOOR PLAN

AS SHOWN


D. JOHNSON BRIAN ARDEN WINERY


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3475 ST. HELENA HIGHWAY NORTH
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TEL: (707) 963-0838 FAV. / 70.

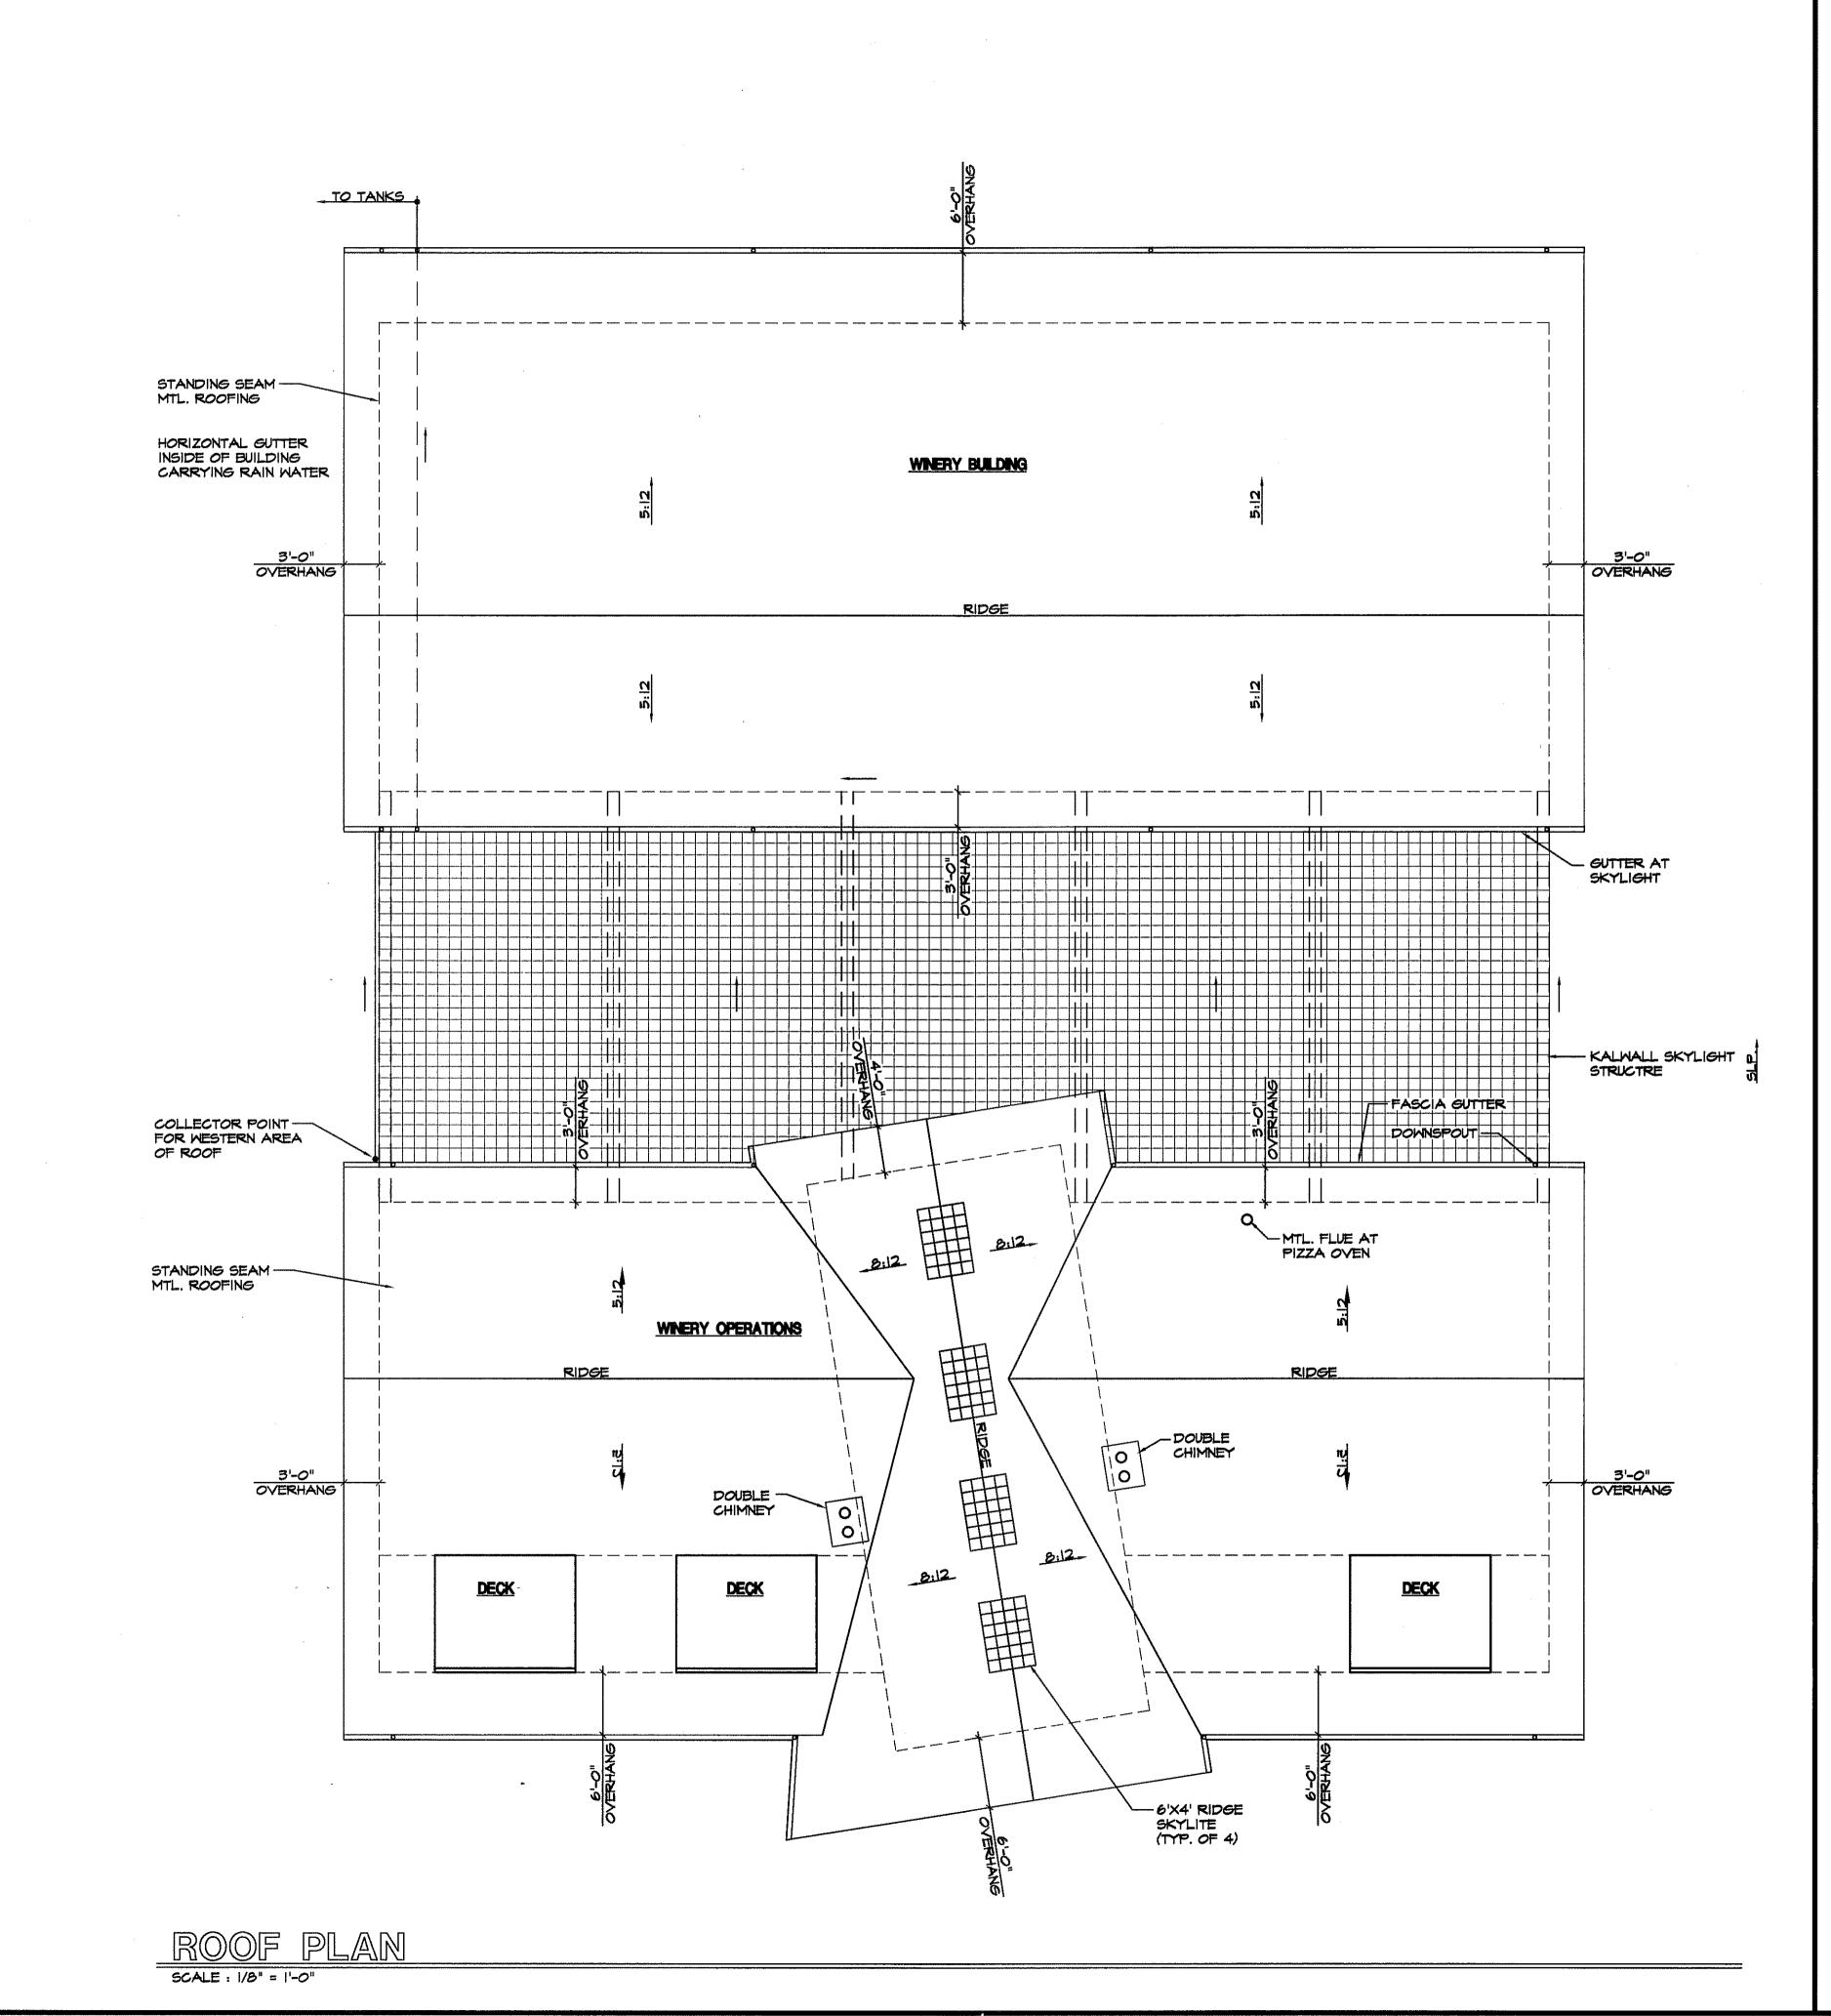





BRIAN ARDEN WINERY SILVERADO TRAIL CALISTOGA, CA.

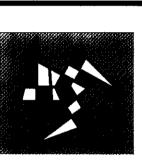
MINERY BLDG. ROOF PLANS

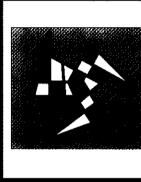SCALE,
AS SHOWN
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D. JOHNSON
FROJECT:
BRIAN ARDEN WINERY

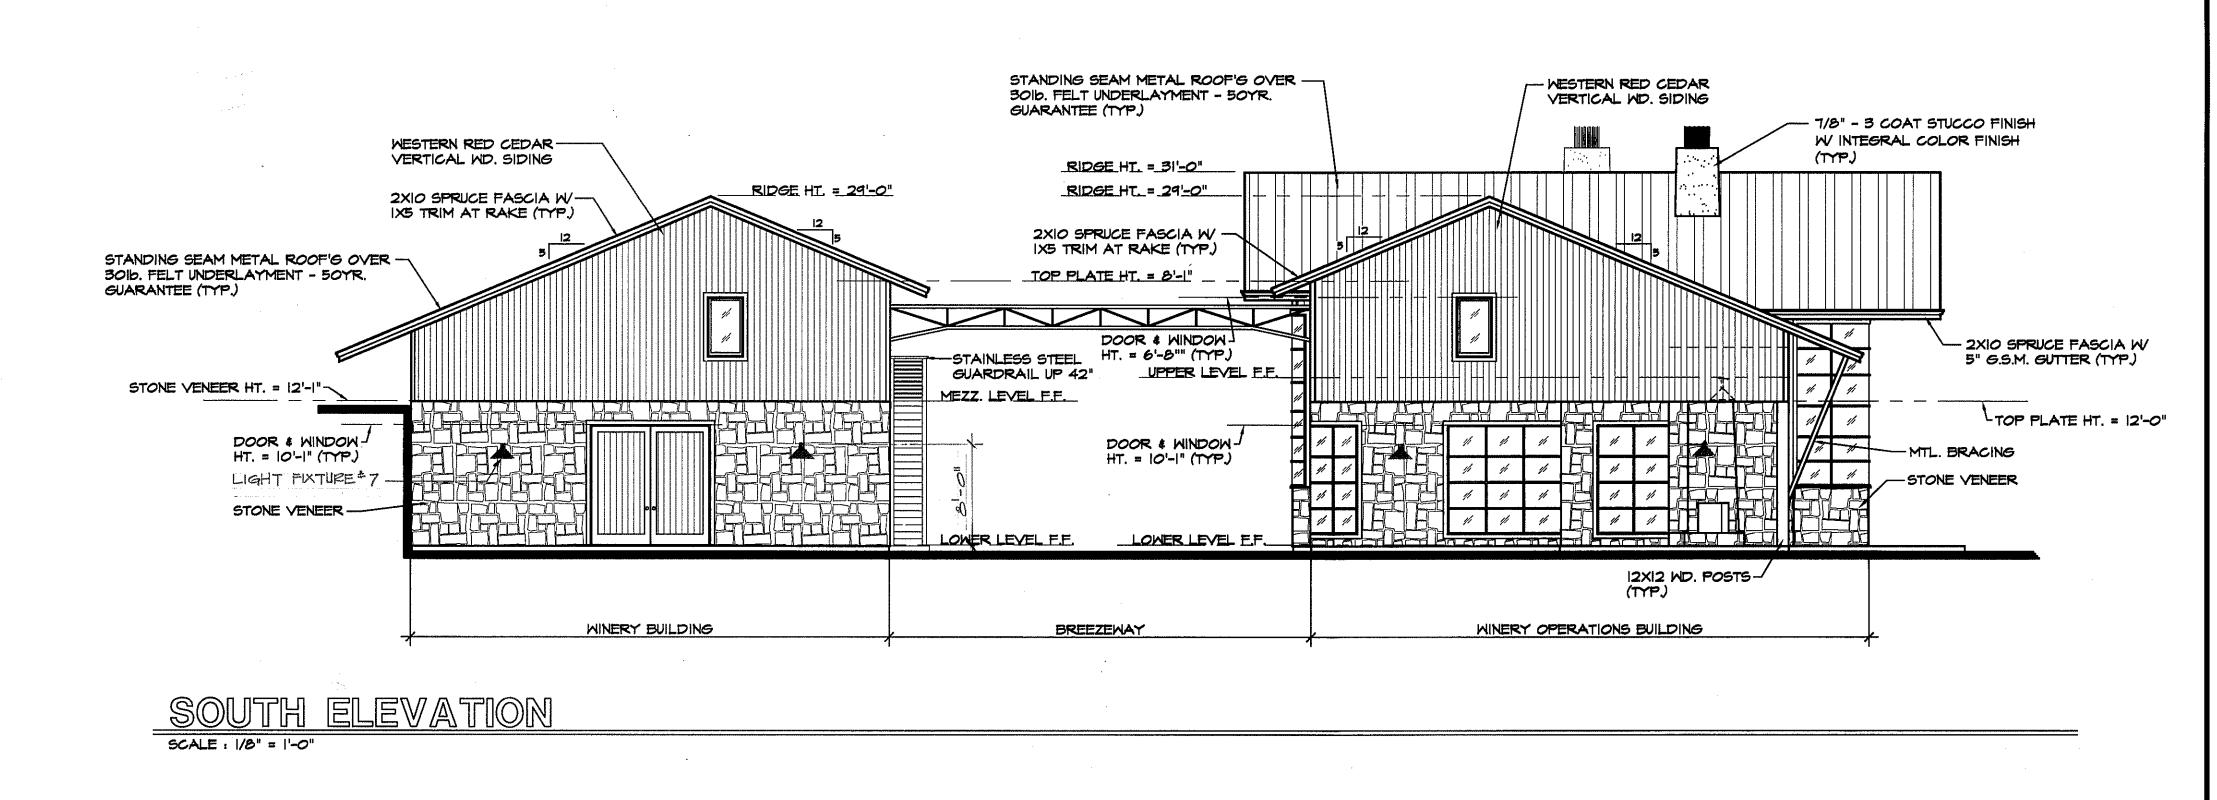


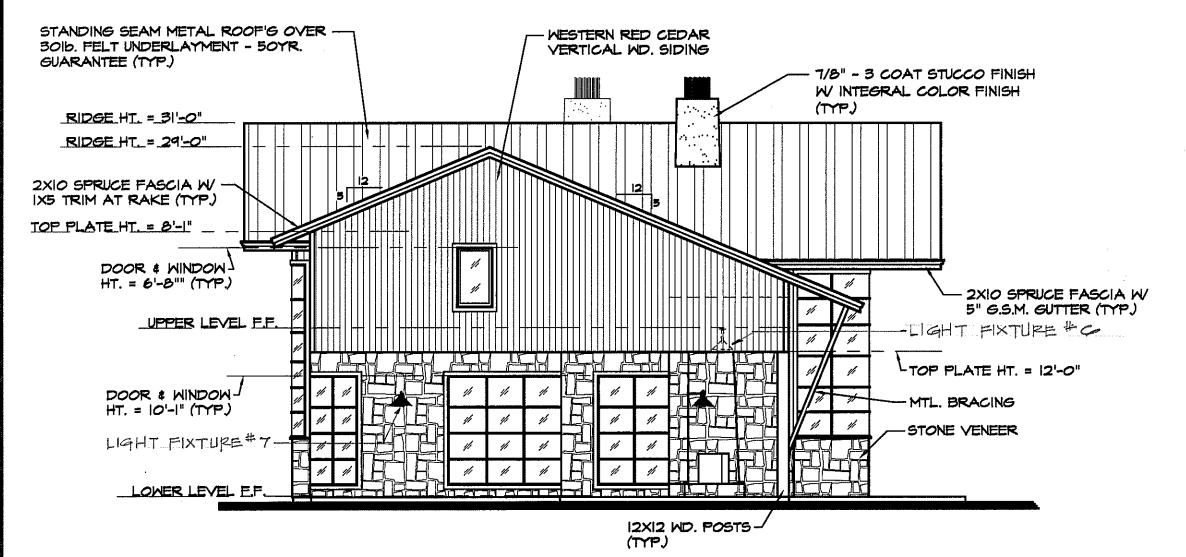


SOUTH ELEVATION - WINERY OPERATIONS BUILDING

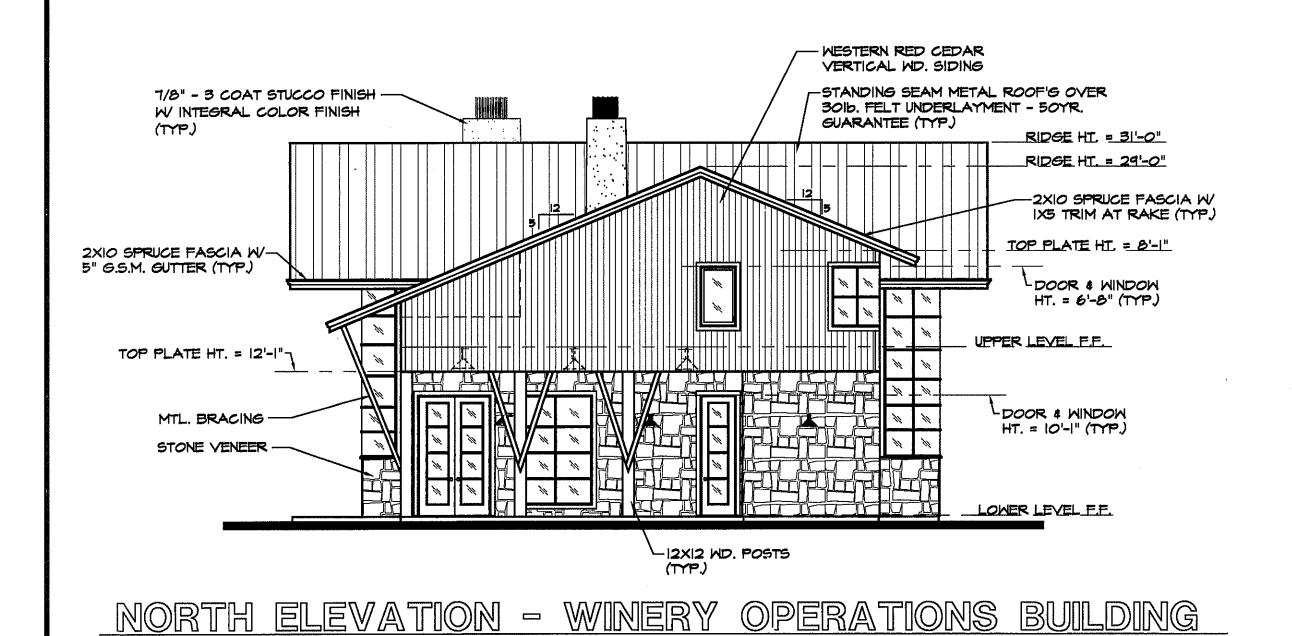

SCALE : 1/8" = 1'-0"

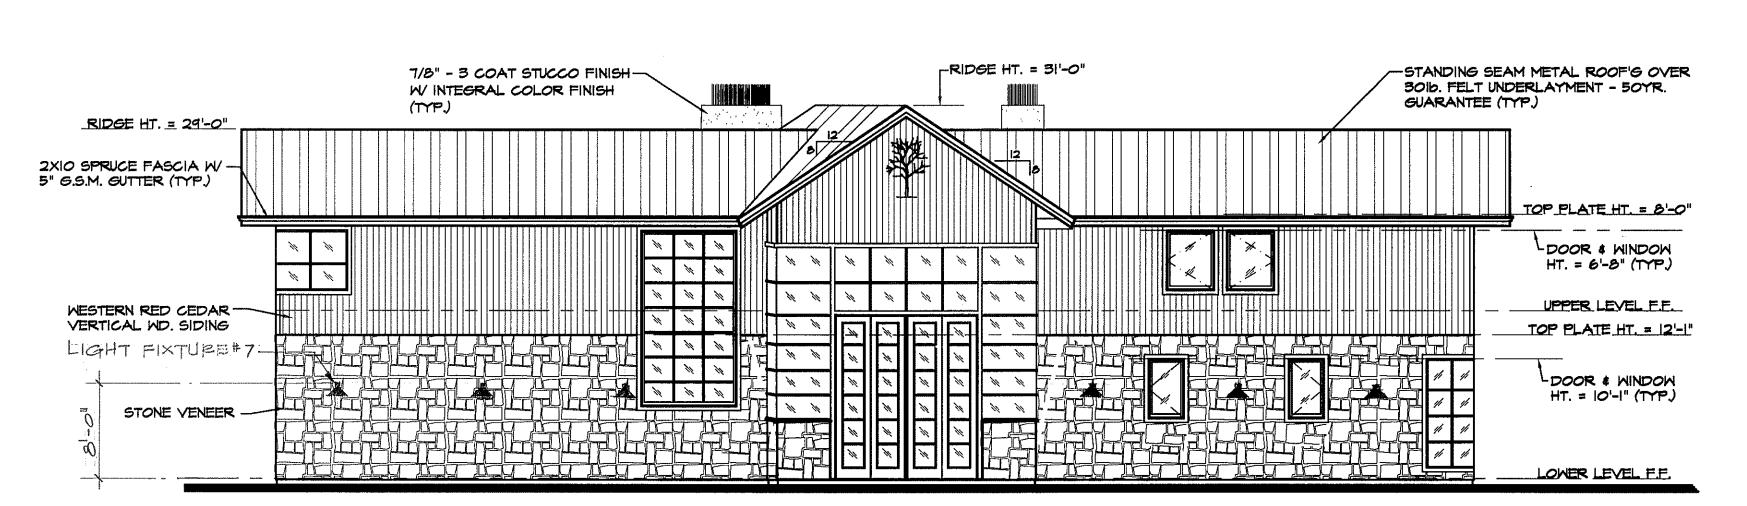

<u> WEST ELEVATION - WINERY OPERATIONS BUILDING</u>

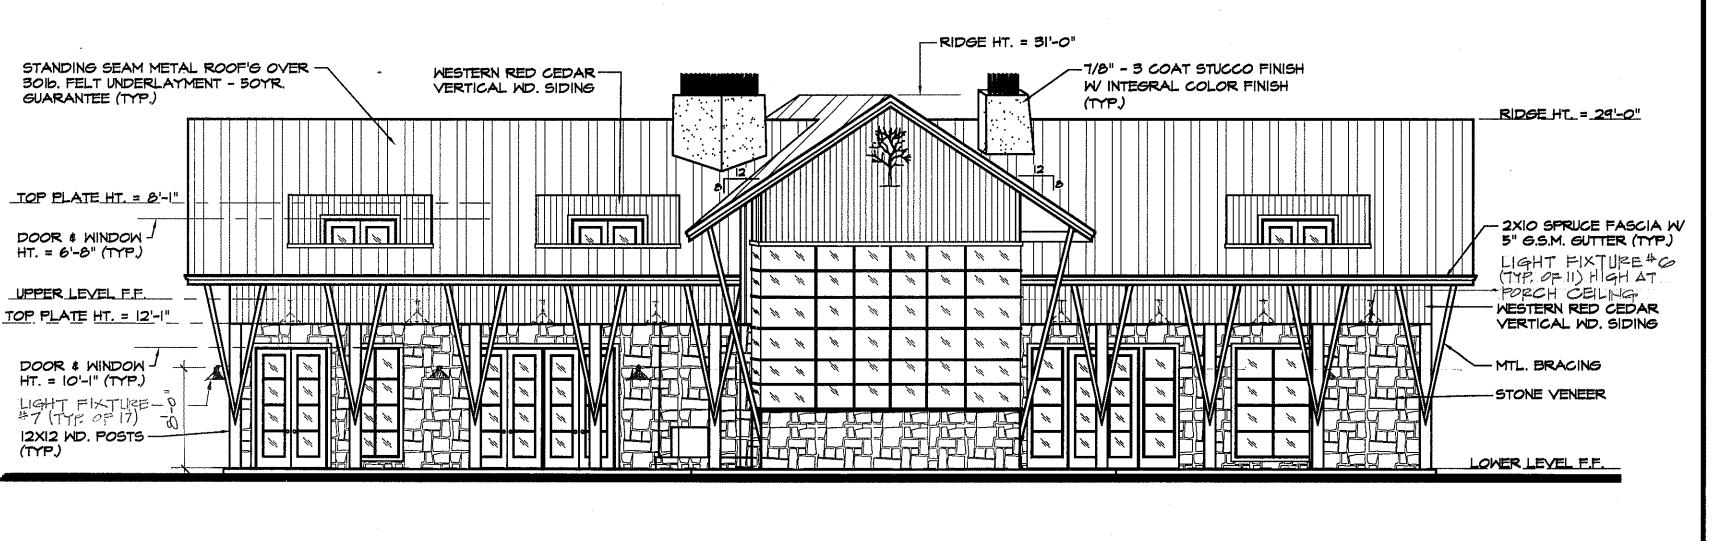


EAST ELEVATION - WINERY OPERATIONS BUILDING SCALE : 1/8" = 1'-0"

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SIGN DE DI FEDE 75 T.



BRIAN ARDEN WINERY SILVERADO TRAIL CALISTOGA, CA.

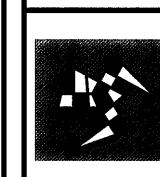MINERY OPERATIONS BLDG. EXTERIOR ELEVATIONS

SCALE: AS SHOWN DRAWN BY: D. JOHNSON BRIAN ARDEN WINERS

- WESTERN RED CEDAR VERTICAL MD. SIDING -STANDING SEAM METAL ROOF'G OVER 301b. FELT UNDERLAYMENT - 50YR. 7/8" - 3 COAT STUCCO FINISH — W INTEGRAL COLOR FINISH GUARANTEE (TYP.) (TYP) RIDGE HT. = 31'-0" RIDGE HT. = 29'-0" RIDGE HT = 29'-0" 2XIO SPRUCE FASCIA W-IX5 TRIM AT RAKE (TYP.) WESTERN RED CEDAR-VERTICAL WD. SIDING - STANDING SEAM METAL ROOF'G OVER 301b. FELT UNDERLAYMENT - 50YR. GUARANTEE (TYP.) 2XIO SPRUCE FASCIA W/-5" G.S.M. GUTTER (TYP.) HT. = 8'-8" (TYP.) TOP PLATE HT. = 6'-1" LIGHT FIXTUPE # 6 STAINLESS STEEL-BEHIND. GUARDRAIL UP 42" TOP PLATE HT. = 12'-1"-TOP PLATE HT. = 12'-1" MEZZ. LEVEL F.F. LDOOR & WINDOW MTL. BRACING -HT. = 10'-1" (TYP)L DOOR & WINDOW STONE VENEER -HT. = &'-I" (THIS DOOR ONLY) -STONE VENEER -12XI2 ND. POSTS WINERY OPERATIONS BUILDING NORTH ELEVATION SCALE: 1/8" = 1'-0" STANDING SEAM METAL ROOF'G OVER 301b. FELT UNDERLAYMENT - 50YR. GUARANTEE (TYP.) RIDGE HT. = 29'-0" -2XIO SPRUCE FASCIA W/ IX5 TRIM AT RAKE (TYP.) 2XIO SPRUCE FASCIA W STANDING SEAM METAL ROOF'S OVER 5" G.S.M. GUTTER (TYP.) 301b. FELT UNDERLAYMENT - 50YR. TOP PLATE HT. = II'-I" GUARANTEE (TYP.) 11 11 LDOOR & WINDOW WESTERN RED CEDAR -HT. = 8'-8" (TYP) TOP PLATE HT. = 6'-1" VERTICAL MD. SIDING LIGHT FIXTURE#7 TOP STONE HT. = 12'-1"-LIGHT FIXTURE # 7-LDOOR & WINDOW HT. = 10'-1" (TYP.) L DOOR & WINDOW STONE VENEER HT. = 8'-1" (THIS DOOR ONLY) LOWER LEVEL F.F. -STONE VENEER NORTH ELEVATION - WINERY BUILDING EAST ELEVATION - WINERY BUILDING STANDING SEAM METAL ROOF'G OVER — SOID. FELT UNDERLAYMENT - 50YR. GUARANTEE (TYP.) RIDGE HT. = 29'-0" RIDGE HT. = 29'-0" WESTERN RED CEDAR VERTICAL WD. SIDING - 2XIO SPRUCE FASCIA W 5" G.S.M. GUTTER (TYP.) TOP PLATE HT = 8'-1" TOP PLATE HT. = 6'-1" -STAINLESS STEEL **GUARDRAIL UP 42"** TOP OF STONE HT. = 12'-1" MEZZ. LEVEL F.F. FIXTURE 47 LOWER LEVEL F.E LOWER LEVEL F.E. SOUTH ELEVATION - WINERY BUILDING WEST ELEVATION - WINERY BUILDING SCALE : 1/8" = 1'-0"

WESTERN RED CEDAR -

VERTICAL ND. SIDING

DOOR # WINDOW -HT. = 8'-8" (TYP.)

STANDING SEAM METAL ROOF'S OVER -3016. FELT UNDERLAYMENT - 50YR.

TOP PLATE HI. = 6'-1

DOOR & WINDOW ! HT. = 10'-1" (TYP.)

STONE VENEER ---

TOP PLATE HT. = 12'-1"

GUARANTEE (TYP.)

SCALE : 1/8" = 1'-0"

SCALE : 1/8" = 1'-0"

STAINLESS STEEL-

MEZZ. LEVEL F.F.

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FEDE

3475 ST ST. HE EL: (707)


I WINERY TRAIL A, CA.


BRIAN ARDEN V SILVERADO T CALISTOGA,

AS SHOWN D. JOHNSON PROJECTI BRIAN ARDEN WINERY


<u>WINERY BLDG.</u> EXTERIOR ELEVATIONS

A3.1

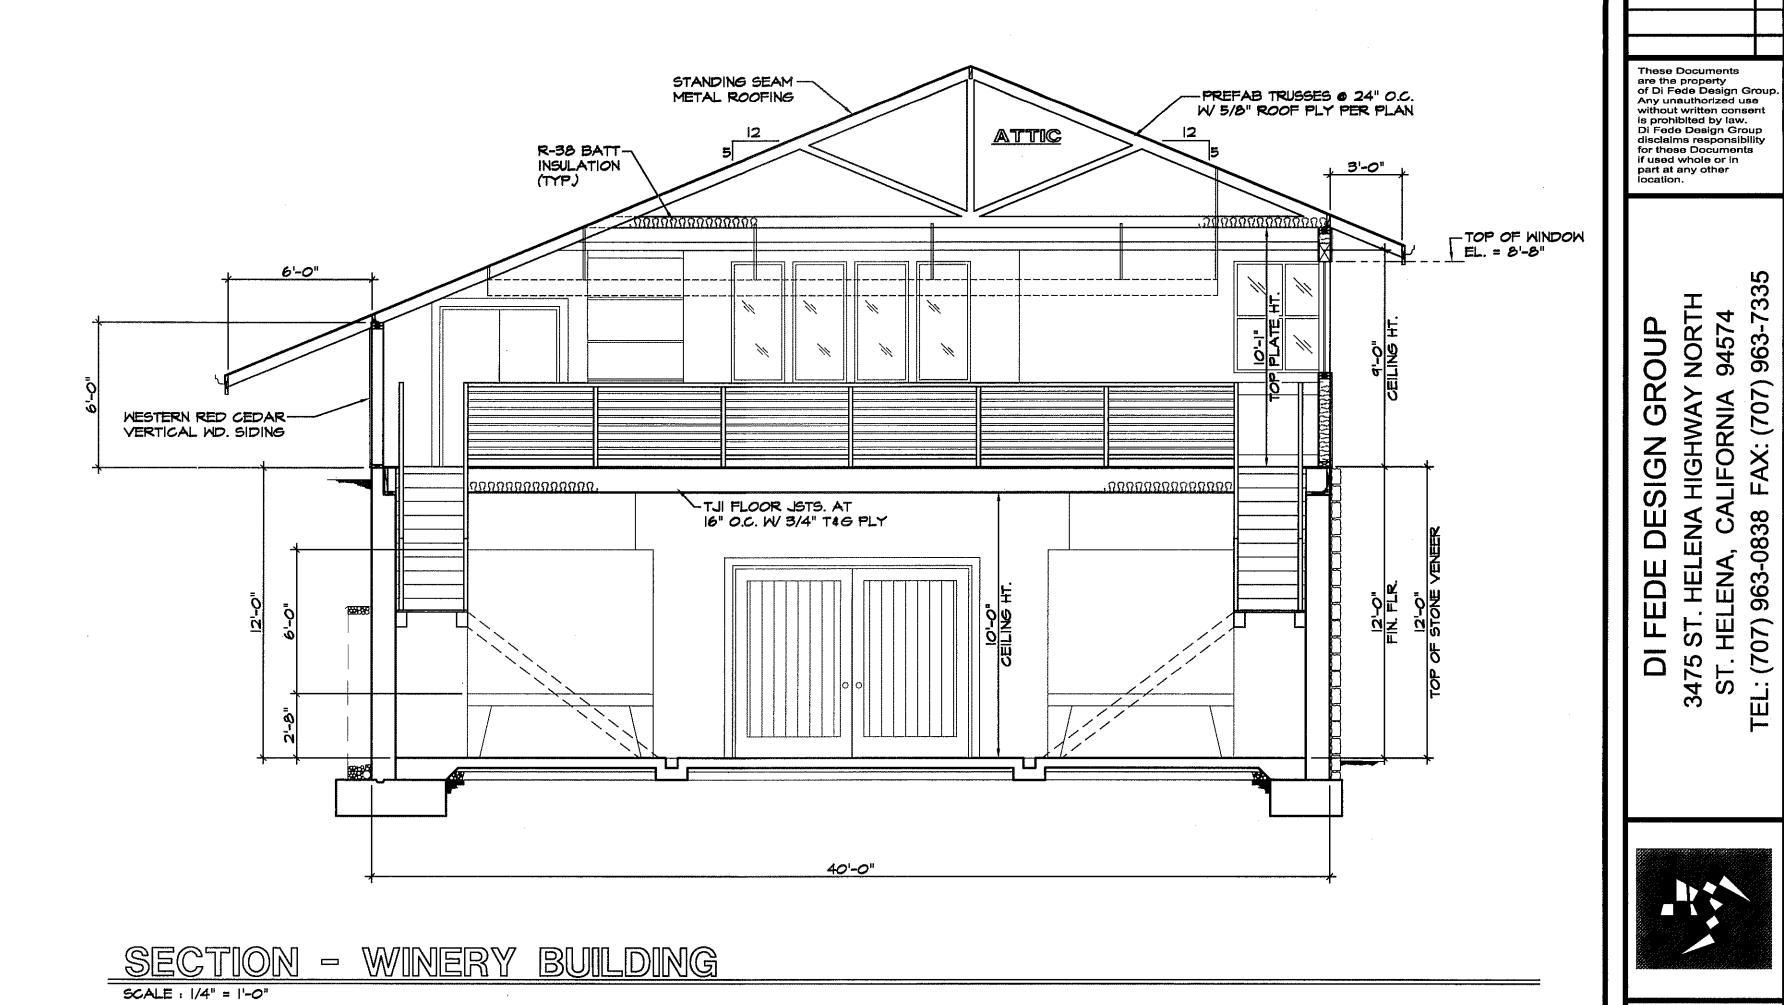

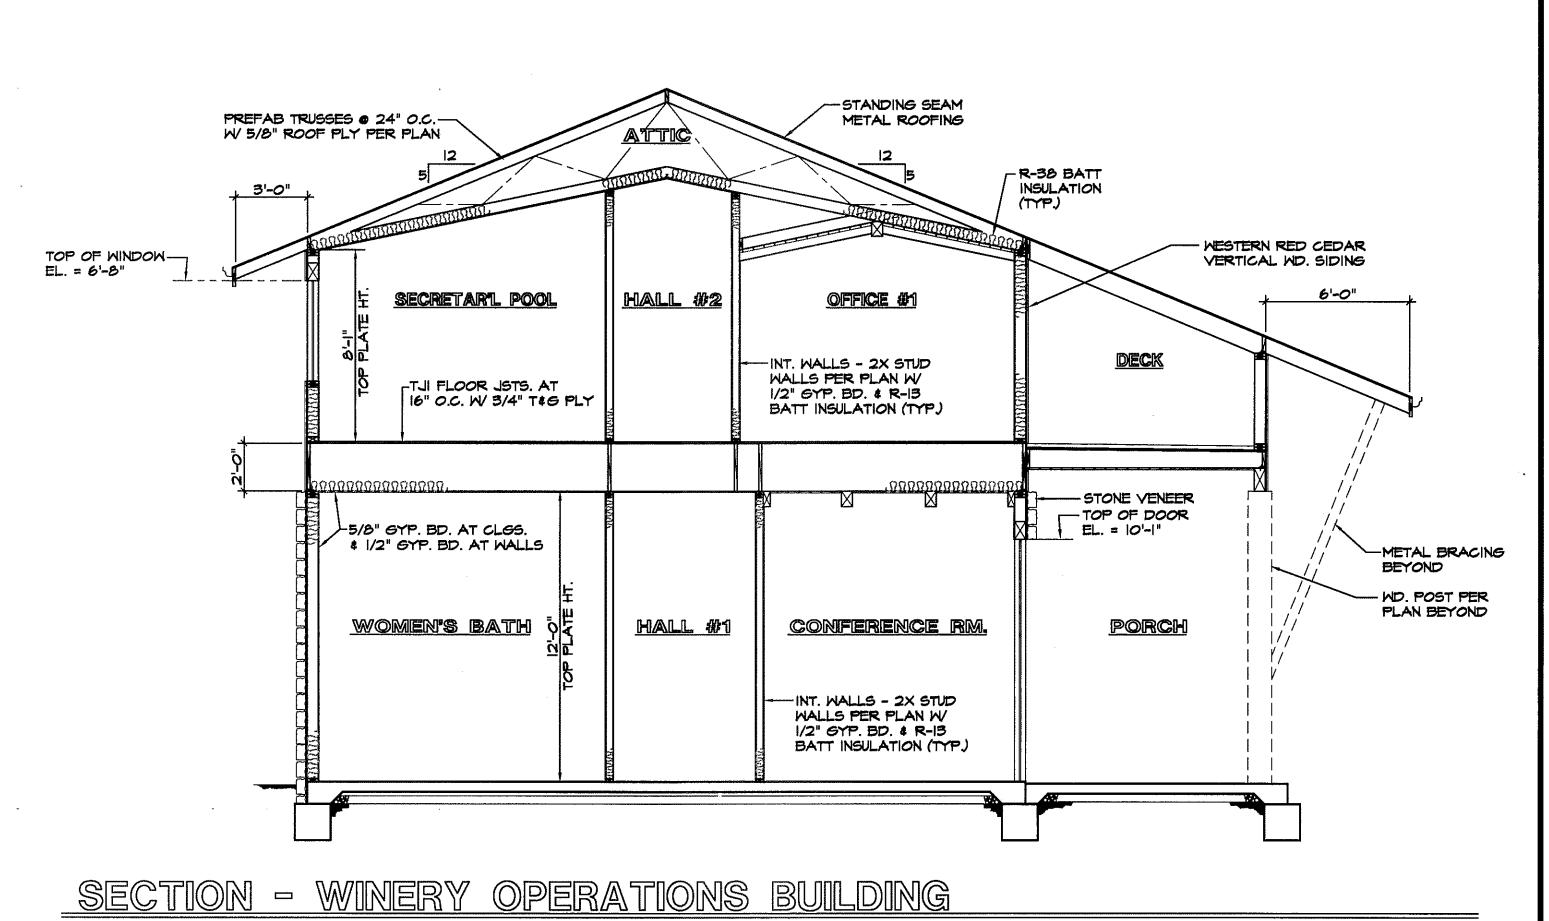

SCALE : 1/4" = 1'-0"

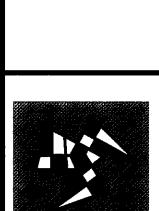

BRIAN ARDEN WINERY SILVERADO TRAIL CALISTOGA, CA.

CROSS SECTIONS

AS SHOWN DRAWN BY:

D. JOHNSON
PROJECT:
BRIAN ARDEN WINERY

# BRIAN ARDEN WINERY USE PERMIT PLAN

CALISTOGA CALIFORNIA



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EXISTING

WINERY

# LEGENDS

ABBREVIATIONS ASPHALT CONCRETE BACKFLOW PREVENTION DEVICE BENCHMARK BLACK OAK BACK OF SIDEWALK CENTERLINE CLASS CLEANOUT DROP INLET CONCRETE ELEVATION ELBOW EDGE OF PAVEMENT E×. EXIST. FEATURE FC FACE OF CURB FDC FIRE DEPT. CONNECTION FINISH GRADE FINISH FLOOR FIRE HYDRANT FLOW LINE GRADE BREAK HIGH POINT INVERT OF PIPE LIVE OAK NDS NDS DRAINAGE PRODUCTS 06 ORIGINAL GROUND PERF PERFORATED PIVPOST INDICATOR VALVE PROPERTY LINE PG&E PACIFIC GAS ELEC POWER POLE PUBLIC UTILITY ESMT PROCESSED WASTE RADIUS OR RADIUS PT. RCP REINFORCED CONCRETE PIPE R/WPUBLIC RIGHT OF WAY SLOPE (FOOT/FOOT) SBD SUBDRAIN SD STORM DRAIN SANITARY SEWER 55 STD STANDARD S/W SIDEWALK TOP OF CURB

TOP OF ROCK (CHIP SEAL)


TYPICAL


WATER METER

TR

TYP

MM

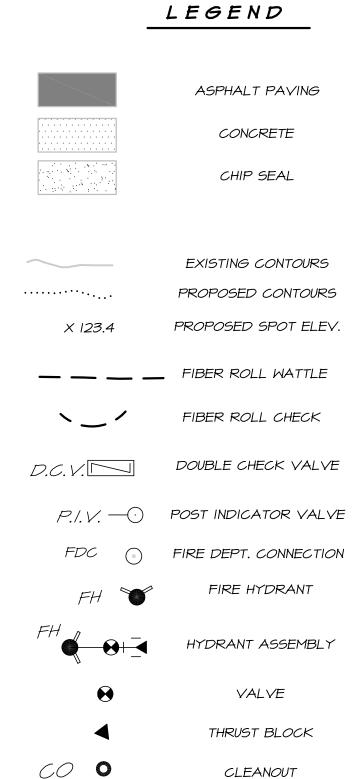

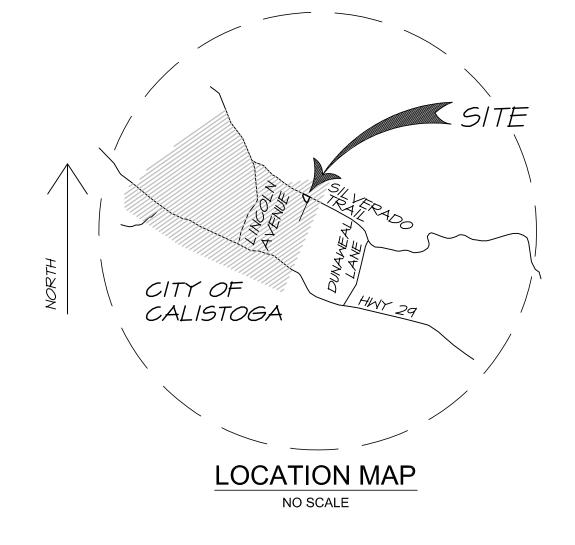

NOTES

**OWNERS:** 

**BURT HARLAN BRIAN HARLAN** 

SITE ADDRESS: SILVERADO TRAIL

CALISTOGA, CA

**EXISTING USE:** VACANT

PROPOSED USE: WINERY

WATER:

CITY OF CALISTOGA

SEWER:

CITY OF CALISTOGA

INDEX

# SHEET NO DESCRIPTION

COVER SHEET

SITE PLAN


GRADING PLAN

UTILITY PLAN

UTILITY SOUTH & DETAILS

DETAILS

DETAILS

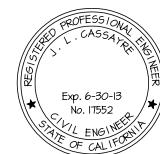

JAMES L. CASSAYRE ENGINEER

3142 BROWNS VALLEY RD. NAPA, CA 94558


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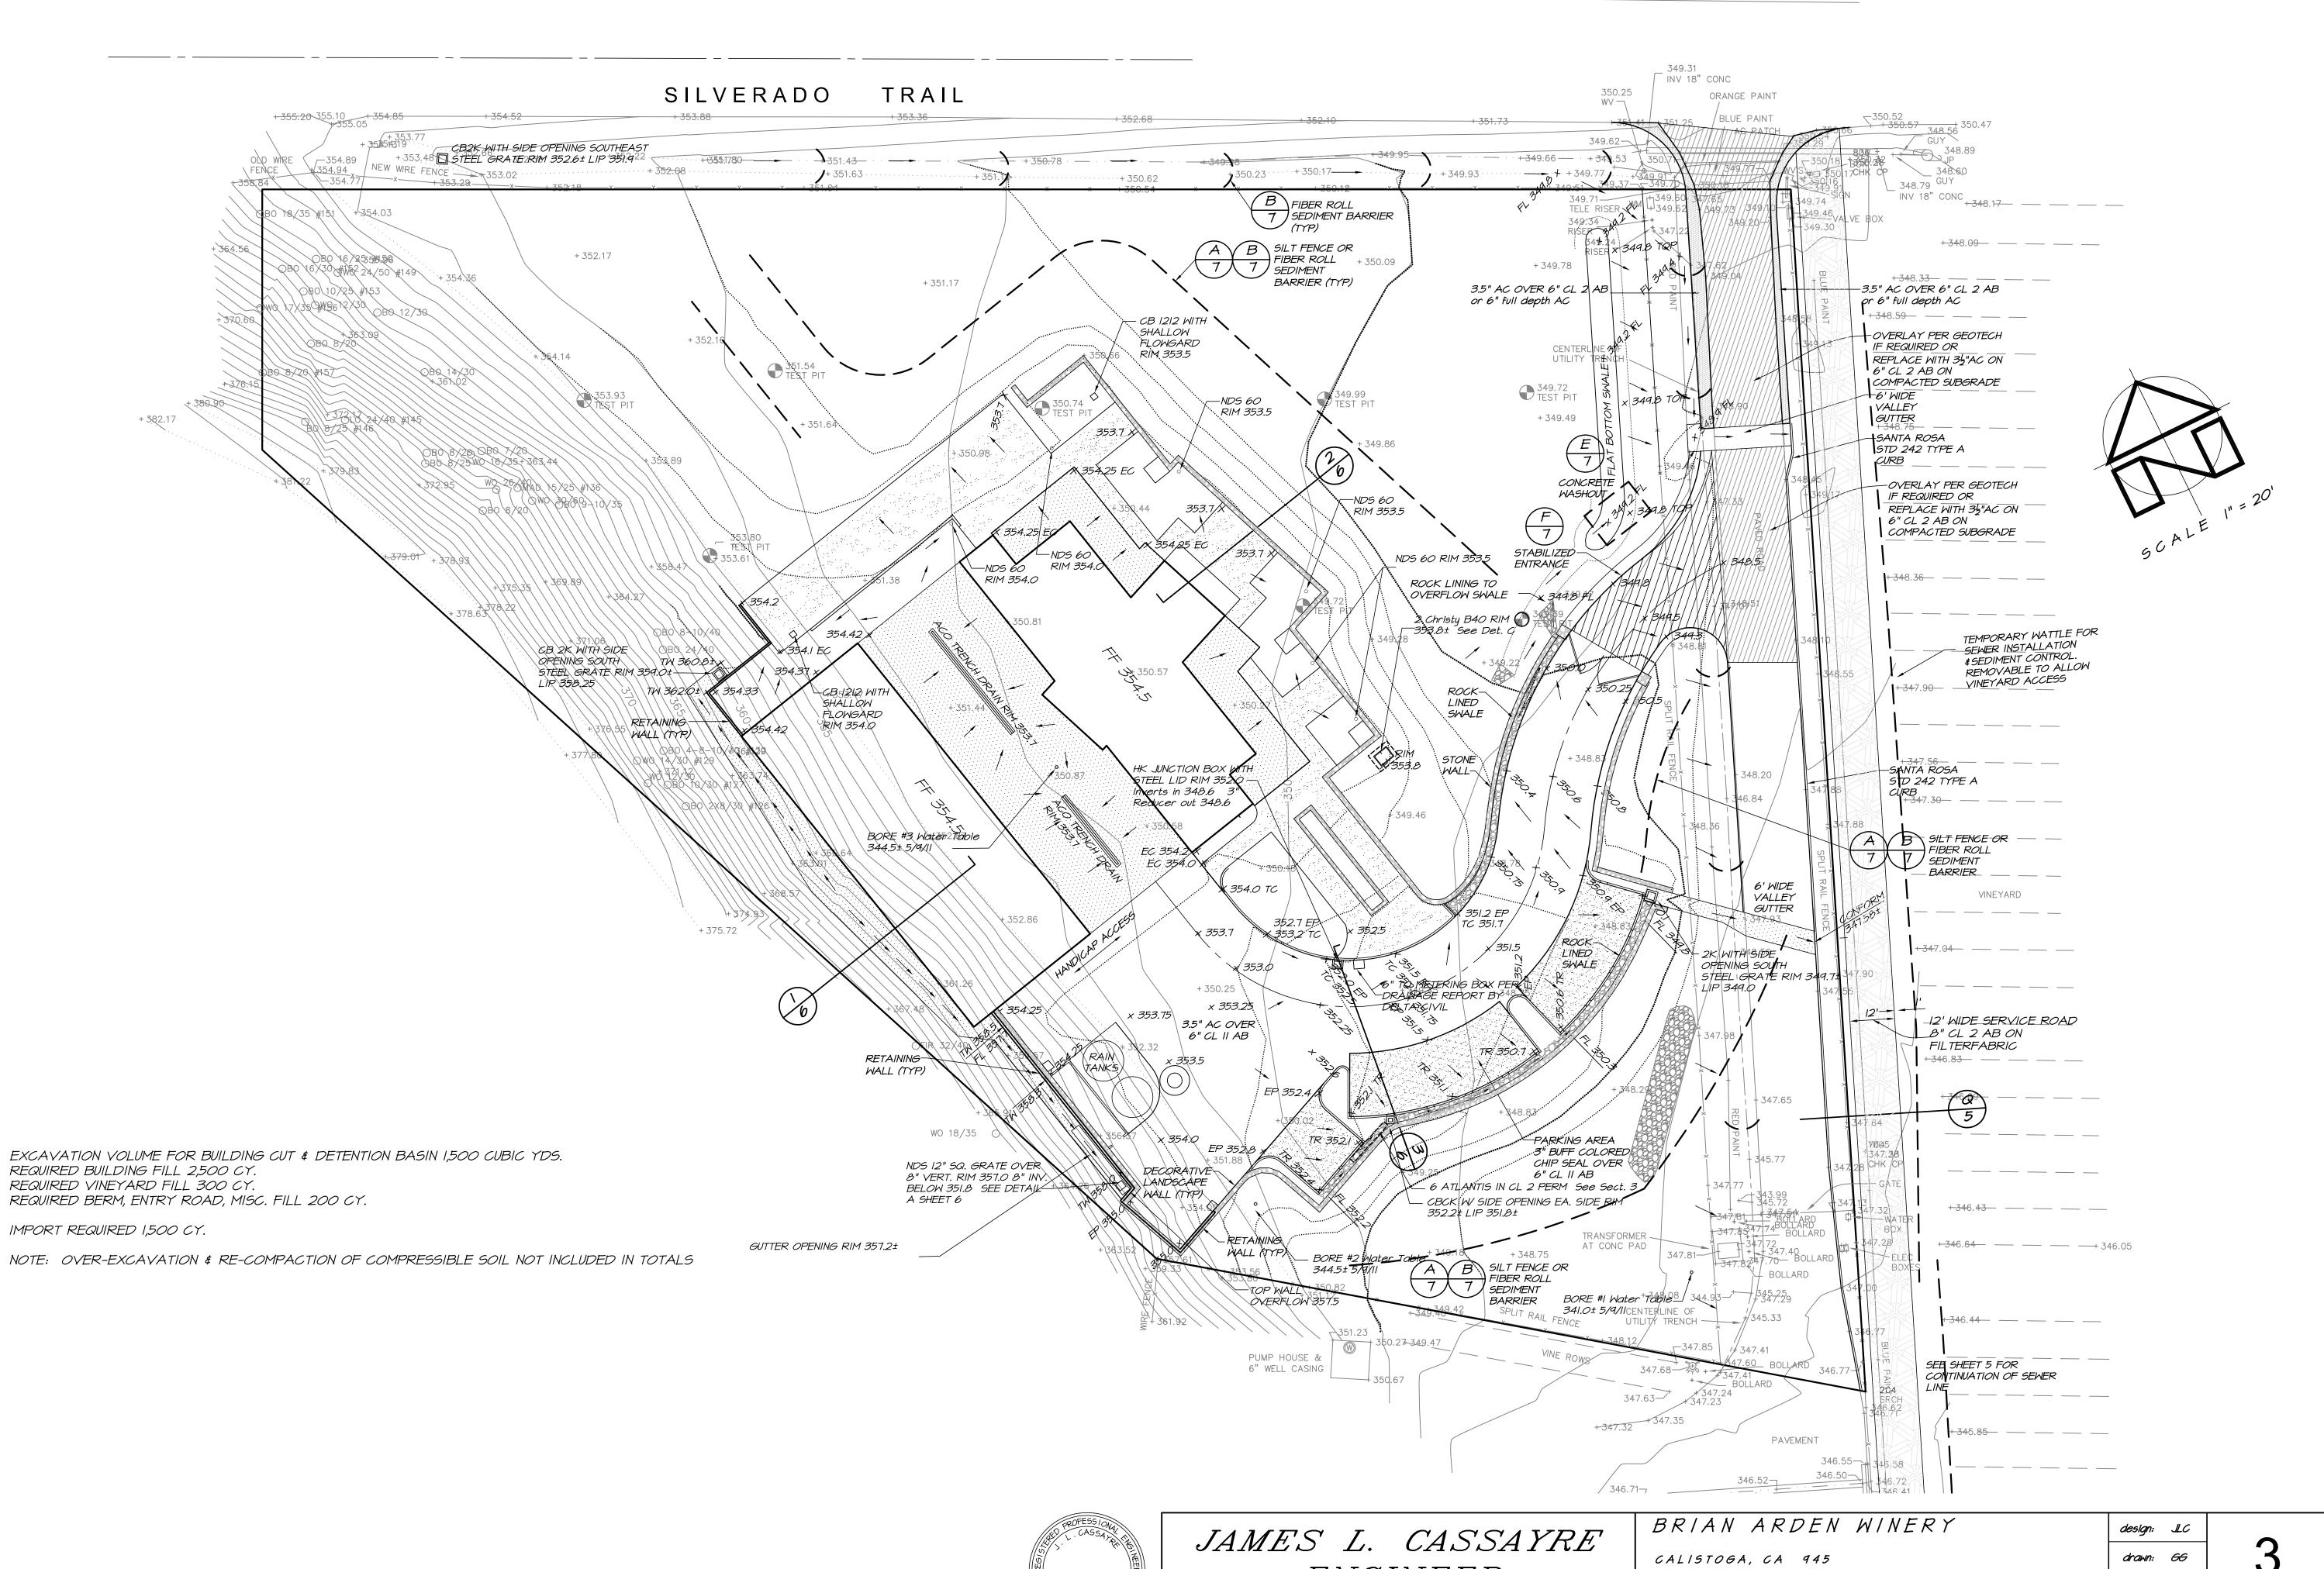
BRIAN	ARDEN	WINERY

drawn: 66 CALISTOGA, CA 945 COVER SHEET 18 JAN 2012

design: JLC

11-04



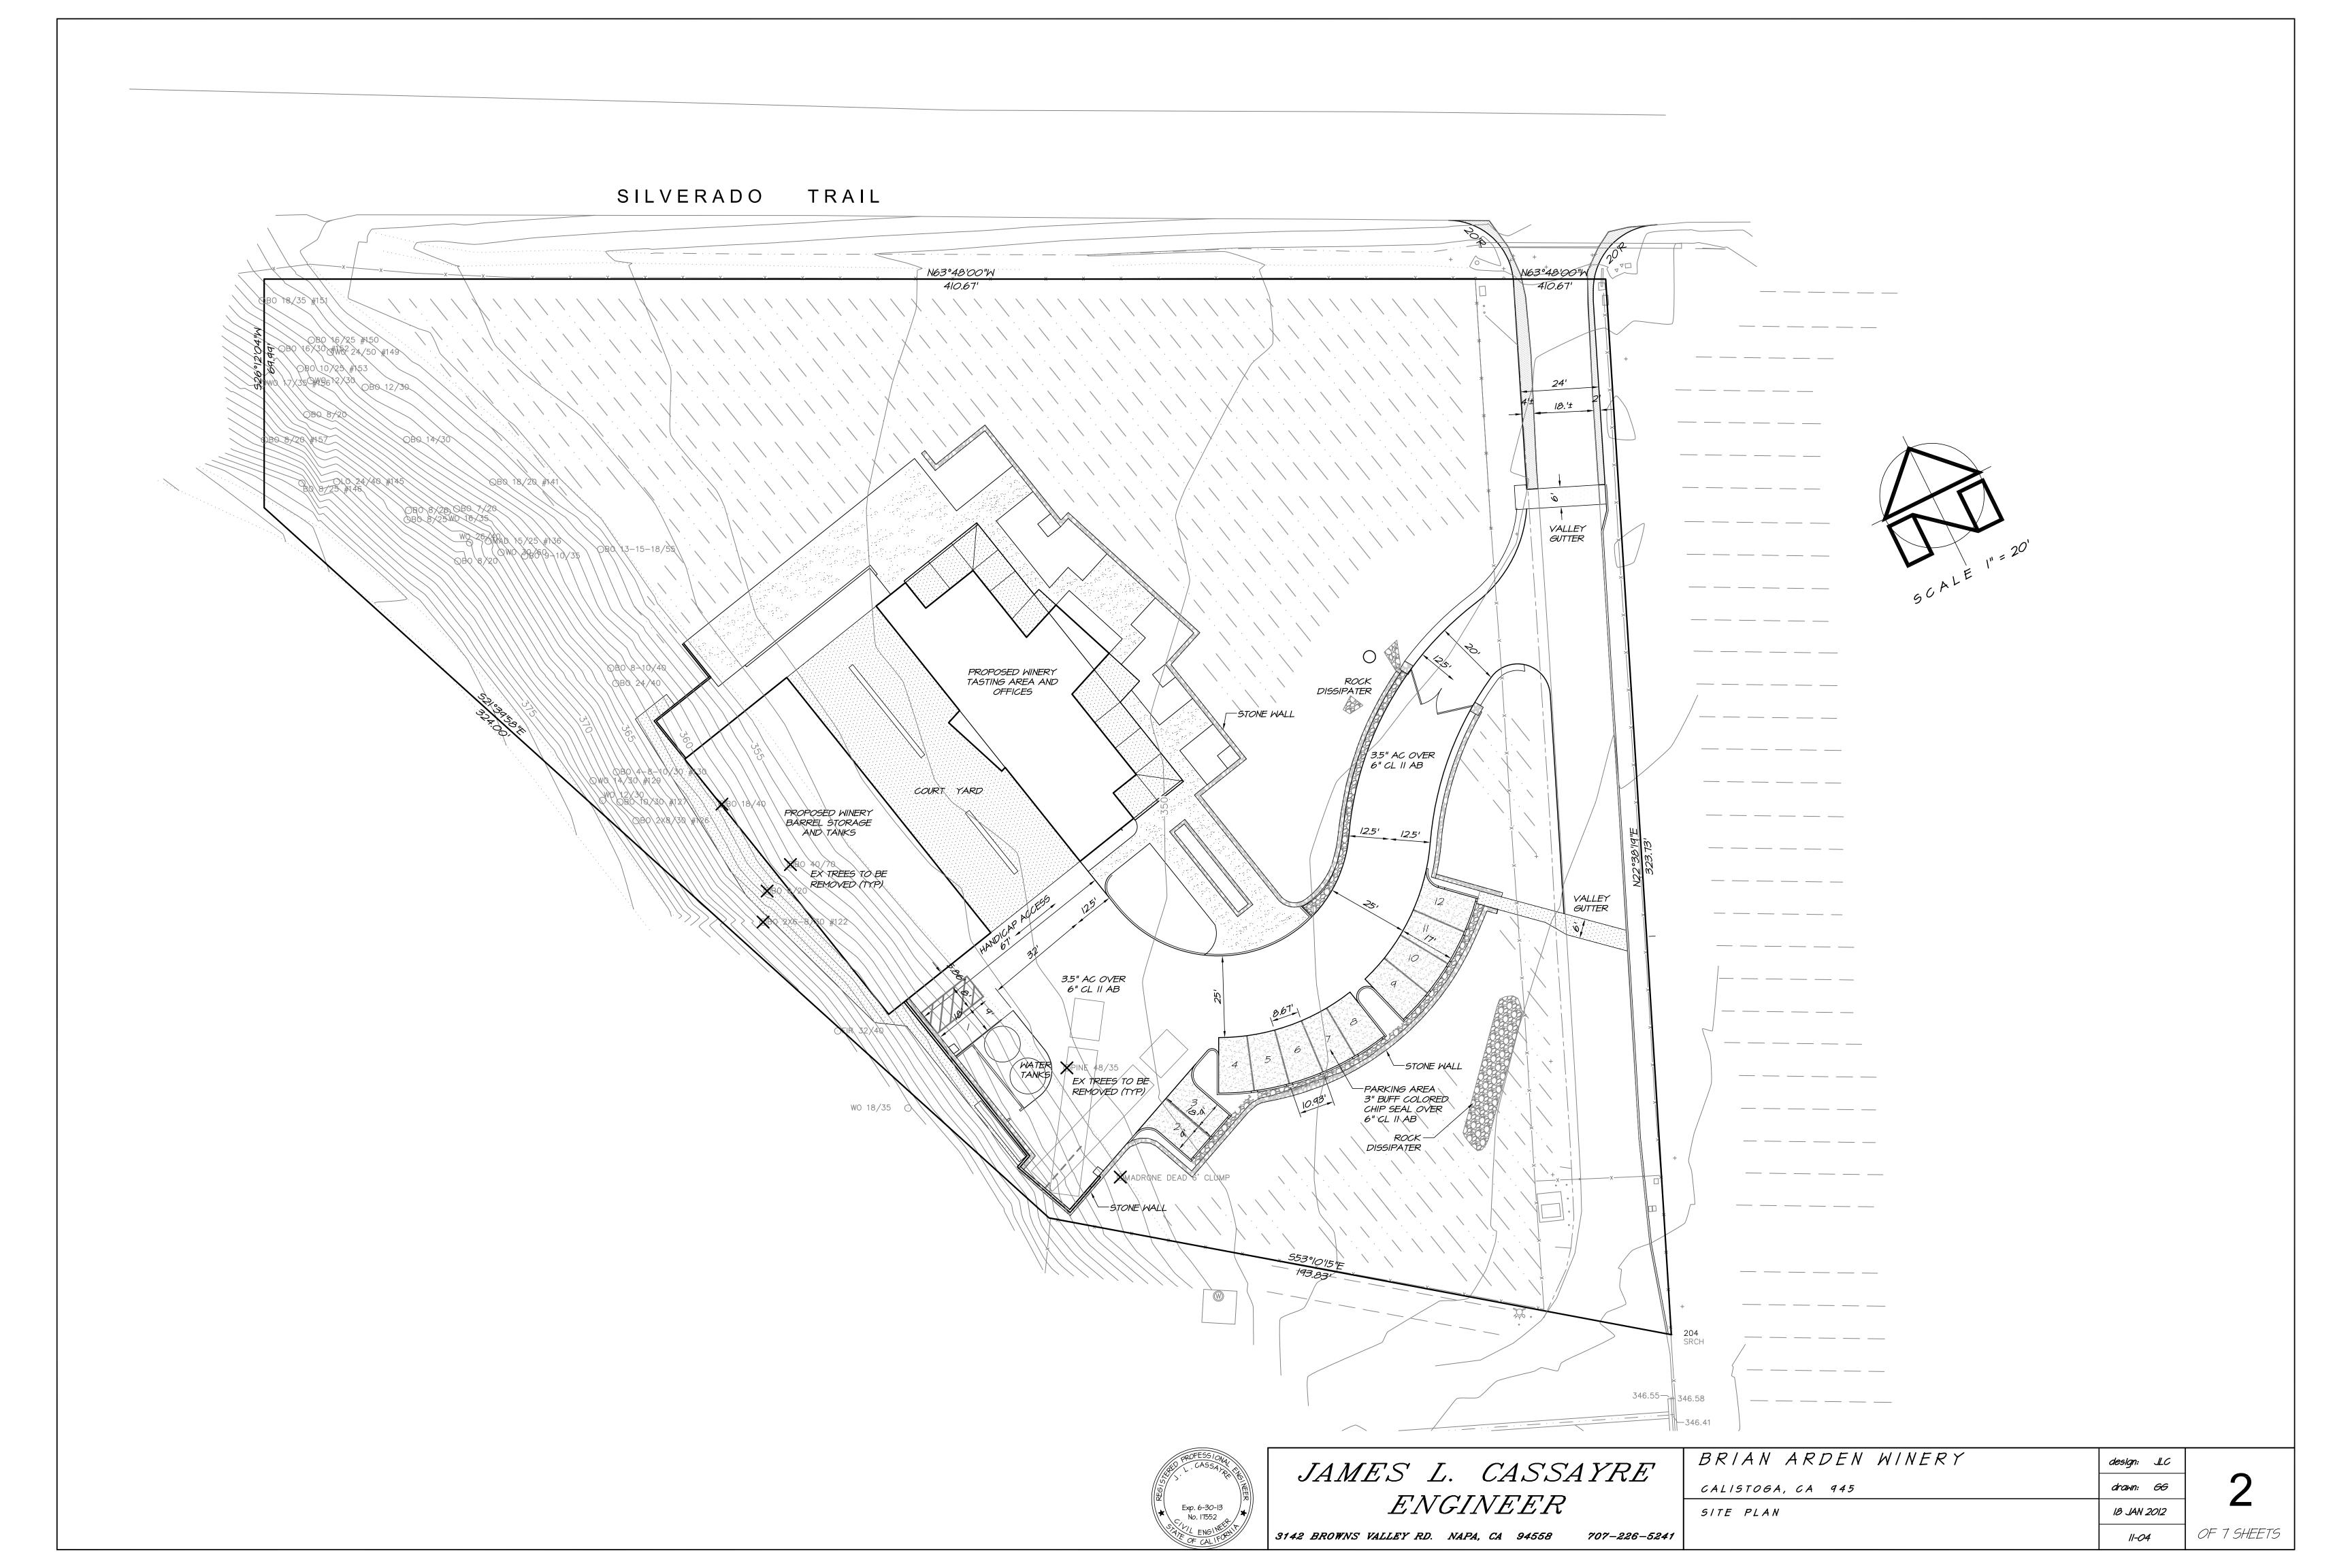




ENGINEER

707-226-5241

3142 BROWNS VALLEY RD. NAPA, CA 94558

GRADING AND EROSION CONTROL PLAN 18 JAN 2012 11-04

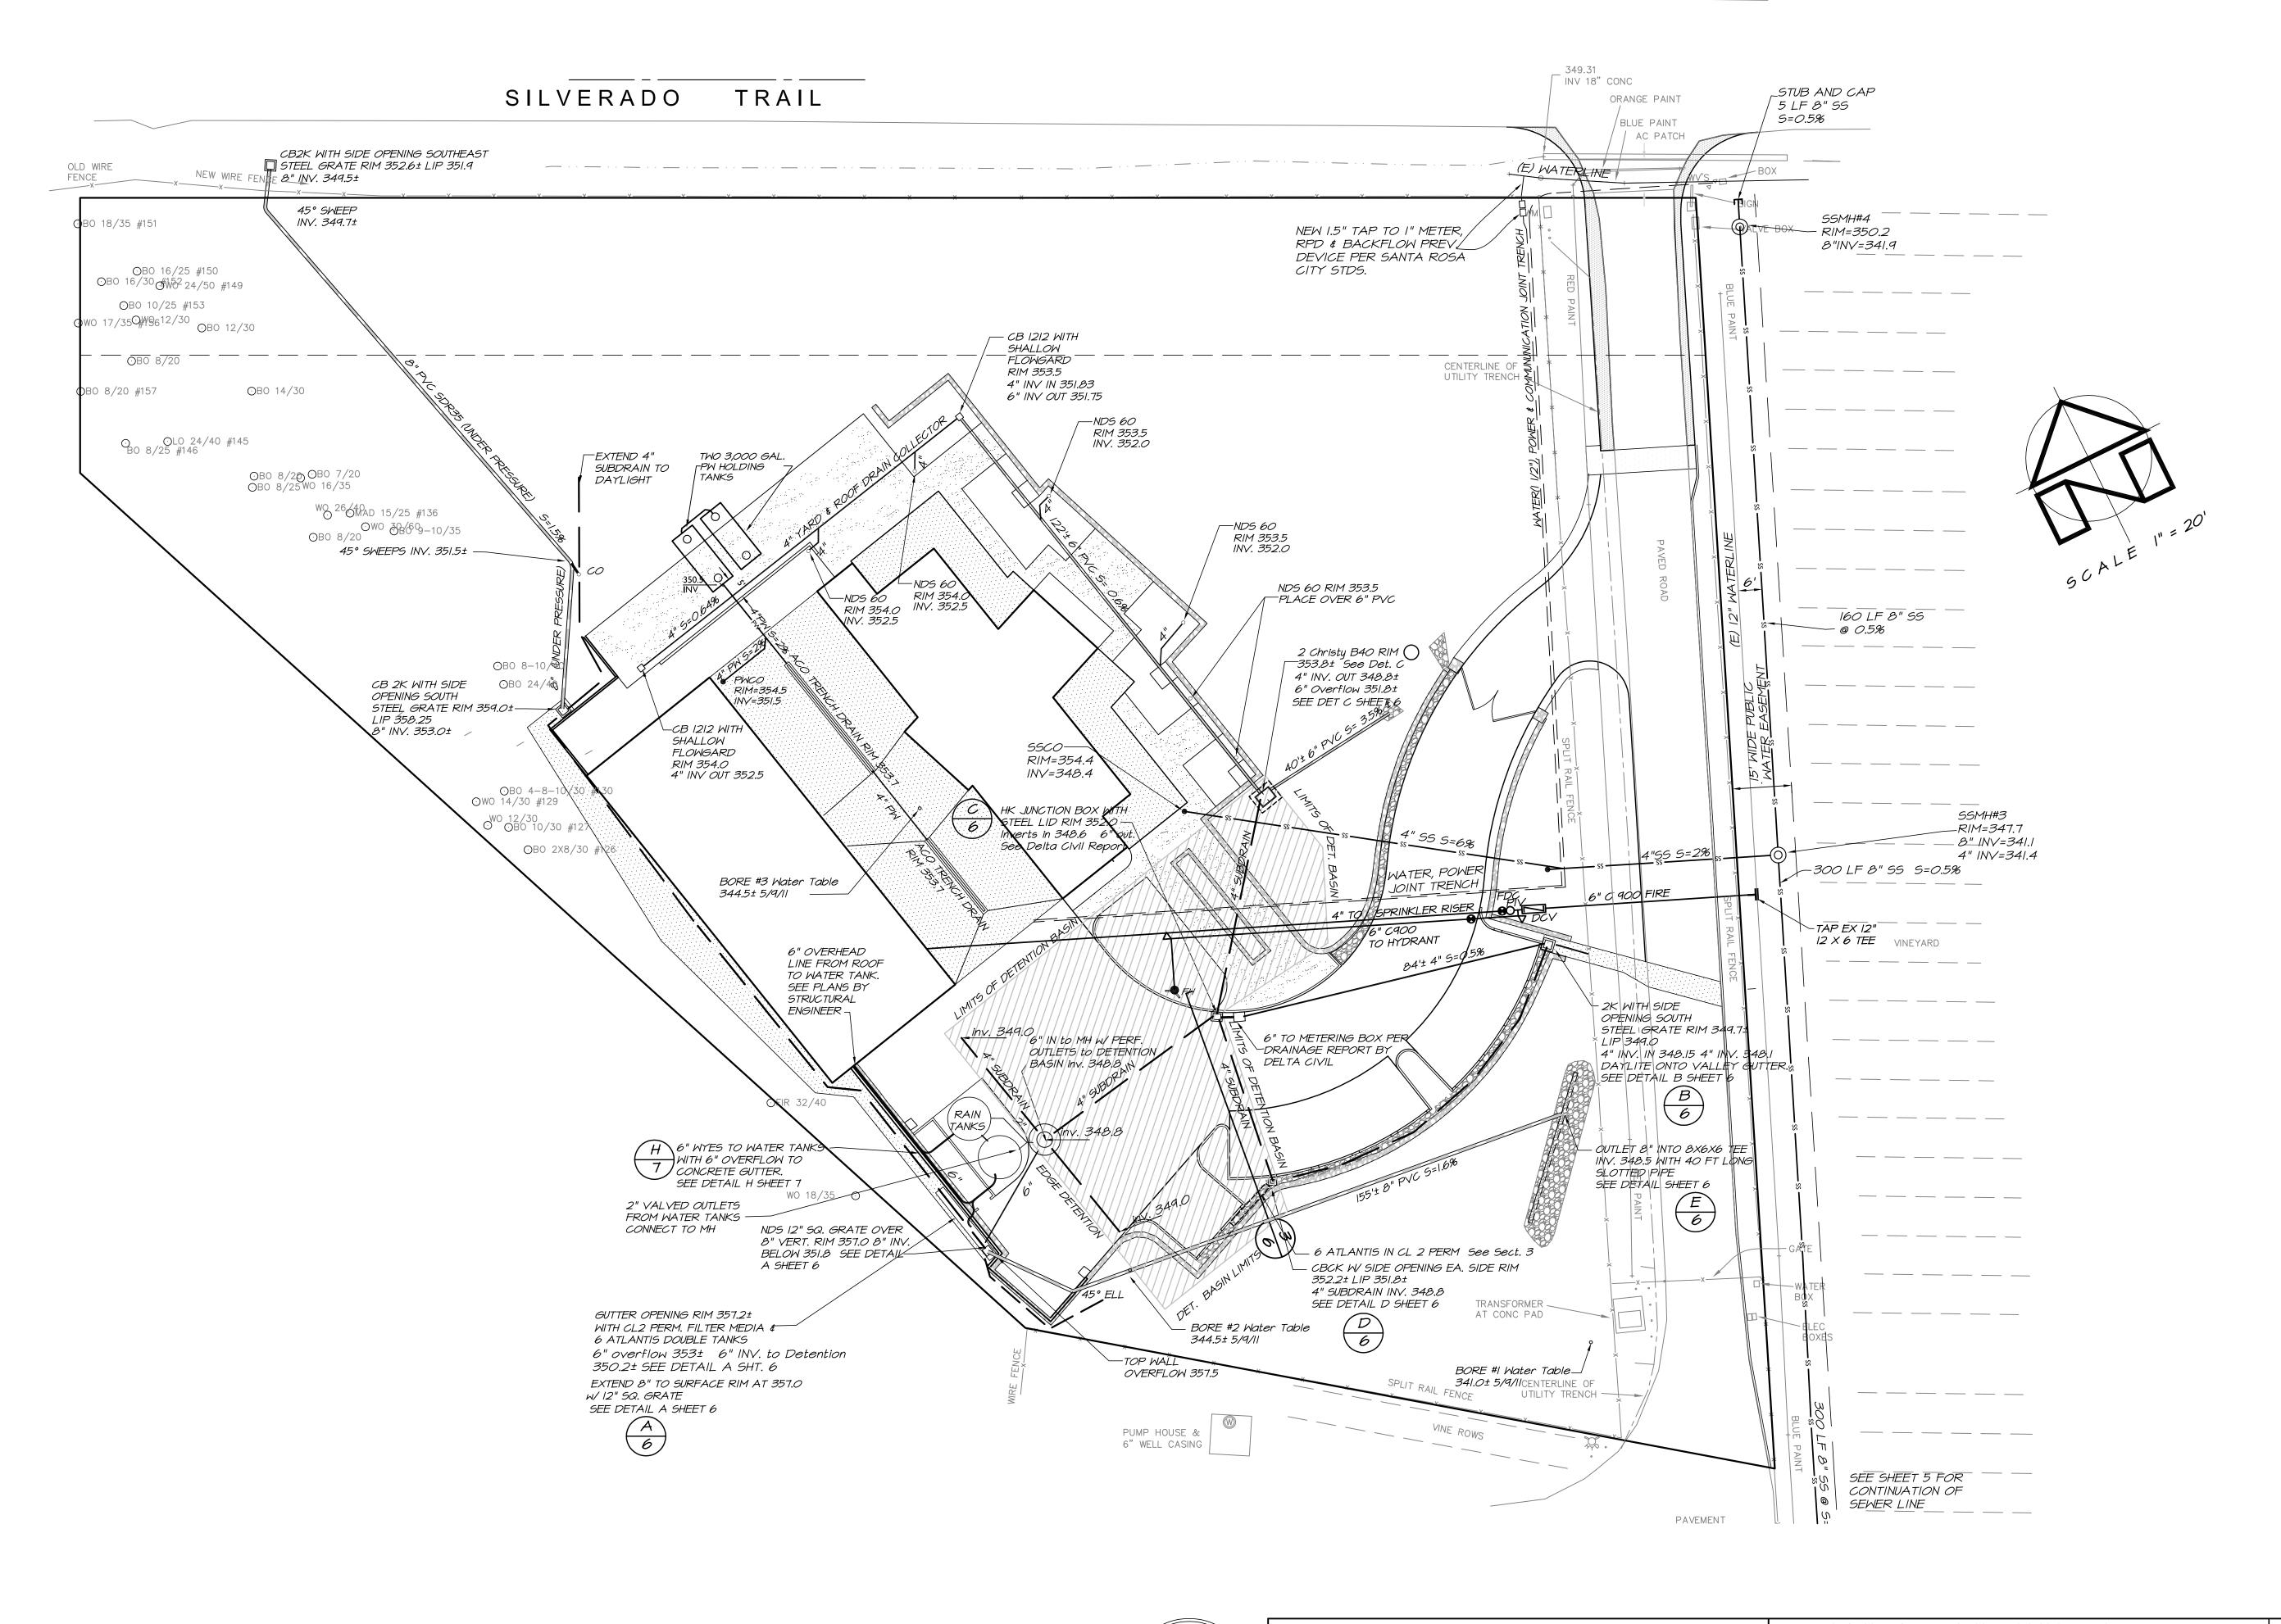



JAMES L. CASSAYRE ENGINEER

3142 BROWNS VALLEY RD. NAPA, CA 94558 707-226-5241


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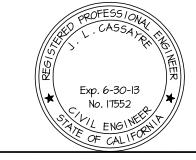
CALISTOGA, CA 945

UTILITY PLAN

IB JAN 2012

11-04



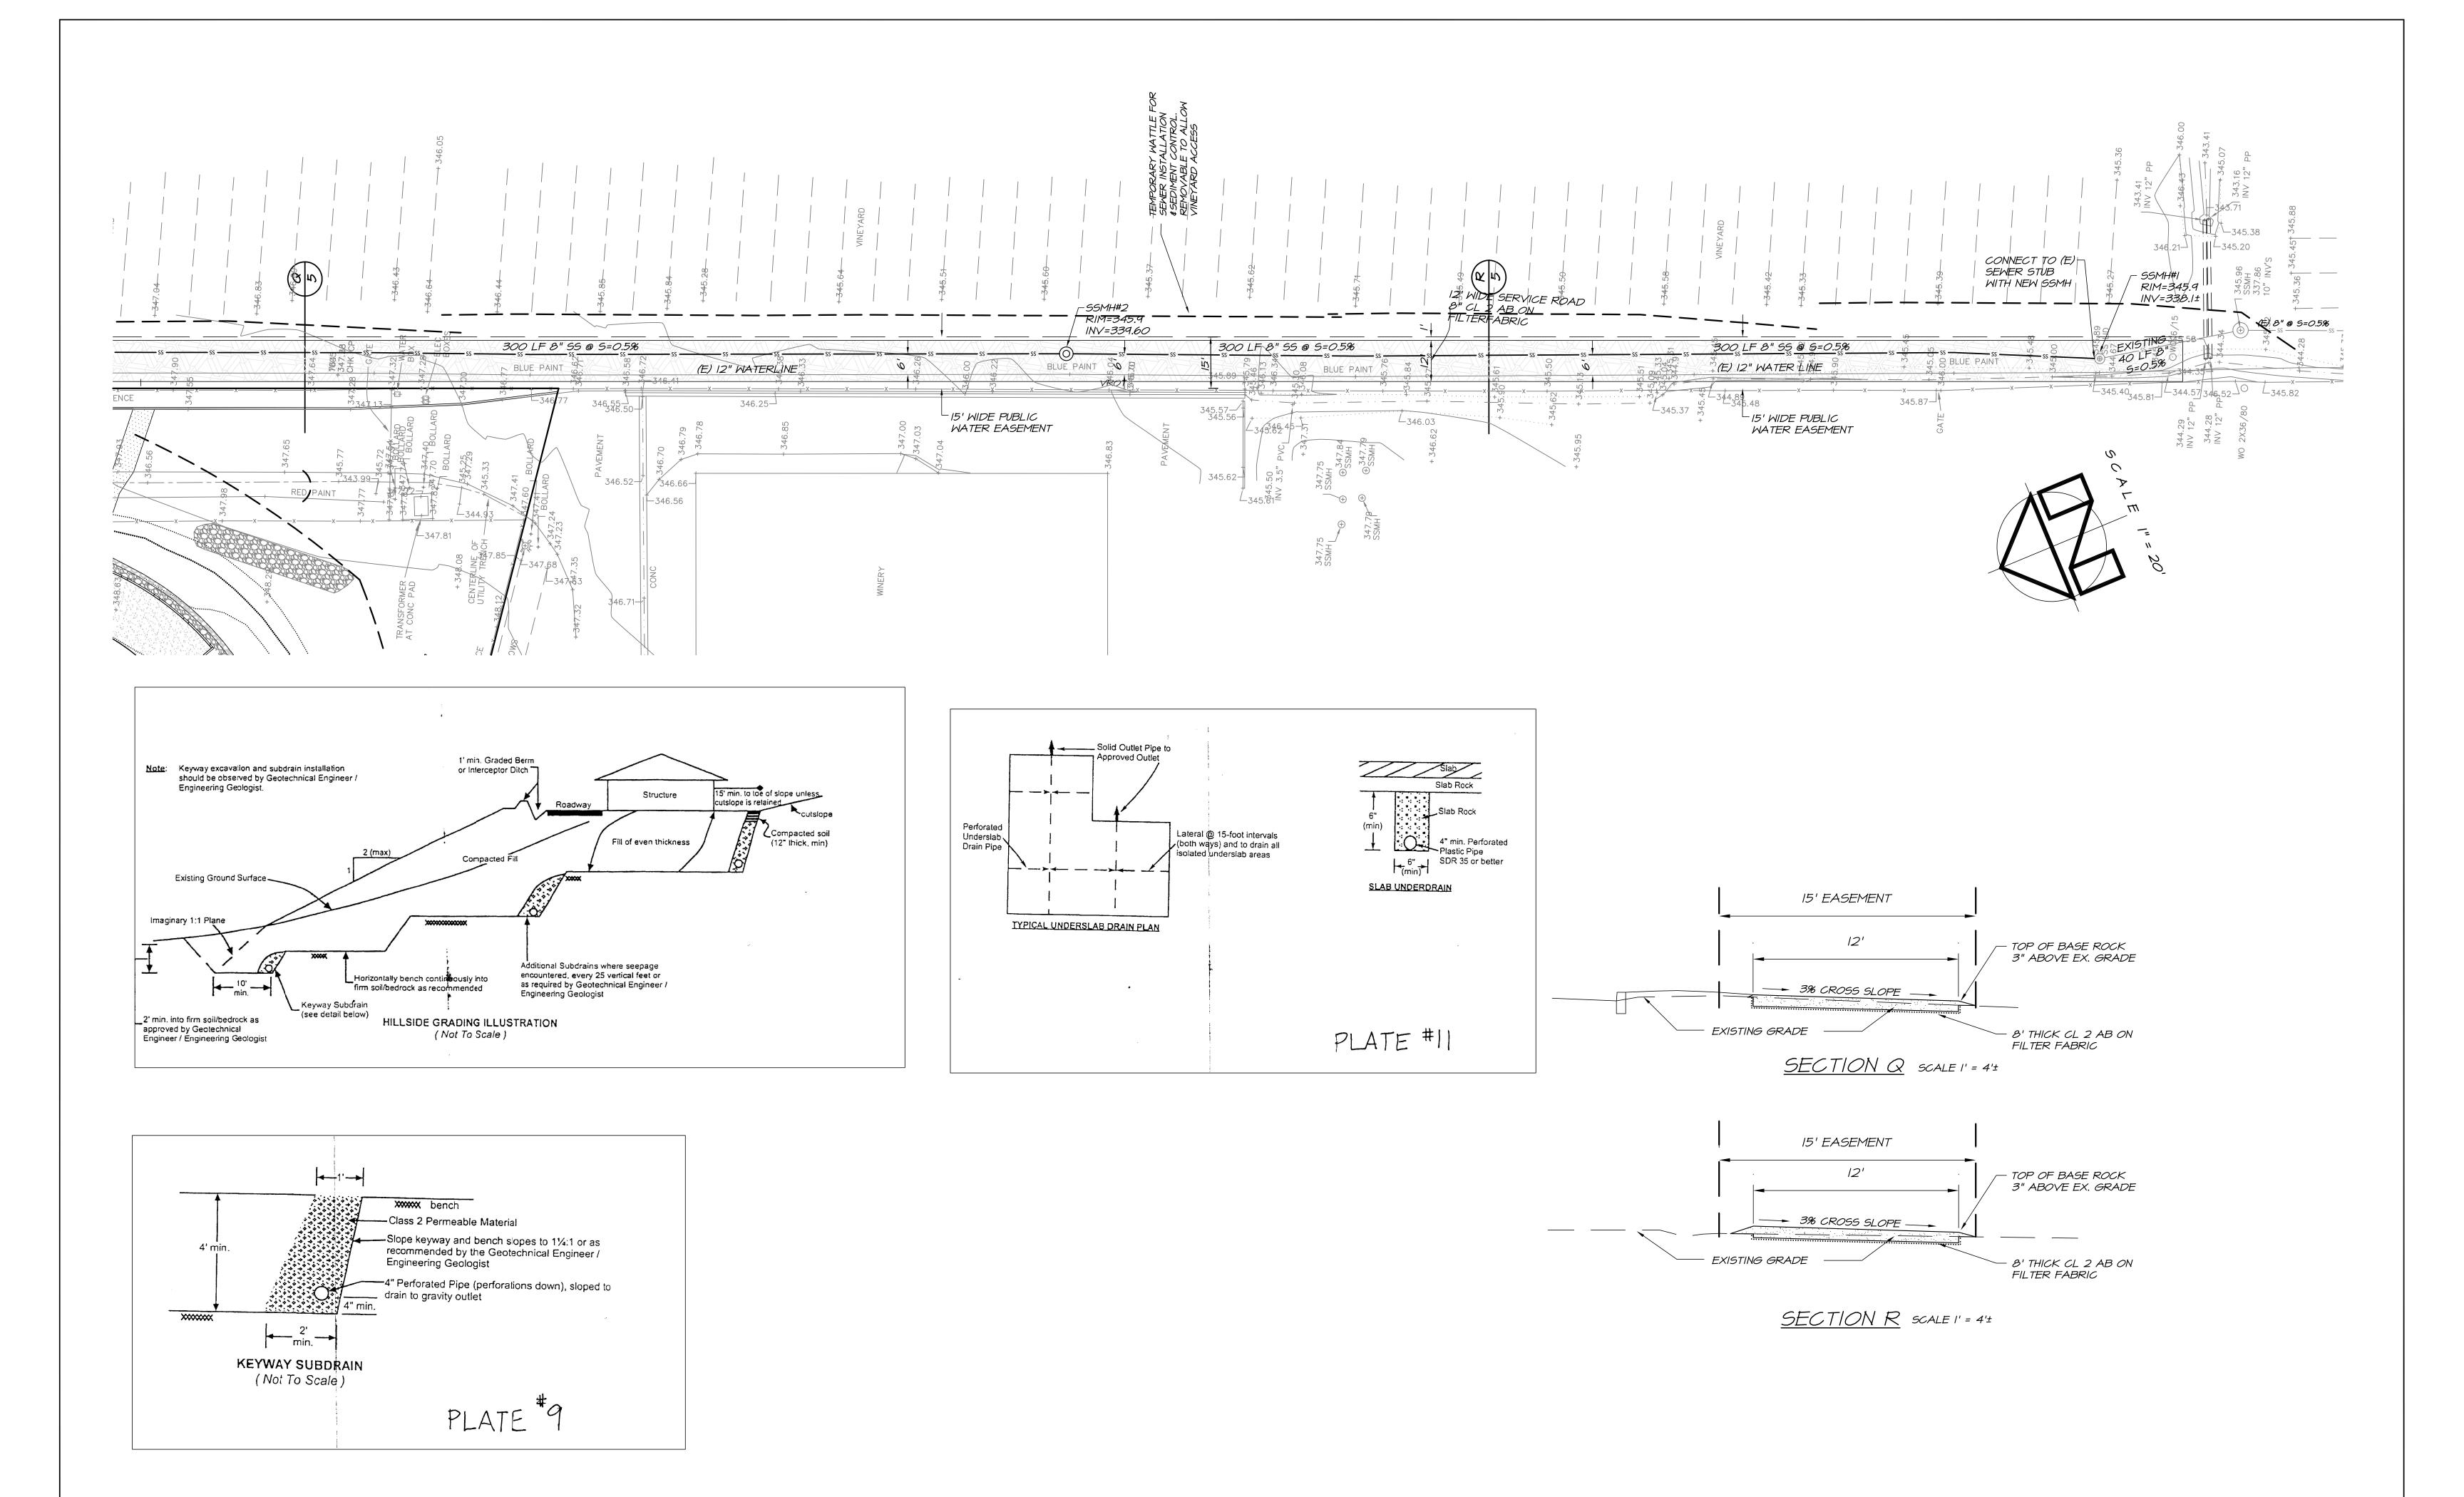


JAMES L. CASSAYRE ENGINEER

3142 BROWNS VALLEY RD. NAPA, CA 94558 707-226-5241

BRIAN ARDEN WINERY	a	design:	JLC
CALISTOGA, CA 945	(	drawn:	66
SEWER PLAN SOUTH		18 JAN 2012	

OF 1 SHEETS

11-04

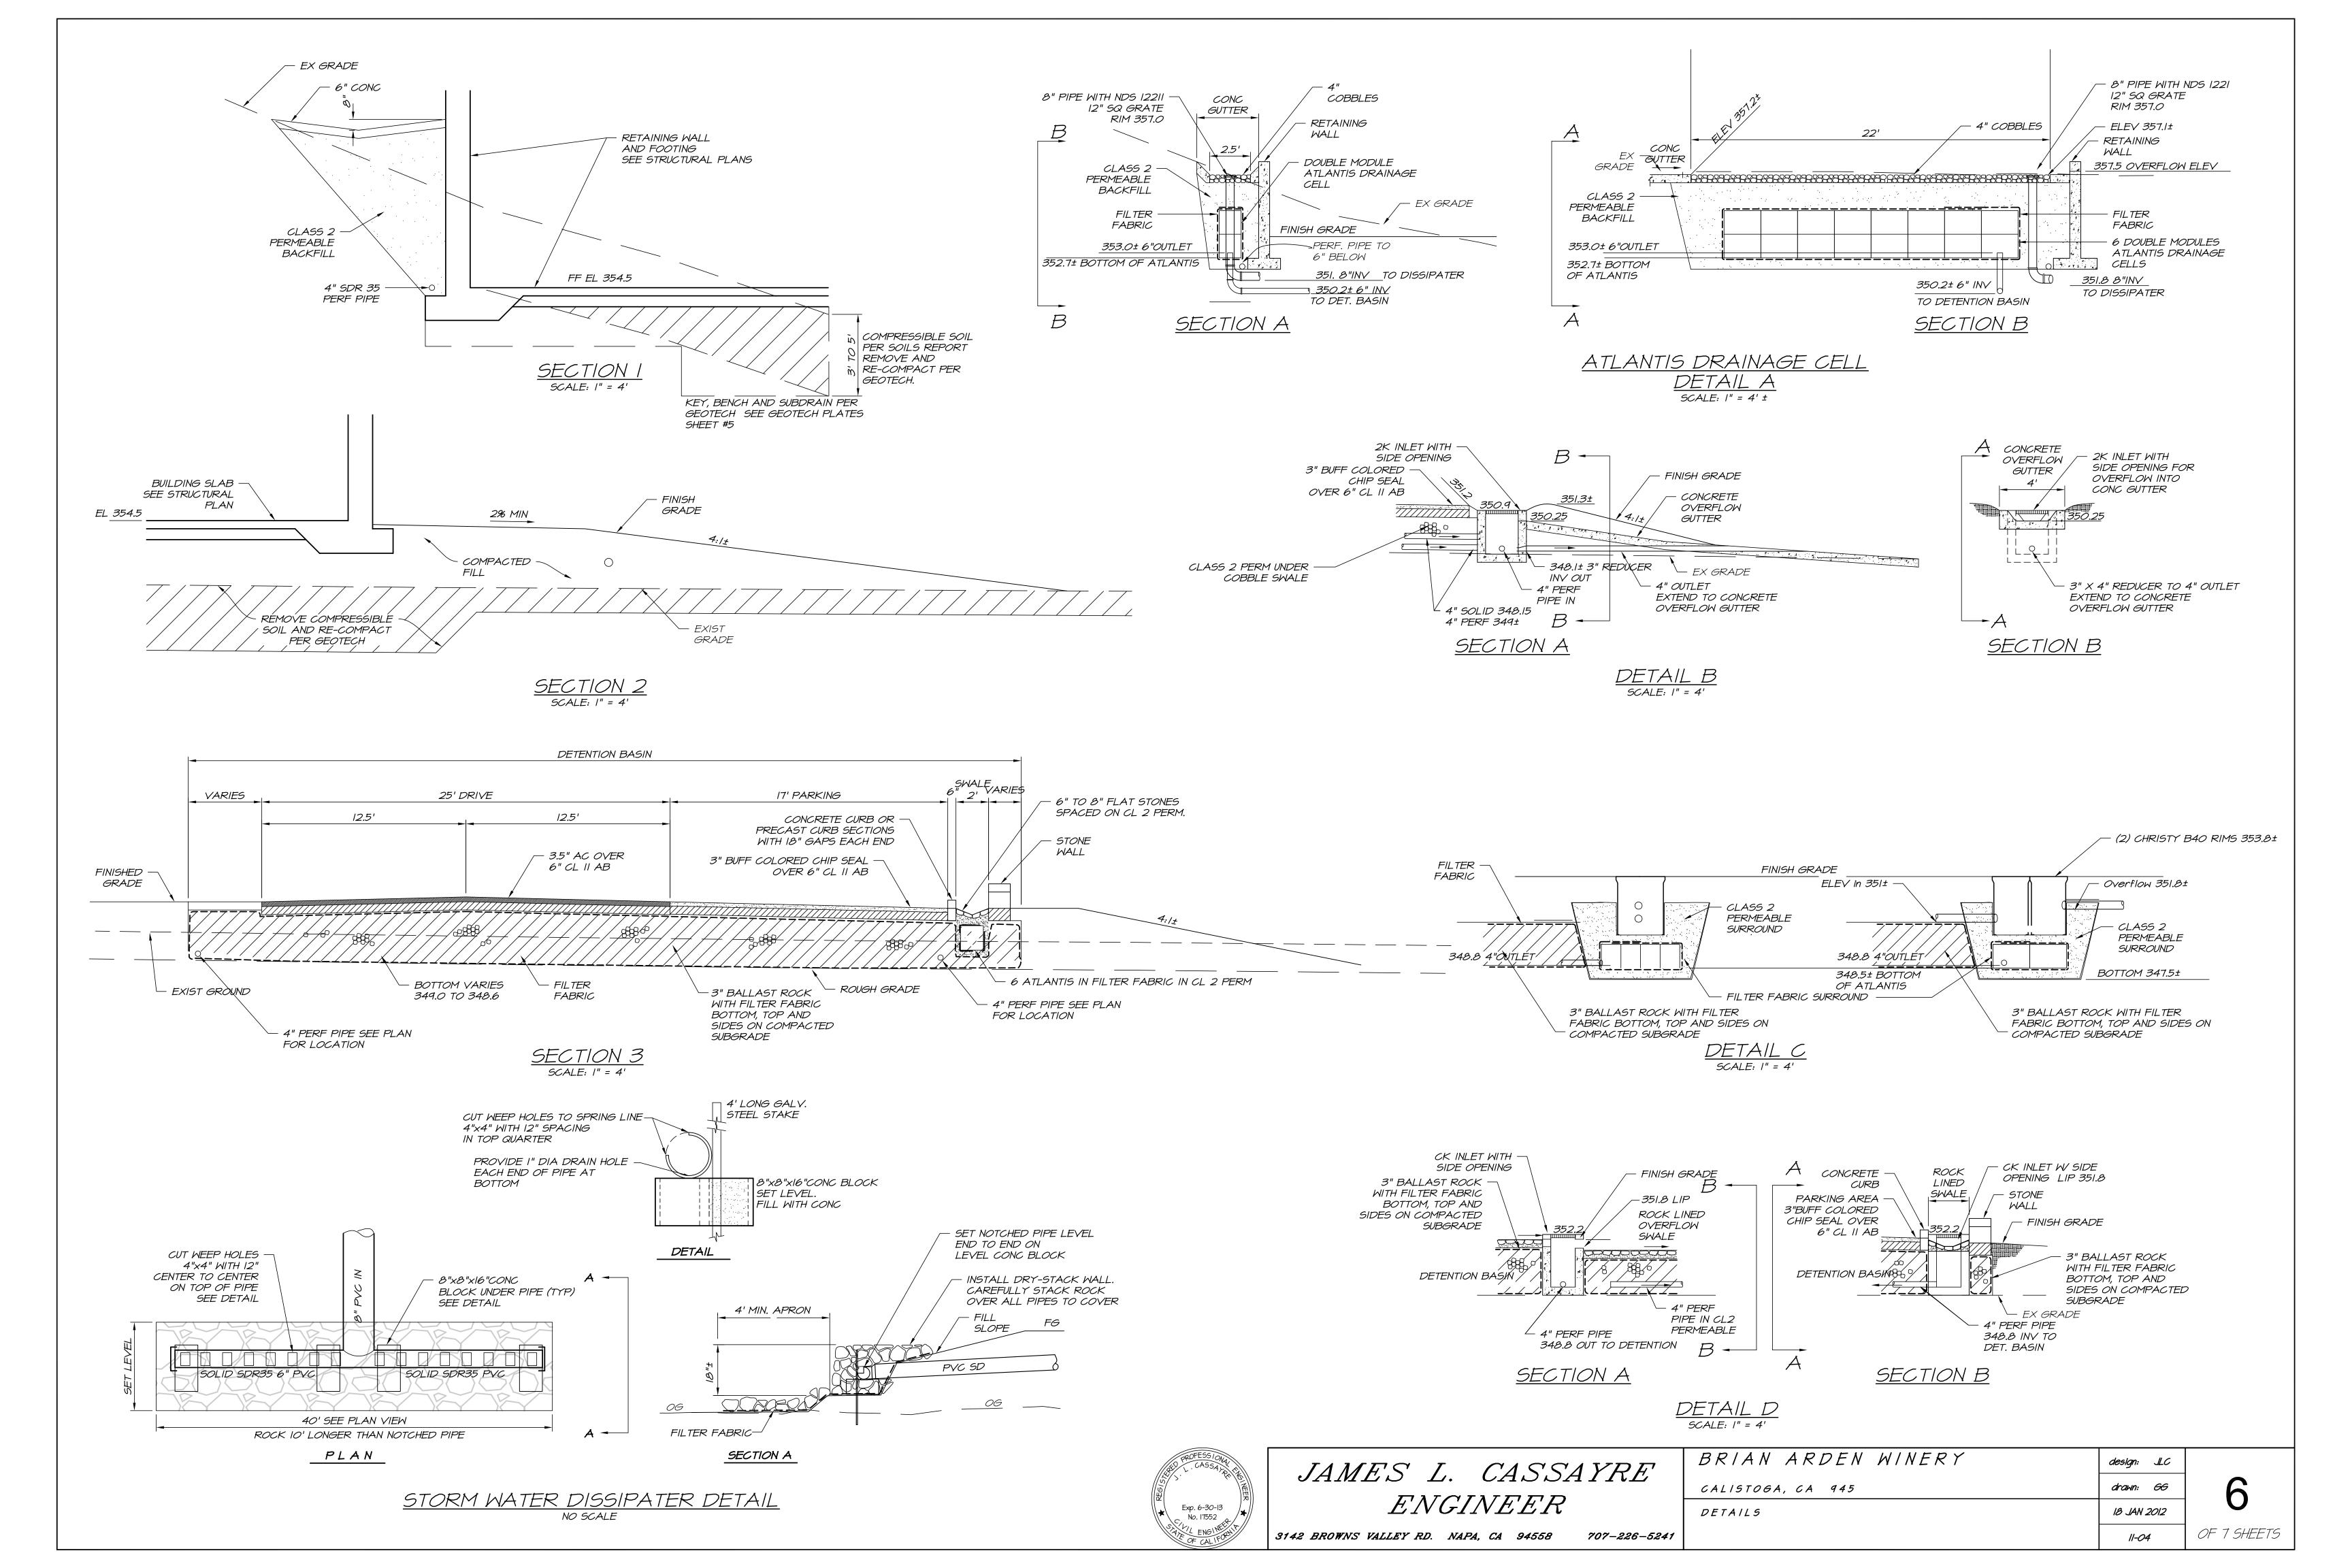

# EROSION AND SEDIMENT CONTROL NOTES

EROSION AND SEDIMENT CONTROL MEASURES AS INDICATED ON THE PLANS SHALL INCLUDE, BUT NOT BE LIMITED, TO THE FOLLOWING:

- STABILIZED CONSTRUCTION ENTRANCE AND EXITS TO REDUCE TRACKING OF MUD AND DIRT ONTO PUBLIC ROADS BY CONSTRUCTION VEHICLES.
- ERTEC PERIMETER GUARD OR FIBER ROLLS BELOW THE TOE OF EXPOSED AND ERODIBLE SLOPES, DOWNSLOPE OR EXPOSED SOIL AREAS, AND AS INDICATED ON THE PLANS.
- ROCK OR ERTEC PERIMETER GUARD CHECK DAMS TO REDUCE VELOCITY OF CONCENTRATED FLOW AND ENCOURAGE SEDIMENT SETTLING.
- PROTECTION OF BORROW AREAS AND SOIL STOCKPILE AREAS WITH A MINIMUM OF IO MIL VISQUEEN PLASTIC, INSTALLED ACCORDING TO SWPPP INSTRUCTIONS AND DETAILS, LOCATED WITHIN THESE ESC PLANS.
- PROTECT CUT AND FILL SLOPES AS OUTLINED IN THE SWPPP.
- PROTECTION TO BE INSTALLED AS SPECIFIED. 6. RE-VEGETATION TO BE COMPLETED PER LANDSCAPE
- ARCHITECT'S PLANS.
- OTHER EROSION CONTROL MEASURES SHALL BE UTILIZED AS FIELD CONDITIONS REQUIRED.
- 8. ANY CHANGES MADE TO THE PLAN MUST BE APPROVED BY THE ENGINEER AND/OR STORM WATER MANAGEMENT CONSULTANT.

#### REQUIREMENTS: CONTRACTOR SHALL INSTALL BEST MANAGEMENT PRACTICES

- (BMP'S) WITH THE INTENT OF PREVENTING SEDIMENT OR OTHER CONTAMINANTS FROM LEAVING THE SITE AND ENTERING DRAINAGE WAYS. CONTRACTOR SHALL MINIMIZE DISTURBANCES OF EXISTING SOILS
- OUTSIDE OF THE LIMITS OF THE WORK AREA AND AS INDICATED ON THE PLAN.
- A NOTICE OF INTENT SHALL BE FILED BY THE OWNER FOR THIS PROJECT PER NPDES REQUIREMENTS. CONTRACTOR SHALL COMPLY WITH ALL NPDES GENERAL PERMIT AND SWPPP REQUIREMENTS.
- INSTALLATION OF ALL BMP'S SHALL BE COMPLETED PRIOR TO OCTOBER I OR BEFORE THE START OF CONSTRUCTION IN ACCORDANCE WITH THE APPROVED STORM WATER MANAGEMENT PLAN. ALL BMP'S SHALL BE MAINTAINED FOR THE ENTIRE LIFE OF THE PROJECT.
- WHEN TEMPORARY MEASURES HAVE SERVED THEIR INTENDED PURPOSE AND THE CONTRIBUTING DRAINAGE AREA HAS BEEN PROPERLY STABILIZED, THE MEASURES CAN BE REMOVED AND ANY SEDIMENT DEPOSITS DISPOSED OF ACCORDING TO LOCAL, STATE AND FEDERAL ORDINANCES. DISPOSAL OR REUSE OF SEDIMENT ON SITE AS FILL MUST HAVE THE APPROVAL OF THE
- EROSION CONTROL MEASURES SHOWN ON THE PLAN THAT INTERFERE WITH THE WORK MAY BE RELOCATED OR MODIFIED WITH APPROVAL OF LOCAL GOVERNING AGENCY AND/OR THE ENGINEER AND STORM WATER MANAGEMENT CONSULTANT.
- INSTALLATION OF GRAVEL ROADWAYS, WALKWAYS, OR OTHER MEASURES SHALL BE UTILIZED IN ADDITION TO WATER OR OTHER DUST PALLIATIVES TO CONTROL AND PREVENT BLOWING DUST OR MINIMIZE THE CREATION OF DUST.

#### MAINTENANCE:

- THE CONTRACTOR SHALL BE RESPONSIBLE FOR MAINTENANCE OF BMP'S AT ALL TIMES DURING THE CONSTRUCTION PERIOD. ALL BMP'S SHALL BE INSPECTED AND REPAIRED AS REQUIRED AT THE END OF EACH WORKING DAY.
- AFTER THE FIRST HEAVY RAIN OF THE SEASON, THE BMP'S SHALL BE INSPECTED FOR DEFICIENCIES. ERTEC, SWALES, DITCHES, ROCK RIPRAP OR OTHER BMP'S WILL BE ADDED AS NECESSARY TO ENSURE THAT WATER POLLUTION IS MINIMIZED TO THE MAXIMUM EXTENT PRACTICAL.
- AFTER HEAVY RAINS, THE SITE SHALL BE INSPECTED FOR EXCESSIVE EROSION AND ERODED AREAS REPAIRED AS REQUIRED BY ADDING RIPRAP OR COBBLE TO PREVENT FURTHER EROSION.
- REGULAR BASIS, AND BEFORE THE SEDIMENT REACHES 50% OF THE MAXIMUM LOAD. DURING THE RAINY SEASON, ALL PAVED SURFACES SHALL BE MAINTAINED FREE OF EARTH MATERIAL AND DEBRIS. WHEN THE WORK REQUIRES THAT MATERIALS BE PLACED UPON PAVED

SEDIMENT IS TO BE REMOVED FROM SEDIMENT TRAPS ON A

SURFACES, APPROPRIATE MEASURES SHALL BE TAKEN TO PROTECT THE MATERIAL FROM ERODING. 6. THE CONTRACTOR SHALL BE RESPONSIBLE FOR CLEANUP OF MUD AND DEBRIS CARRIED ONTO SURROUNDING PROPERTIES, STREETS AND ROADS AS A RESULT OF CONSTRUCTION ACTIVITY ON THE SITE TO THE SATISFACTION OF THE LOCAL GOVERNING AGENCY. ANY MUD THAT IS TRACKED ONTO PUBLIC ACCESS

### REVIEW THE STORM WATER MANAGEMENT PLAN AND FOLLOW ALL REQUIREMENTS AS SET FORTH IN THE SWPPP.

SHALL BE REMOVED THAT SAME DAY.

CONTRACTOR WILL HAVE ALL SUB-CONTRACTORS ATTEND A SITE SPECIFIC TRAINING AND MAINTAIN THE TRAINING LOG, LOCATED IN THE SWPPP DOCUMENT.

THIS PLAN WILL NOT COVER ALL THE SITUATIONS THAT MAY ARISE DURING CONSTRUCTION. ADJUSTMENTS TO THE PLAN MAY BE MADE AS CONDITIONS WARRANT

SEE CONSTRUCTION SWPPP FOR INSTALLATION AND MAINTENANCE GUIDELINES.

# SEED REQUIREMENTS

15% CRIMSON CLOVER

LESS THAN 80% COVERAGE

APPLY SEED MIX ONE LISTED BELOW UNLESS DIRECTED OTHERWISE BY LANDSCAPE ARCHITECT:


WITH APPROVAL OF THE LOCAL GOVERNING AGENCY.

SEED MIX ONE (APPLICATION RATE = 31 LBS/ACRE) 40% BLANDO BROME 8% ZORRO ANNUAL FESCUE 12% LANA VETCH 15% ROSE CLOVER

IO% SUB-CLOVER MULCH REQUIREMENTS-STRAW MULCH AT THE RATE OF

3,000 LBS./ACRE FERTILIZER REQUIREMENTS-12:12:12 AT THE RATE OF 400 LBS./ACRE

RESEEDING REQUIREMENTS-RESEED ALL AREAS HAVING

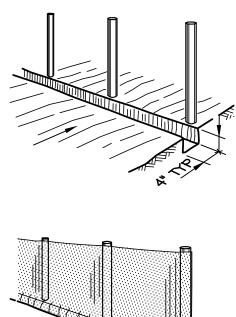



I. SET STEEL OR WOOD POSTS (SEE NOTE I.) AND EXCAVATE A 4 BY 4 IN TRENCH UPSLOPE FROM AND ALONG THE LINE OF

2. INSTALL MIRAFI FILTER FABRIC SILT FENCE WITH POCKETS (OR APPROVED EQUAL) ON THE STEEL POSTS AND EXTEND IT INTO THE

3. BACKFILL AND COMPACT


THE EXCAVATED SOIL.

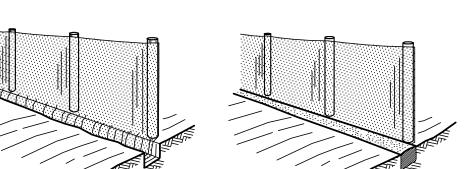


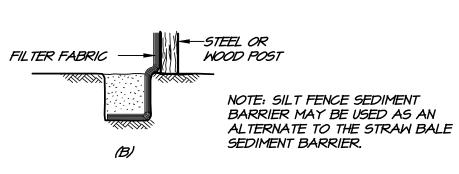


CONSTRUCTION OF A SILT FENCE. (A) INSTALLATION SEQUENCE. (B) EXTENSION OF FABRIC INTO THE TRENCH.



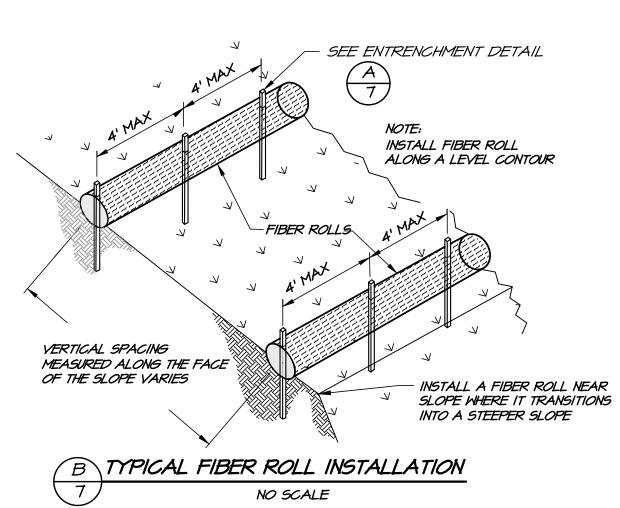

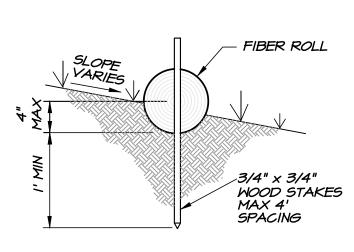



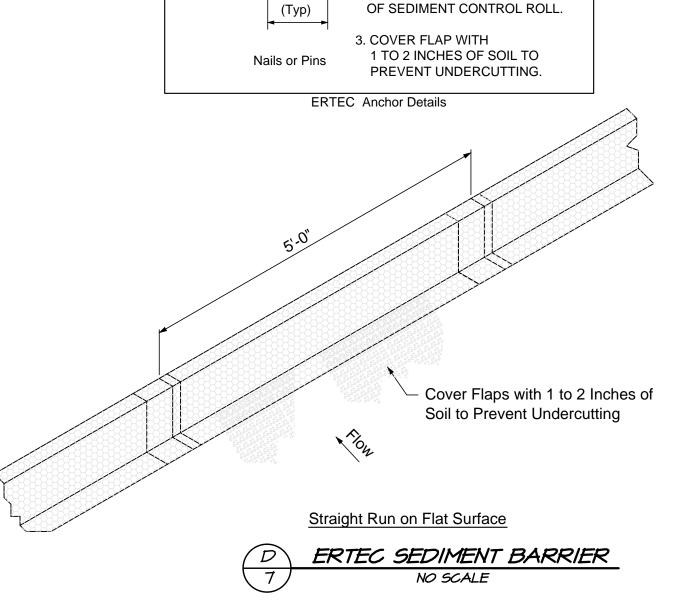

1. INSTALL NAILS FLUSH

THAT NETTING IS IN GOOD CONTACT

(60D BRIGHT COMMON)

OR 8 INCH ROUNDTOP PINS.

ONE FOOT FROM EACH END


**INSTALL 2 PER FIVE FOOT** 

LENGTH. POSITION NAILS

WITH NETTING SO


WITH SOIL.

2. USE 6 INCH NAILS

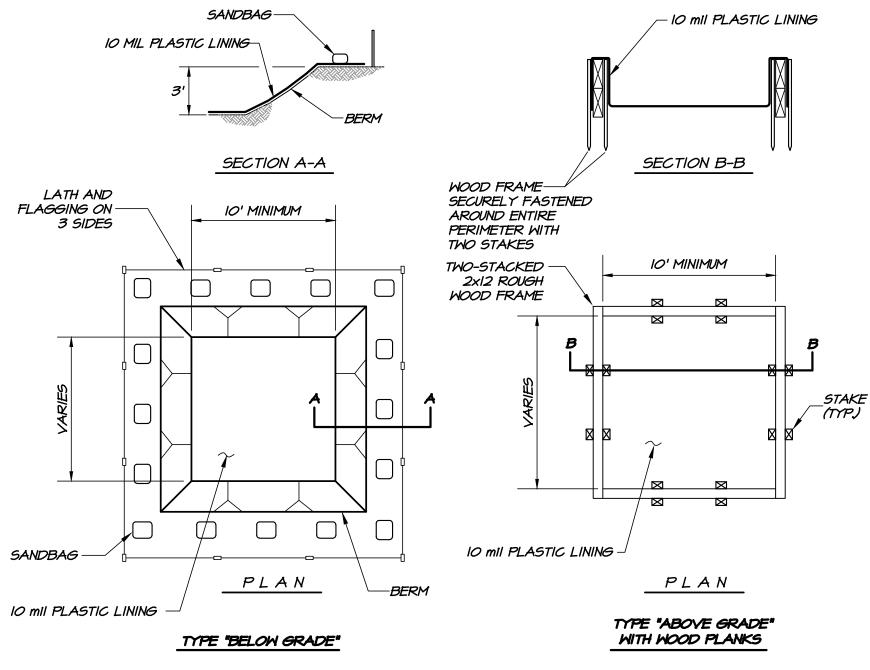


E CONCRETE WASHOUT DETAIL


NO SCALE

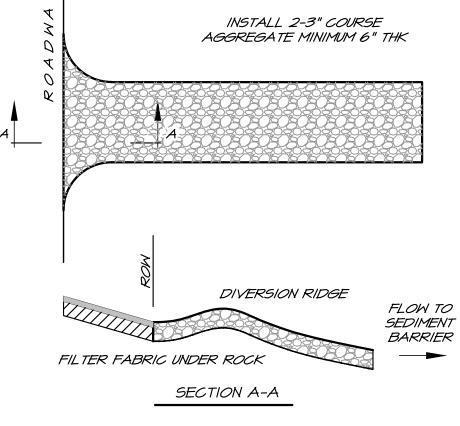

NOTES: I) THE ENTRANCE SHALL BE MAINTAINED SUCH TO PREVENT TRACKING OR FLOWING OF ANY SEDIMENT ONTO THE PUBLIC RIGHT OF WAY. THIS MAY REQUIRE TOP DRESSING, REPAIR AND/OR CLEANING OUT ANY TRAPPED SEDIMENT. 2) WHEN NECESSARY WHEELS SHALL BE CLEANED PRIOR TO THE VEHICLE DRIVING ONTO THE PUBLIC RIGHT OF WAY. 3) WHEN WASHING IS REQUIRED IT SHALL BE DONE ON THE CRUSHED STONE SUCH THAT THE WATER DRAINS THROUGH A SEDIMENT TRAP.

GRAVEL CONSTRUCTION ENTRANCE DETAIL NO SCALE

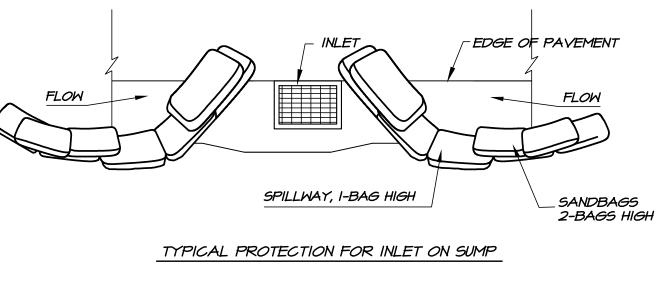

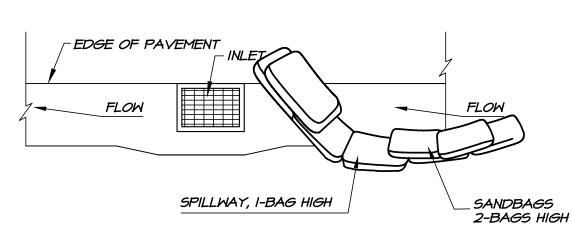


TYPICAL PROTECTION FOR INLET ON GRADE

# NOTES:

- I. INTENDED FOR SHORT TERM USE.
- 2. USE TO INHIBIT NON-STORM WATER FLOW. 3. ALLOW FOR PROPER MAINTENANCE AND CLEANUP.
- 4. BAGS MUST BE REMOVED AFTER ADJACENT OPERATION IS COMPLETED. 5. NOT APPLICABLE IN AREAS WITH HIGH SILTS AND CLAYS WITHOUT FILTER FABRIC.



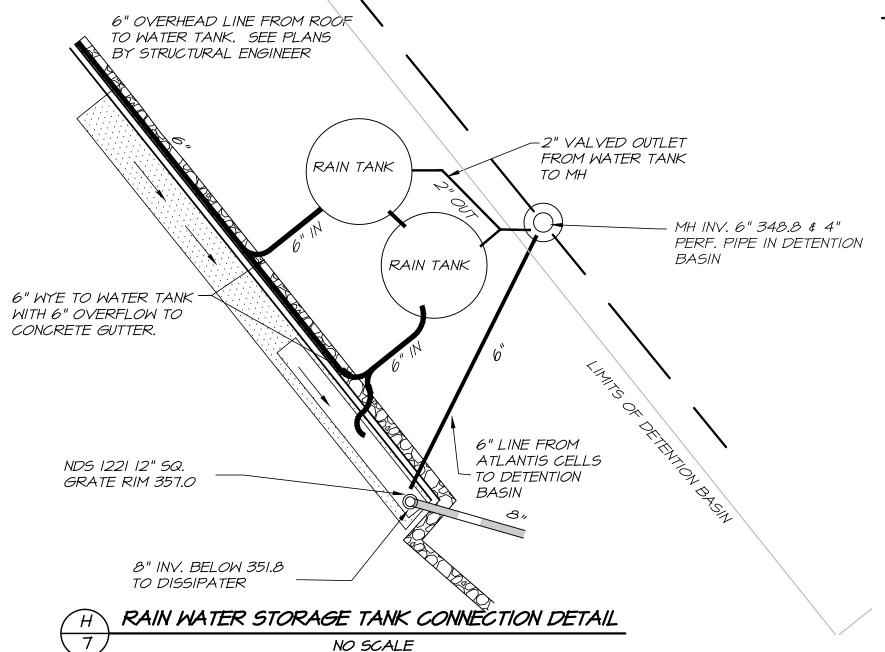



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BRIAN ARDEN WINERY design: JLC drawn: 66 CALISTOGA, CA 945 DETAILS 18 JAN 2012