
EFFLUENT STORAGE POND

CITY OF CALISTOGA UTILITIES DEPARTMENT, CALISTOGA, CALIFORNIA

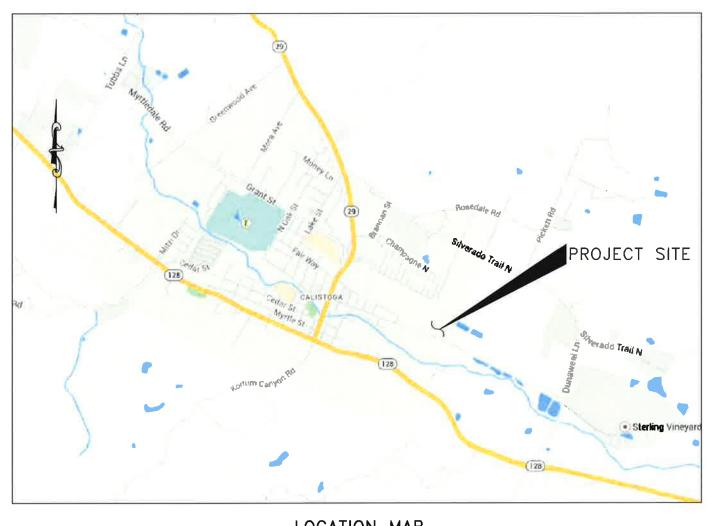



LOCATION MAP

VICINITY MAP

DRAFT 100% SUBMITTAL SEPT 2014

URS

NOT FOR CONSTRUCTION

ABBREVIATIONS

AB AC ADD ALT	AGGREGATE BASE ASPHALT CONCRETE ADDITION(AL) ALTERNATE	PL, PL PS PVC PVMT	PLATE OR PROPERTY LINE PUMP STATION POLYVINYL CHLORIDE PAVEMENT	
APPROX ASSY AV AVG	APPROXIMATE ASSEMBLY AIR VALVE AVERAGE	R RCL RD REF	RADIUS, RISER RECLAIMED WATER LINE ROAD REFERENCE	
BLDG BOT BO	BUILDING BOTTOM BLOW-OFF	REQ'D RT	REQUIRED RIGHT	
BOF BRG	BOTTOM OF FOOTING BEARING	S SCH SECT	SLOPE SCHEDULE SECTION	
CB CF CI	CATCH BASIN CUBIC FEET CAST IRON	SHT	SHEET	
CJ CLR CLSM	CONSTRUCTION JOINT CLEARANCE CONTROLLED LOW STRENGTH MATERIAL	SPEC SQ SS	SPECIFICATION(S) SQUARE SANITARY SEWER	
CO CONC CONST	CLEAN OUT CONCRETE CONSTRUCTION	STD STL SD	STANDARD STEEL STORM DRAIN	
CTR CY	CENTER CUBIC YARD	STRUCT SURF	STRUCTURE SURFACE	
DI	DUCTILE IRON	TYP	TYPICAL	
DIA DIAG DIM	DIAMETER DIAGRAM DIMENSION	UG UON	UNDERGROUND UNLESS OTHERWISE NOTED	
DWG	DRAWING	V VERT	VALVE VERTICAL	
EL ELEC	ELEVATION ELECTRICAL	VIF VOL	VERIFOR IN FIELD VOLUME	
EQ EQUIP	EQUAL EQUIPMENT	VOL	VOLUME	
EPR EXIST	EROSION PROTECTION ROCK EXISTING	W/ W	WITH WIDTH, WEST, WATER	
EXP	EXPANSION	WS WSL	WATER SURFACE WATER SURFACE LEVEL	
FDN FG	FOUNDATION FINISHED GRADE	WV	WATER VALVE	
FL FT	FLOW LINE FOOT	YD	YARD	
GV	GATE VALVE	(N)	NEW	-
H	HEIGHT	(E)	EXISTING	
HORIZ.	HORIZONTAL			
ID IN	INSIDE DIAMETER INCH			-
INFO INST	INFORMATION INSTRUMENTATION			
INV IRR	INVERT IRRIGATION			
JT	JOINT			
L LB	LENGTH POUND			
LT	LEFT			
MAX MCA	MAXIMUM MATERIAL CLASSIFICATION AREA			
MFR MH	MANUFACTURE(R) MANHOLE			
MIN MISC	MINIMUM, MINUTE MISCELLANEOUS			
NOM	MOMINIAL			
NOM NTS	NOMINAL NOT TO SCALE			


SYMBOLS

Ę.	CENTER LINE
*	EXPLORATORY BORING
ø	DIAMETER
\Leftrightarrow	TREE, SHRUB
₹	WATER LEVEL ELEVATION
ARY	AIR VALVE
Œ	BLOW-OFF
œ	BACKFLOW
×	WATER VALVE
(3)	MANHOLE (STORM DRAIN)
\$	MANHOLE (SANITARY SEWER)
#	NUMBER
	NATURAL GROUND OR GRADE
	BACKFILL
	BACKFILL AC BERM
1.5:1	AC BERM SLOPE GRADIENT
1.5:1	AC BERM SLOPE GRADIENT (HOR. : VERT.)
1.5:1	AC BERM SLOPE GRADIENT (HOR. : VERT.) STORM DRAIN MANHOLE
1.5:1	AC BERM SLOPE GRADIENT (HOR.: VERT.) STORM DRAIN MANHOLE WATER VALVE
1.5:1	AC BERM SLOPE GRADIENT (HOR.: VERT.) STORM DRAIN MANHOLE WATER VALVE CATCH BASIN
1.5:1	AC BERM SLOPE GRADIENT (HOR.: VERT.) STORM DRAIN MANHOLE WATER VALVE CATCH BASIN FENCE

CENTER LINE FLOW LINE

TYPICAL SECTION/ELEVATION/DETAIL SYSTEM

SECTIONS & ELEVATIONS ARE DESIGNATED BY LETTER. DETAILS ARE DESIGNATED BY NUMBERS.

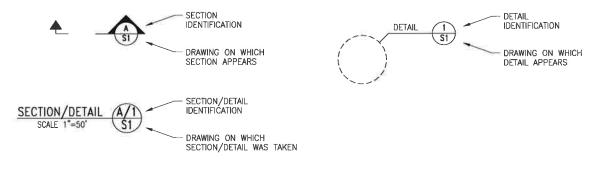

	DRAWING INDEX
SHEET NUMBER	TITLE
G1 G2 G3 D1 C1 C2 C3 C4 C5 M1	COVER SHEET DRAWING INDEX ABBREVIATIONS AND SYMBOLS GENERAL NOTES SITE ACCESS AND STAGING PLAN DEMOLITION PLAN SITE PLAN AND EXISTING CONDITIONS GRADING PLAN EMBANKMENT DETAILS ENVIRONMENTAL MITIGATION RAIL CAR BRIDGE DETAIL EXISTING PIPELINE, FITTINGS AND APPURTENANCES NEW PIPELINE, FITTINGS AND APPURTENANCES

NOT FOR CONSTRUCTION

	REVISIONS		
VO.	DESCRIPTIONS	BY	DATE
Δ			
\			
\wedge			
\wedge			

ON CENTER
OUTSIDE DIAMETER
OUTSIDE FACE
ORIGINAL GROUND SURFACE

OC OD OF OG

CITY OF CALISTOGA 1232 WASHINGTON ST CALISTOGA, CALIFORNIA 94515



DRAWN BY:	C	SOMERA
DESIGNED BY:	М	PATEL
CHECKED BY:	С	SMITH
APPROVED BY:	С	SMITH



EFFLUENT	STORAGE POND
CITY O	F CALISTOGA

URS JOB NO. 26818894 DATE SEPTEMBER 5, 2014 SCALE AS SHOWN SHEET _____ OF _____ SHEETS

DRAWING INDEX, ABBREVIATIONS AND SYMBOLS SHEET NO.

G1

GENERAL NOTES:

- NOTES, TYPICAL DETAILS, AND SCHEDULES APPLY TO ALL WORK, UNLESS OTHERWISE NOTED. FOR CONDITIONS NOT SPECIFICALLY SHOWN, CONTRACTOR SHALL PROPOSE A VIABLE DETAIL TO THE ENGINEER FOR REVIEW AND APPROVAL
- FIELD-VERIFY ALL EXISTING CONDITIONS, INCLUDING ALL EXISTING AND NEW DIMENSIONS, PRIOR TO THE START OF WORK, ANY APPROVAL OF SUBMITTALS OR SHOP DRAWINGS BY THE ENGINEER SHALL NOT RELIEVE CONTRACTOR OF HIS RESPONSIBILITIES. IT IS CONTRACTOR'S SOLE RESPONSIBILITY TO MEET ALL REQUIREMENTS OF CONTRACT PLANS, CONTRACT SPECIFICATIONS, CURRENT CODES, INDUSTRY STANDARDS AND PRACTICES, AND ALL OTHER APPLICABLE STANDARDS.
- 3. CONTRACTOR SHALL COORDINATE STRUCTURAL DRAWINGS WITH PLUMBING, MECHANICAL, AND ELECTRICAL UTILITIES PRIOR TO THE START OF WORK. CONTRACTOR SHALL NOTIFY THE ENGINEER OF ANY DISCREPANCY. DO NOT PROCEED WITH WORK UNTIL DISCREPANCY HAS BEEN RESOLVED.
- 4. UNLESS OTHERWISE NOTED, USE TYPICAL DETAILS WHERE APPLICABLE. VERIFY APPLICABILITY WITH THE ENGINEER IF NEEDED.
- NOTES AND DETAILS SHOWN ON A PARTICULAR DRAWING SHALL TAKE PRECEDENCE OVER GENERAL NOTES AND TYPICAL DETAILS.
- 6. DIMENSIONS SHALL TAKE PRECEDENCE OVER GENERAL NOTES AND TYPICAL DETAILS
- CONTRACTOR SHALL SUBMIT SHOP DRAWINGS AS REQUIRED BY SPECIFICATIONS
 TO THE ENGINEER FOR REVIEW AND APPROVAL PRIOR TO START OF
 FARBICATION
- 8. CONTRACTOR SHALL BE SOLELY RESPONSIBLE FOR THE SAFETY OF ALL PERSONNEL AND THE PROTECTION OF ALL PROPERTY ON THE PROJECT SITE AT ALL TIMES. THE PRESENCE OF THE ENGINEER SHALL NOT RELIEVE CONTRACTOR OF HIS RESPONSIBILITIES. SHOULD ANY DAMAGE TO EXISTING PROPERTY OCCUR, CONTRACTOR SHALL SUBMIT PROPOSED REMEDY TO THE ENGINEER FOR REVIEW AND APPROVAL AND REPAIR THE DAMAGE TO THE SATISFACTION OF THE ENGINEER AT NO COST TO THE CITY.
- 9. CONTRACTOR SHALL SUBMIT ANY SUBSTITUTION OF SPECIFIED MATERIAL TO THE ENGINEER FOR REVIEW AND APPROVAL PRIOR TO INSTALLATION. REFER TO GENERAL CONDITION OF CONTRACT SPECIFICATION FOR THE MINIMUM NUMBER OF DAYS REQUIRED FOR THE ENGINEER'S REVIEW AND APPROVAL. ANY DELAY AS A RESULT OF NONCONFORMANCE TO THIS REQUIREMENT SHALL BE THE SOLE RESPONSIBILITY OF THE CONTRACTOR.
- 10. THE CONTRACTOR'S TEMPORARY MEASURES SHALL BE ARRANGED OR DESIGNED SO AS NOT TO ALTER OR AFFECT THE PERMANENT STRUCTURE.
- 11, DO NOT SCALE DRAWINGS, USE DIMENSIONS SHOWN.
- 12 INSTALL ALL WORK PLUMB, LEVEL AND STRAIGHT.
- 13, INSTALL MANUFACTURED MATERIALS AND EQUIPMENT ACCORDING TO MANUFACTURERS RECOMMENDATIONS AND INSTRUCTIONS.
- 14. IT IS THE RESPONSIBILITY OF THE CONTRACTOR TO BE KNOWLEDGEABLE ABOUT AND OBEY ALL PERMIT REQUIREMENTS WHILE PERFORMING THE WORK SHOWN ON THESE PLANS.
- 15. THE CONTRACTOR SHALL HAVE COPIES OF THE APPROVED PLANS AND SPECIFICATIONS FOR THIS PROJECT ON THE SITE AT ALL TIMES, AND THE CONTRACTOR SHALL BE FAMILIAR WITH ALL APPLICABLE STANDARDS AND SPECIFICATIONS.

FOUNDATION DESIGN:

1. ALL SITE GRADING, FILLS AND SOIL PREPARATION SHALL CONFIRM TO THE SPECIFICATIONS AND ALL WORK SHALL BE UNDER THE SUPERVISION OF THE CITY & URS GEOTECHNICAL REPRESENTATIVE, AND A MATERIAL TESTING LABORATORY HIRED OF EMPLOYED BY THE CONTRACTOR

EARTHWORK SUMMARY AND NOTES:

CUT: 52170 CY FILL: 43210 CY TOTAL STORAGE VOLUME: 50 AF IMPOUNDED VOLUME: 29 AF

THE VOLUMES SHOWN HERE ARE APPROXIMATE CALCULATIONS BASED ON THE DIFFERENCE BETWEEN EXISTING GROUND ELEVATIONS AND FINISHED ROUGH GRADE ELEVATIONS. THE CALCULATIONS MAKE NO PROVISION FOR STRIPPING OR UNEXCAVATION. FOR THIS REASON AND BECAUSE OF VARIABLES SUCH AS COMPACTION, SHRINKAGE, BULKING AND THE CONTRACTOR'S METHODS OF OPERATION, THE VOLUME OF SOIL MOVED IN THE FIELD WILL IN ALL LIKELIHOOD DEVIATE TO SOME EXTENT FROM THE CALCULATED VOLUME. THE EARTHWORK SUMMARY DOES NOT RELIEVE THE CONTRACTOR OF THEIR RESPONSIBILITY TO DETERMINE ON THEIR OWN THE QUANTITY OF EARTH MOVING THAT WILL BE REQUIRED TO GRADE THIS JOB. IT IS ASSUMED THAT THE CONTRACTOR'S BID PRICE FOR GRADING IS BASED ON THE CONTRACTOR'S OWN EARTHWORK ESTIMATE AND INCLUDED PROVISIONS FOR ANY GRADE ADJUSTMENT REQUIRED TO BRING THE JOB TO FINISHED GRADE.

ENVIRONMENTAL MITIGATION

- CONSTRUCTION WILL AVOID ALL IMPACTS TO THE BED, BANK, WATER QUALITY, OR HABITAT WITHIN THE EXISTING DRAINAGE SWALES THROUGH ENVIRONMENTALLY SENSITIVE AREA ENCINC
- 2. IF WORK IS PERFORMED DURING THE NESTING SEASON OR MIGRATORY BIRDS AND RAPTORS (APPROXIMATE FEBRUARY 15 TO AUGUST 31) A QUALIFIED BIOLOGIST WILL CONDUCT PRE—CONSTRUCTION NESTING BIRD SURVEYS IN THE CONSTRUCTION AREA PRIOR TO GROUND DISTURBING ACTIVITIES.
- 3. IN THE EVENT A SPECIAL-STATUS SPECIES IS ENCOUNTERED IN THE CONSTRUCTION LIMITS, WORK ACTIVITIES IN THE ACTION AREA WILL BE HALTED IMMEDIATELY AND THE APPROPRIATE AGENCY WILL BE CONTACTED.

DATUM

VERTICAL DATUM: NAVD88
HORIZONTAL DATUM: CALIFORNIA SYSTEM, ZONE 2, NAD83

SURVEY

SURVEY BY URS. MAY 2014

EXISTING UTILITIES

- 1. CONTRACTOR SHALL NOTIFY UNDERGROUND SERVICE ALERT (USA) PRIOR TO DIGGING.
- LOCATIONS OF ALL UTILITY SERVICE LINES SHOWN ON THE DRAWINGS ARE APPROXIMATE ONLY AND SHALL BE FIELD VERIFIED BY POTHOLING PRIOR TO COMMENCING ANY GRADING, TRENCHING OR TUNNEL EXCAVATION.
- 3. UTILITIES, EXISTING AT THE TIME OF CONSTRUCTION, ARE SHOWN ON THESE PLANS FOR CONVENIENCE OF THE CONTRACTOR. THE EXISTENCE AND LOCATION OF UNDERGROUND UTILITY PIPES AND/OR STRUCTURES, AS SHOWN, ARE BASED ON INFORMATION OBTAINED FROM AVAILABLE RECORDS AND/OR IN ACCORDANCE WITH TYPICAL LOCATIONS NOTED IN AGENCY STANDARDS.
- 4. THE CONTRACTOR SHALL TAKE PRECAUTIONARY MEASURES TO PROTECT UTILITY LINES AND STRUCTURES SHOWN AS WELL AS ANY AND ALL OTHERS NOT OF RECORD OR NOT SHOWN ON THESE PLANS. EXISTING UTILITY SERVICE LATERALS ARE SPECIFICALLY NOT SHOWN ON THESE PLANS AND ARE TO BE PROTECTED BY THE CONTRACTOR DURING PIPELINE CONSTRUCTION.
- ALL CONTRACTOR WORK AROUND EXISTING UTILITIES SHALL BE IN CONFORMANCE WITH CALIFORNIA GOVERNMENT CODE 4216.
- 5. THE CONTRACTOR SHALL PROTECT IN PLACE ALL OVERHEAD INTERFERENCE. THE CONTRACTOR SHALL USE EXTREME CAUTION WHEN WORKING NEAR OVERHEAD OR UNDERGROUND POWER, GAS, AND/OR OTHER UTILITIES SO AS TO SAFELY PROTECT ALL PERSONNEL AND EQUIPMENT, AND SHALL BE RESPONSIBLE FOR ALL COSTS AND LIABILITY IN CONNECTION THEREWITH.

DEMOLITION NOTES

- CLEAR AND REMOVE ALL ORGANIC MATTER, DEBRIS, AND RUBBISH FROM WITHIN THE LIMIT OF WORK, CONTRACTOR SHALL DISPOSE OF SAID MATERIAL IN A LEGAL MANNER AS HIS PROPERTY.
- CONTRACTOR MAY RE-USE MATERIAL SUBJECT TO SUBMITTALS PER SPECIFICATION AND REVIEW BY THE CITY REPRESENTATIVE.
- 3. SAVE AND STOCKPILE TOPSOIL FOR USE ON EXPOSED CUT AND FILL AREAS.

PROJECT CONTACTS

OWNER: CITY OF CALISTOGA PUBLIC WORKS DEPARTMENT 414 WASHINGTON STREET CALISTOGA, CA 94515 PHONE: (707) 942–2828

ENGINEER: URS CORPORATION 1333 BROADWAY, SUITE 800 OAKLAND, CA 94612 PHONE: (510) 893-3600

CALISTOGA FIRE DEPARTMENT: (707) 942-2840 CALISTOGA POLICE DEPARTMENT: (707) 942-2810

NOT FOR CONSTRUCTION

REVISIONS
DESCRIPTIONS
BY. DATE

CITY OF CALISTOGA 1232 WASHINGTON ST CALISTOGA, CALIFORNIA 94515



DRAWN BY:	C SOMERA
DESIGNED BY:	M PATEL
CHECKED BY:	C SMITH
APPROVED BY:	C SMITH



EFFLUENT STORAGE POND CITY OF CALISTOGA DATE SEPTEMBER 5, 2014
SCALE AS SHOWN

GENERAL NOTES

SHEET NO.

SHEE







PLAN SCALE: NTS

NOTES:

- 1. ALL EARTHWORK ACTIVITY SHALL BE PERFORMED THROUGH THE PRIMARY SITE ACCESS.
- 2. USE OF SECONDARY SITE ACCESS SHALL BE LIMITED AND AS AUTHORIZED BY THE CITY,

NOT FOR CONSTRUCTION

80	REVISIONS		
NO.	DESCRIPTIONS	BY.	DATE
\triangle			

CITY OF CALISTOGA 1232 WASHINGTON ST CALISTOGA, CALIFORNIA 94515



DRAWN 8Y:	C SOMERA
DESIGNED BY:	M PATEL
CHECKED BY:	C SMITH
APPROVED BY:	C SMITH

URS
1333 Broadway, Ste. 800 Oakland, Ca 94612

	STORAGE		
CITY O	F CALISTO	GA	

URS JOB NO. 26818894

IMIE SEPTEMBER 5, 2014


SCALE AS SHOWN


SHEET OF SHEETS


SHEET NO.

G3

STAGING AND ACCESS ROAD PLAN

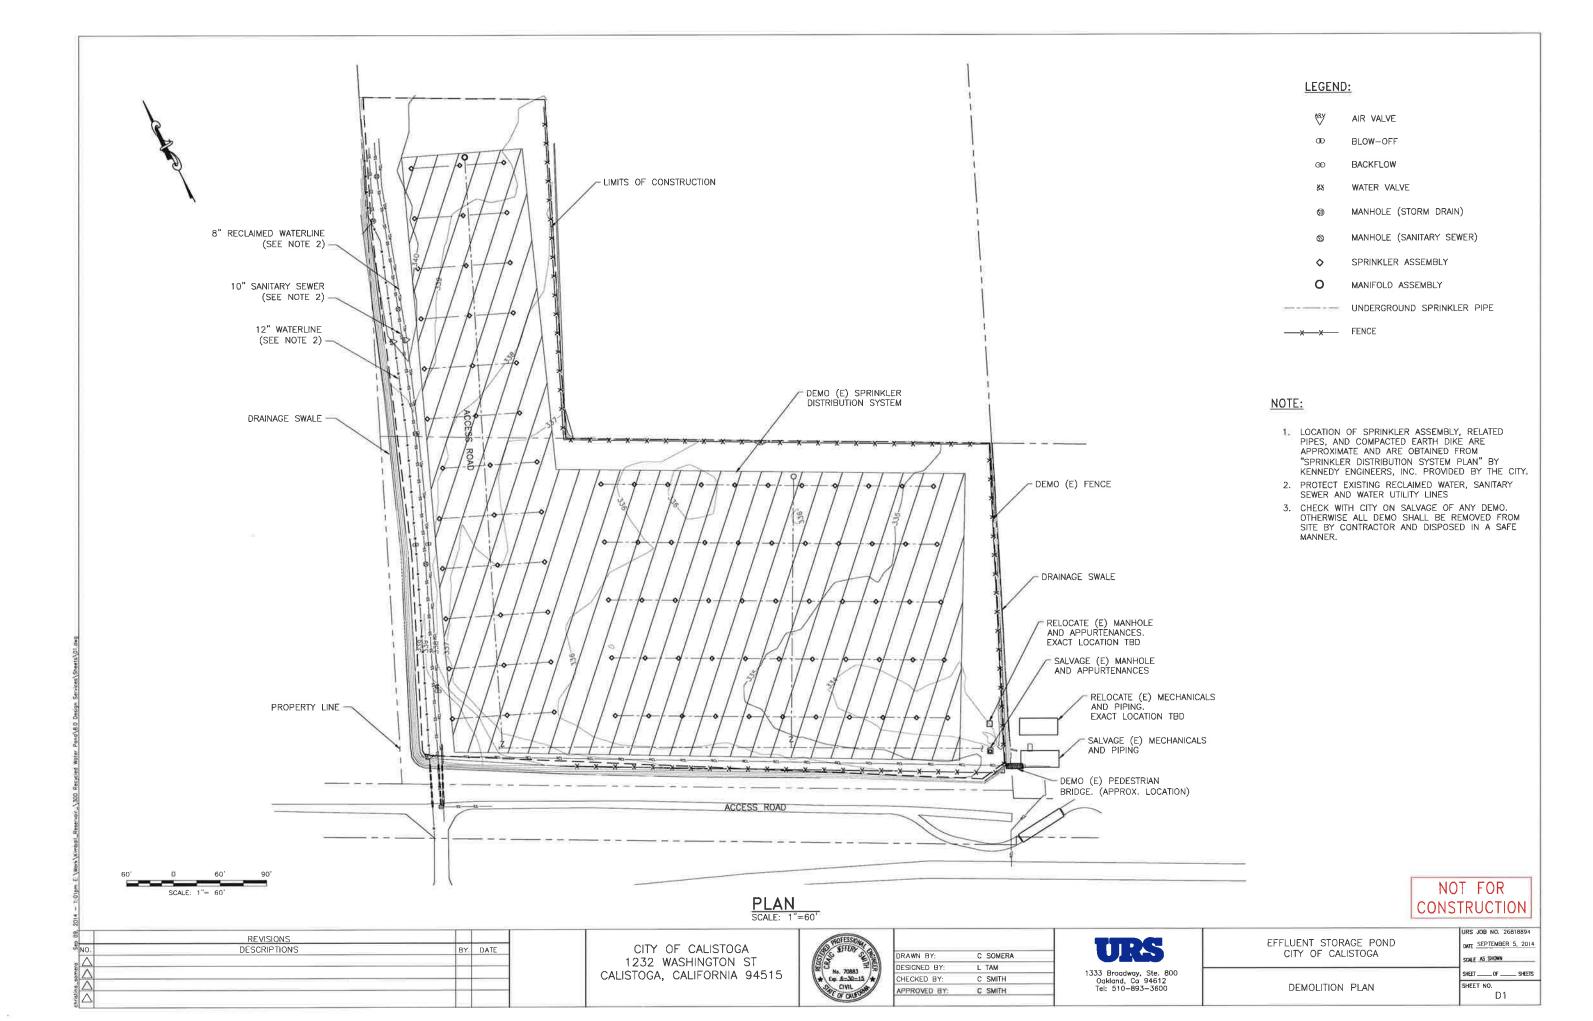

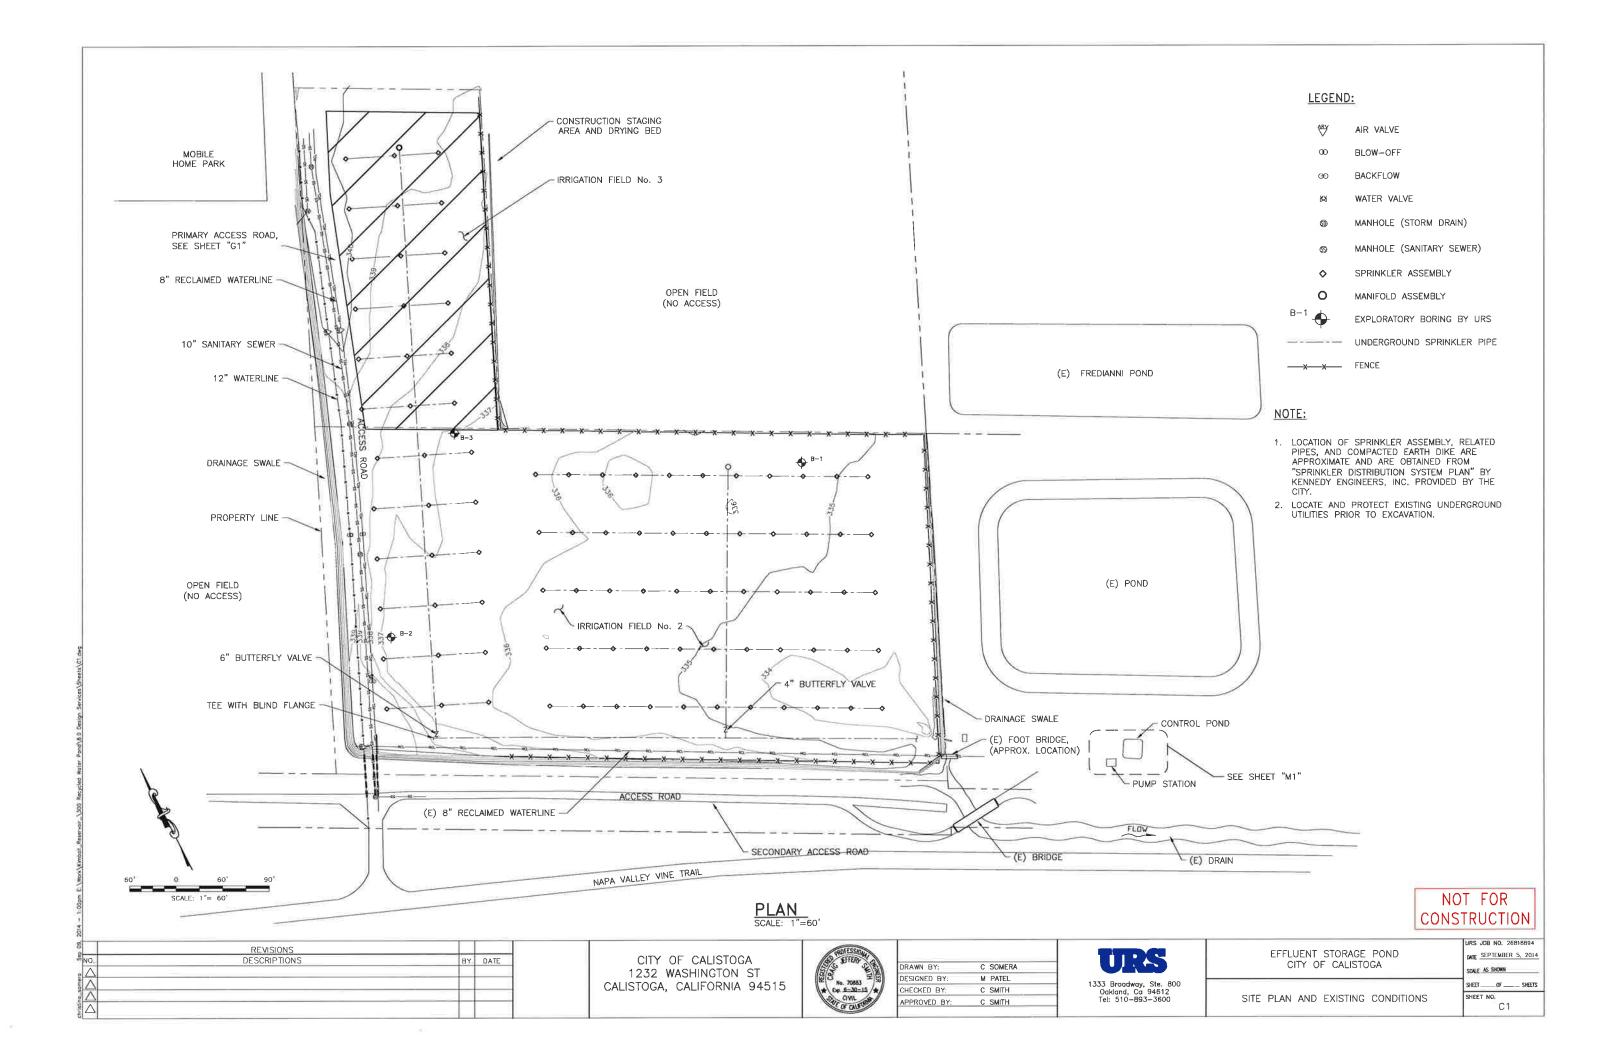

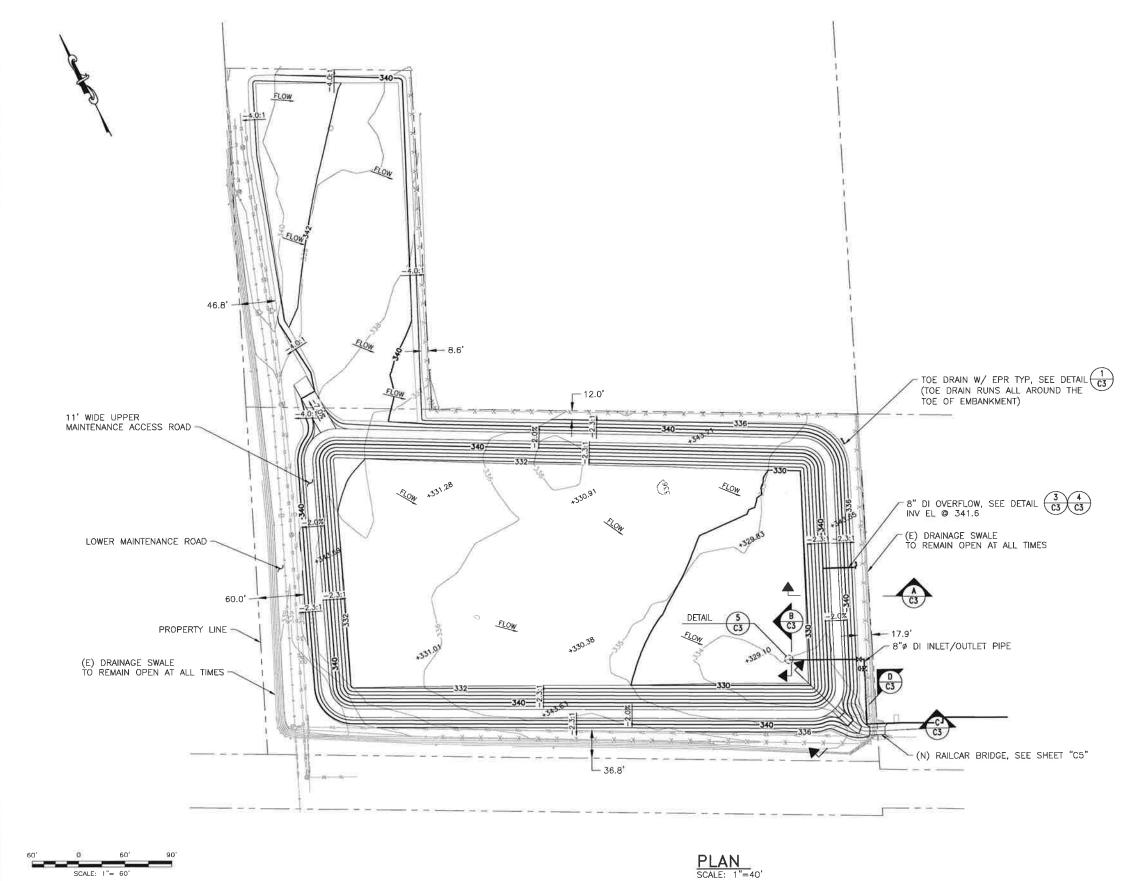

NOT FOR CONSTRUCTION

BY DATE

CITY OF CALISTOGA 1232 WASHINGTON ST CALISTOGA, CALIFORNIA 94515





DRAWN BY:	C SOMERA
DESIGNED BY:	M PATEL
CHECKED BY:	C SMITH
APPROVED BY:	C SMITH

URS
1333 Broadway, Ste. 800 Oakland, Ca 94612
Tel: 510 903 3600

-111	JK3 00B 140. 20010054
1	DATE SEPTEMBER 5, 2014
	SCALE AS SHOWN
٦	SHEET OF SHEETS
- 4	
1	SHEET NO.

GRADING PLAN

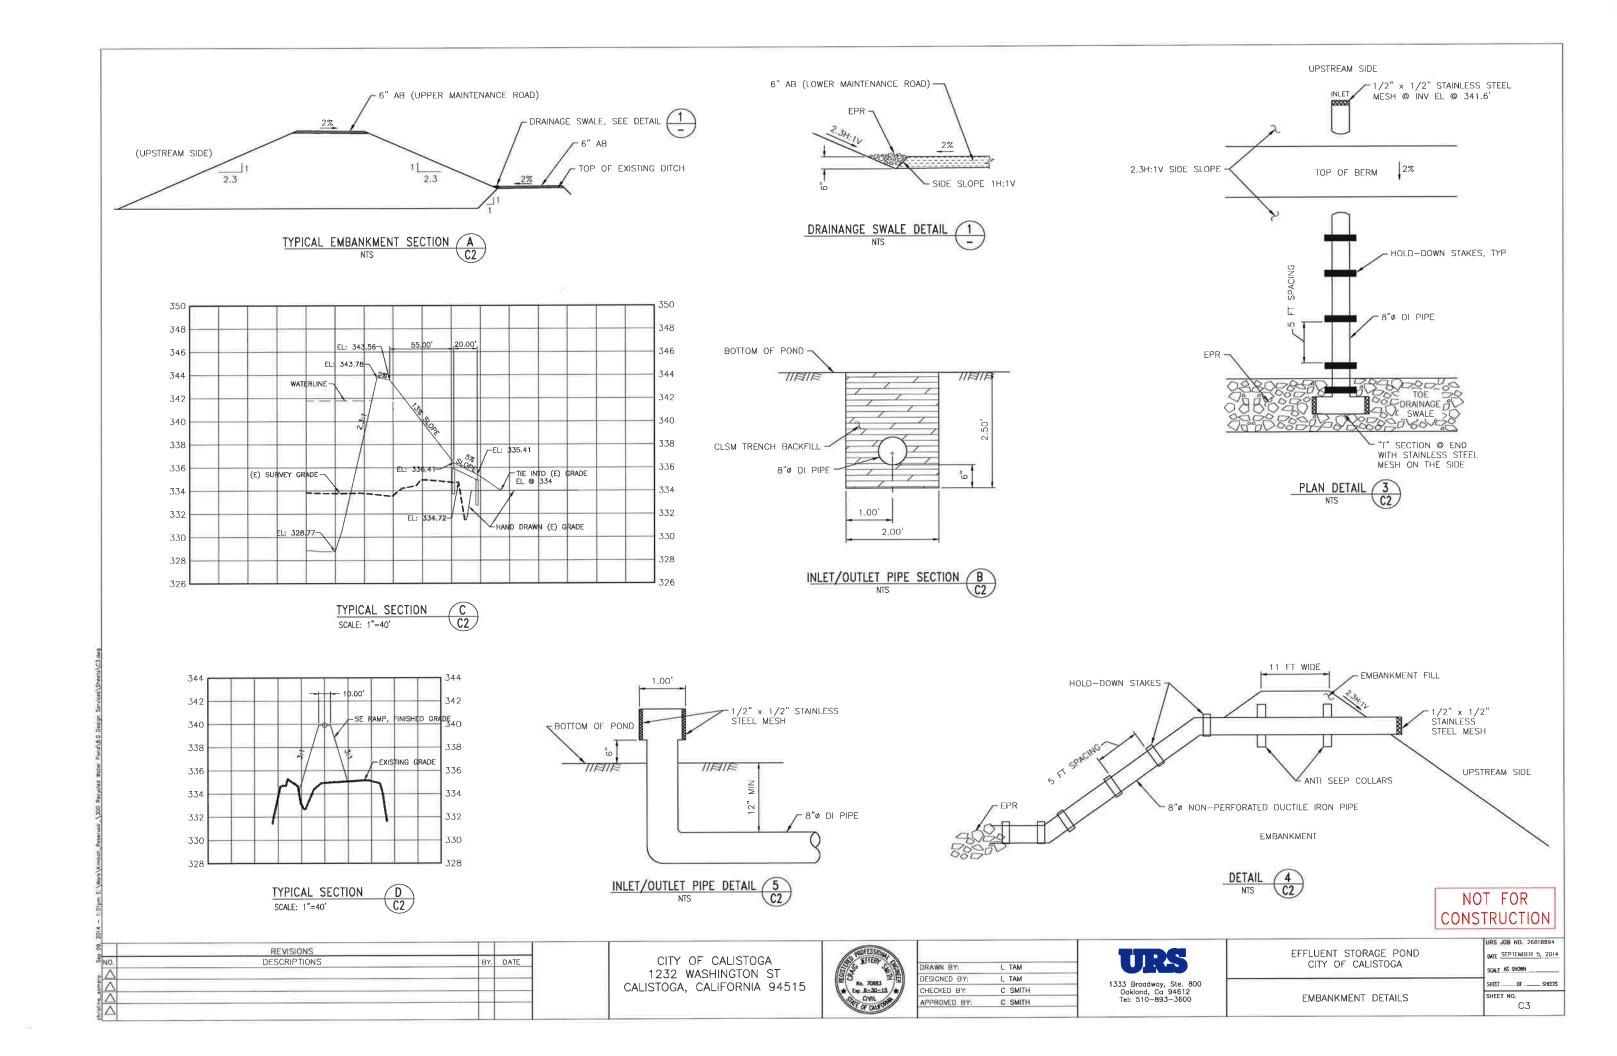

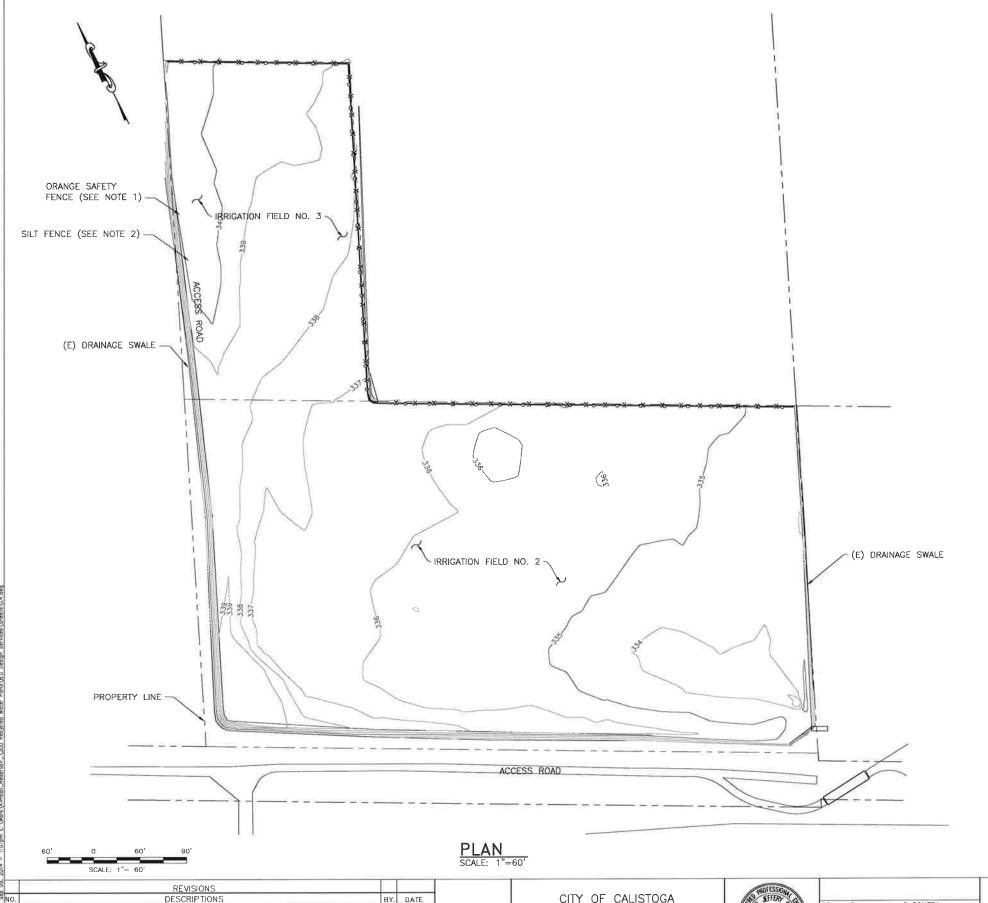

LEGEND:


---- ENVIRONMENTAL EXCLUSION FENCE

----- CONSTRUCTION AREA FENCE

NOTE:

- 1. INSTALL ORANGE SAFETY FENCE AT 1 FOOT OFFSET FROM (E) DRAINAGE SWALE.

 2. INSTALL SILT FENCE AT 1 FOOT OFFSET FROM ORANGE SAFETY FENCE. KEY IN MIN 6 INCHES.

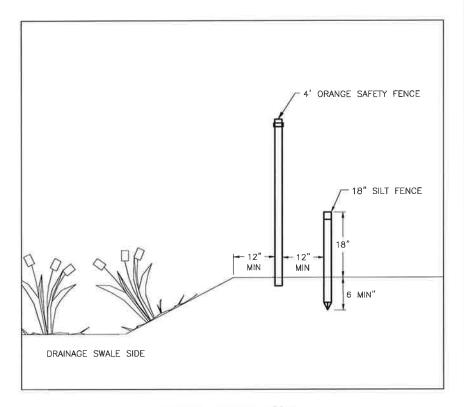

FENCING, SECTION DETAIL

NTS

NOT FOR CONSTRUCTION

	REVISIONS		
NO.	DESCRIPTIONS	BY.	DATE
Δ			
\triangle			
\triangle			
\triangle			

CITY OF CALISTOGA 1232 WASHINGTON ST CALISTOGA, CALIFORNIA 94515



DRAWN BY:	C SOMERA
DESIGNED BY:	L TAM
CHECKED BY:	C SMITH
APPROVED BY:	C SMITH


URS
1333 Broadway, Ste. 800 Oakland, Ca 94612 Tel: 510—893—3600


EFFLUENT	STORAGE	POND
CITY O	F CALISTO)GA


ENVIRONMENTAL MITIGATION

DATE SEPTEMBER 5, 2014
SCALE AS SHOWN
SHEET OF SHEETS
SHEET NO.
C4

URS JOB NO. 26818894

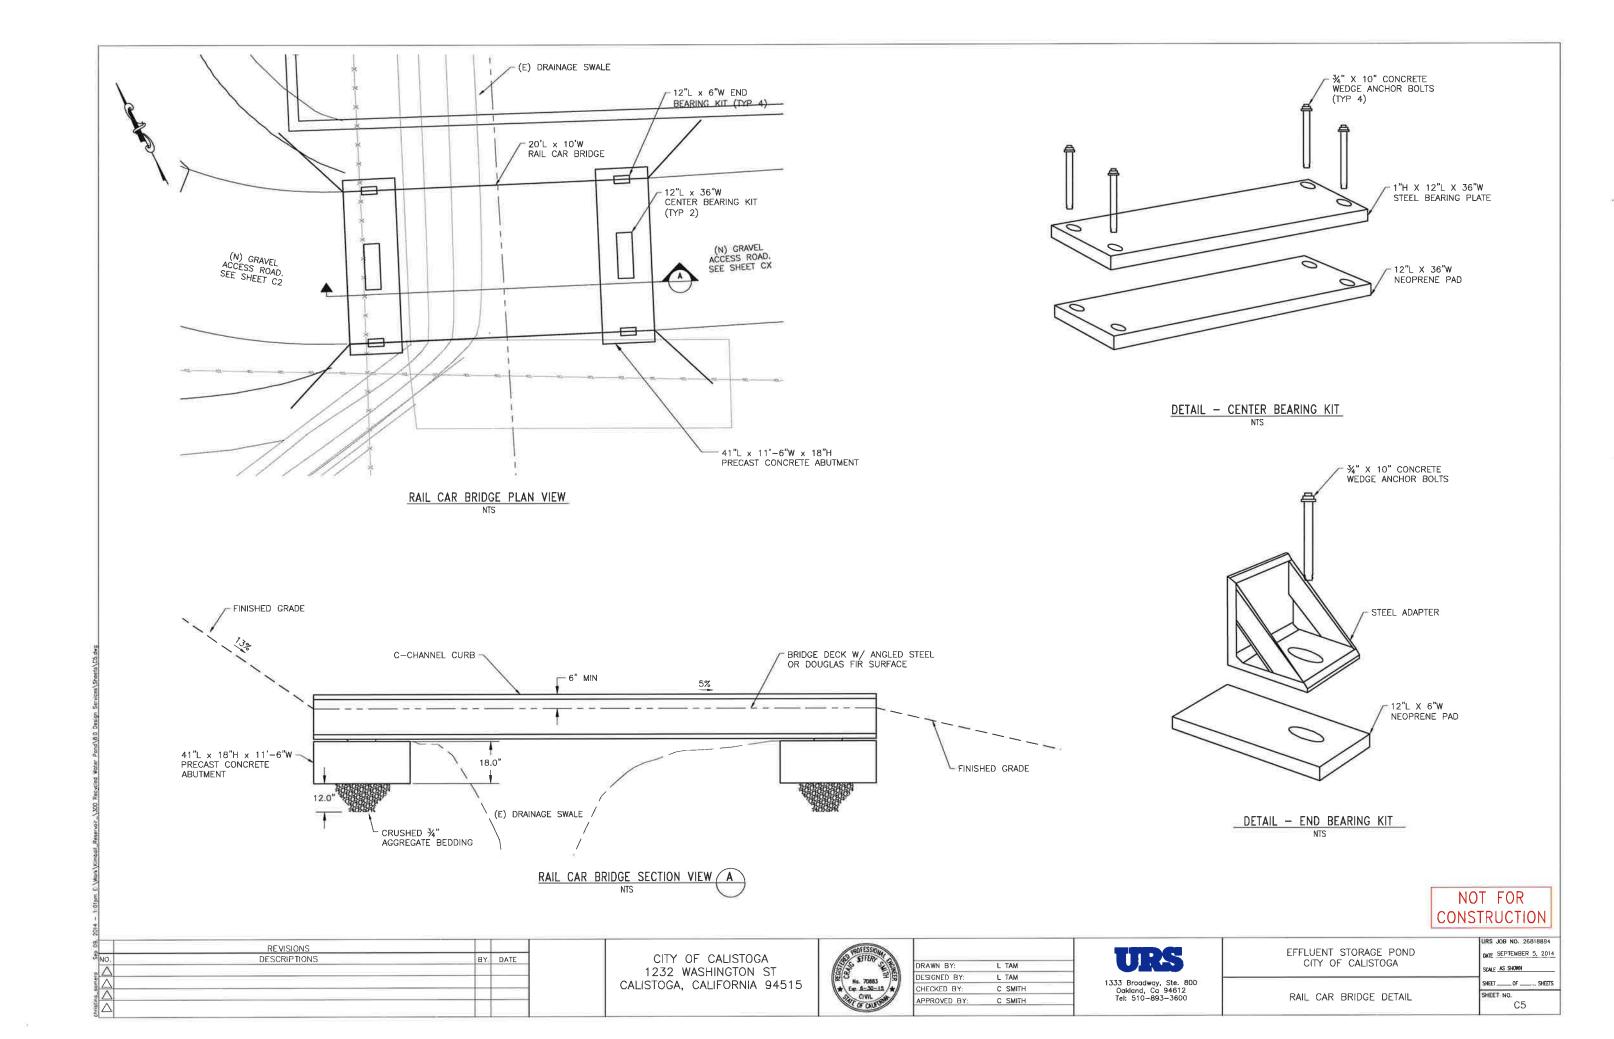


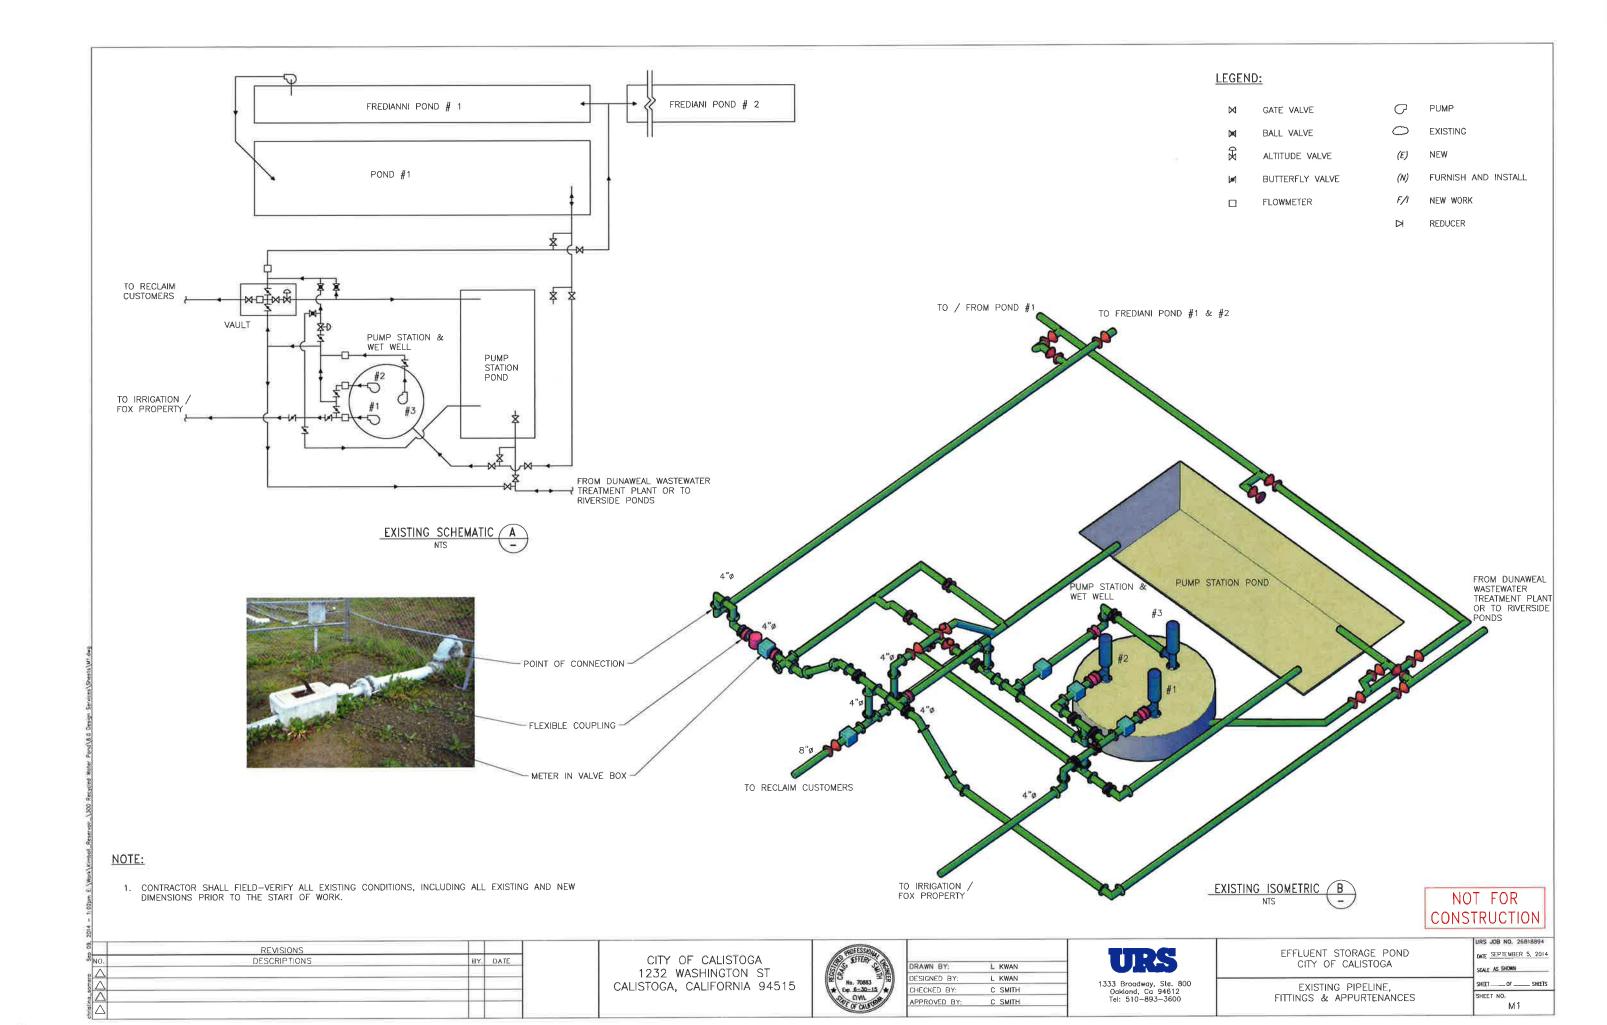

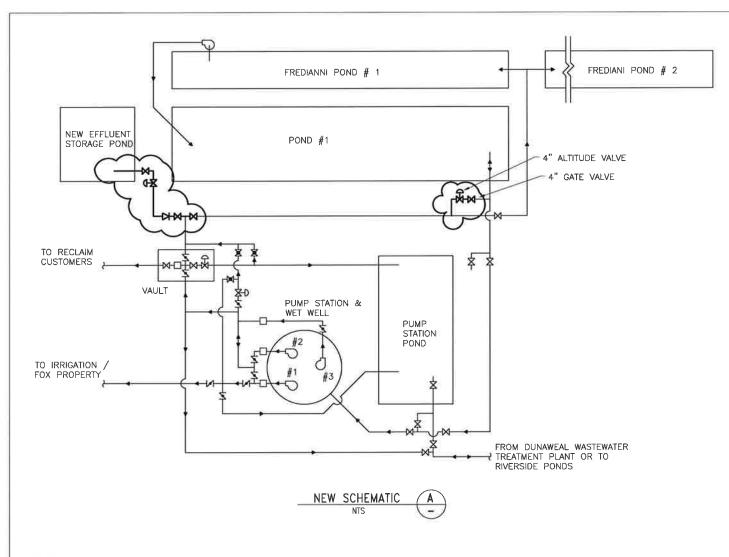

NOTE:

- 1. CONTRACTOR MAY NOT RE-USE SALVED MATERIAL WITHOUT REVIEW BY THE CITY AND AS INDICATED ON THE SUBMITTALS PER SPECIFICATIONS.
- 2. THE LOCATIONS AND ELEVATIONS OF THE POINTS OF CONNECTION ARE APPROXIMATE AND WILL REQUIRED FIELD VERIFICATION BY THE CONTRACTOR.
- 3. PROVIDE CEMENT MORTAR LINED DUCTILE IRON PIPELINE AND FITTINGS CONFORMING TO AWWA 150 AND AWWA 151. THE MINIMUM PRESSURE CLASS SHALL BE CLASS 150.
- 4. BURIED PIPELINE AND FITTINGS SHALL BE POLYETHYLENE ENCASED. CONNECTIONS SHALL BE RESTRAINED MECHANICAL JOINT TYPE.
- 5. EXPOSE PIPELINE AND FITTINGS SHALL BE EPOXY COATED. CONNECTION SHALL BE FLANGED TYPE.
- 6. ALL NUTS, BOLTS, WASHERS, AND FASTENERS SHALL BE ZINC COATED STEEL GRADE 5 OR BETTER.
- 7. SUBMIT WORK PLANS FOR HYDROSTATIC PRESSURE TESTS. THE CONTRACTOR IS RESPONSIBLE FOR QUANTITY TAKEOFFS ASSOCIATED WITH HYDROSTATIC TESTING.
- 8. BURIED VALVES SHALL BE HOUSED IN VALVE BOX.
- 9. THE ALTITUDE VALVE RESERVOIR PRESSURE SENSING LINE SHOULD BE 3/4" MINIMUM INTERNAL DIAMETER AND INSTALLED WITH A 2' UPWARD SLOPE. MATERIALS SHALL BE COPPER OR PVC SCHEDULE 80.
- 10. CONTRACTOR TO FURNISH AND INSTALL ALL PIPING, FITTING, VALVING, AND INCIDENTALS FOR THE SUCCESSFUL COMPLETION OF WORK.

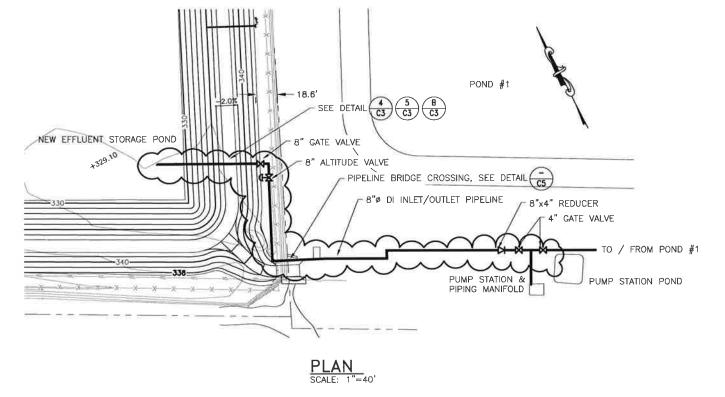



	REVISIONS		
40.	DESCRIPTIONS	BY.	DATE
Δ			
Λ			
Δ			
\triangle			

CITY OF CALISTOGA 1232 WASHINGTON ST CALISTOGA, CALIFORNIA 94515



DRAWN BY:	L	KWAN
DESIGNED BY:	L	KWAN
CHECKED BY:	С	SMITH
APPROVED BY:	С	SMITH

URS
1333 Broadway, Ste. 800 Oakland, Ca 94612 Tel: 510—893—3600

EFFLUE	NT	STORAGE	POND
CITY	OF	CALISTO)GA

NEW PIPELINE, FITTINGS & APPURTENANCES

URS	108	NO.	26	818	894
DATE	SEP	TEME	IER	5,	2014
SCALE	AS	SHOW	_		_
-					

M2

NOT FOR CONSTRUCTION