# IMPER RESIDENCE, 1998 CEDAR STREET

#### CONSULTANTS

CONSULTANTS
ARCHITECT
PATRICK MERVIN + ASSOC
4868 PETRIFIED FOREST ROAD
CALISTOGA, CA 94515
(707) 942-6540
CONTACT: ALISSA MCNAIR
ALISSA@PMARCHITECT.COM

LANDSCAPE ARCHITECT GEOTECHNICAL ENGINEER BAUER ASSOCIATES ENGINEERS STEVE ARNS LANDSCAPE ARCHITECT 601 MUND ROAD P.O. BOX 460 ST. HELENA, CA 94575-9738 FORESTVILLE CA 95436 (707)963-5736 (707) 252-8105 CONTACT: BRYCE BAUER CONTACT: STEVE ARNS BRYCE@BAUERGEOTECH.COM

ARCHITECTURAL HISTORIAN PAINTER PRESERVATION & PLANNING SALEM OR 97308 (707) 763-6500 CONTACT: DIANA PAINTER D.PAINTER 15@ATT.NET

ARCHAEOLOGICAL RESOURCE SERVICE 3820 BODEGA AVENUE PETALUMA, CA 94952 (707) 762-2573 CONTACT: BILL ROOF

ARBORIST PACIFIC TREE CARE

ALBION SURVEYS, INC. 1113 HUNT AVENUE PO BOX 34 ST. HELENA, CA 94574 CALISTOGA, CA 94515 (707) 942-0261 CONTACT: JAKE SCHNEIDER (707) 963-1217 CONTACT: JON WEBE INFO@PACIFICTREECARE.COM JMEBB@ALBIONSURVEYS.COM

> ENVIRONMENTAL COLLABORATIVE 368 64TH 51REET EMERYVILLE, CA 94608

> > GRANT & CAROL IMPER

1347 DUKE WAY, SAN JOSE, CA 95125

(510) 654-4444

CONTACT: JIM MARTIN INFO@DIGSMART.COM BEACH127@AOL.COM

(E) CITY SEWER (ON-SITE SYSTEM DEMO'D 1994 PER NAPA CTY PERMIT)

ABBREVIATIONS ANCHOR BOLL ABOVE ASPHALTIC CO ADJACENT ALTERNATE ANCOURLD ASPHALT ASPHALT THE AUTOHATIC

RETURN AR
RACHS
RACH SPRAIN
REFERENCE
REFRIGERATI
RESILENT
REVERN
RACH
ROCH
ROCHING
RECHT HAND
ROCHOL
ROCHO HOSE BE HOLLOW CO HEADER HARDWARE HORIZONTAI HEATING SCHOOL CORE
SCREDI
SCRE

 $\begin{pmatrix} 1 \\ A1 \end{pmatrix}$ 

INTERIOR ELEVATION DESIGNATION

SYMBOL LEGEND

SECTION DESIGNATOR

DETAIL DESIGNATION

SHEET NUMBER

















SHEAR WALL DESIGNATOR



PROPOSED LOCATION OF FIRE EXTINGUISHER

MATERIAL LEGEND

CONCRETE STEEL

EARTH GYPSUM BOARD

FILL/SAND

WWW INSULATION

METAL STUD

GRAVEL

M M WOOD STUD

STRUCTURE

## RECEIVED

CABINET
CADEMIN
CATEGORIE
CERANC
CUBIC FOOT
CAST ROT
CAST

DOWSLAS II DIAMETER DIAGONAL DIMBISION DISCON DIAGONAL DAMPER DICANSOAN DOWNSPOL DRAN TILE DELAU DRANING DRANING DRANING DRANING

MAS, MB. MC. MECH MET. MPG MFR. MSG. MSG.

0 C. 085 00 0H 0PG. 0PF.

SEP **25** 2014

CITY OF CALISTOGA

CONSTRUCTION TO COMPLY WITH THE FOLLOWING CODES & REGULATIONS: 2013 CALIFORNIA RESIDENTIAL CODE (CRC) 2013 CALIFORNIA BUILDING CODE (CBC) 2013 CALIFORNIA MECHANICAL CODE (CMC) 2013 CALIFORNIA ELECTRICAL CODE (CEC) 2013 CALIFORNIA PLUMBING CODE (CPC) 2009 CALIFORNIA ENERGY CODE SUPPLEMENT (CEC) - EFFECTIVE 1/1/14 TO 6/30/14 2013 CALIFORNIA FIRE CODE (CFC) 2013 CALIFORNIA EXISTING BUILDING CODE

ALL CURRENT LOCAL CODES & ORDINANCES

#### PROJECT DATA

DIMENSIONS 4 ENGINEERING, INC.

2952 MENDOCINO AVENUE

CONTACT: GARY SPIERINGS

SANTA ROSA, CA 95403

CIVIL ENGINEER

(707) 578-3433

GARY@D4ENET

OWNER

OWNER'S CONTACT (408) 489-5633 / (408) 839-5443 1998 CEDAR STREET, CALISTOGA CA 94515 PROJECT ADDRESS: AP NUMBER MEDIUM DENSITY RESIDENTIAL GENERAL PLAN DESIGNATION: **EXEMPT** GROWTH MANAGEMENT ALLOCATION: SINGLE FAMILY RESIDENCE OCCUPANCY GROUP CONSTRUCTION TYPE FEMA FLOOD ZONE: (MEASURED TO MIDPOINT OF HIGHEST GABLE) STORIES / BUILDING HEIGHT: ONE STORY / 15'-0" (< 25-FT) PROPOSED HOUSE: PROPOSED GARAGE: TWO STORIES / 19'-0" (< 25-FT) EXISTING SHED: ONE STORY / 17'-6" (x 25-FT) 0.1 ACRES / 30,302 SQ FT SIZE OF SITE SITE AREA NOT INCLUDING CREEK: 17 997 SO FT BUILDABLE AREA NOT INCLUDING SETBACKS: EXISTING LOT COVERAGE BY STRUCTURES: 5,304 SQ F PROPOSED LOT COVERAGE BY STRUCTURES: ±19% (< 30%) 2,300 SQ F1 PERMEABLE PATIO AREA: 7,620 SQ FT + 1,180 SQ FT AT SIDEWALK STRIPS PERMEABLE PARKING / DRIVEWAY: PARKING SPACES: THO IN GARAGE (MEASURED AT INTERIOR CORNERS) AREA DATA: EXISTING HOUSE: EXISTING BARN (GARAGE): 139 5Q FT + 313 5Q FT LOFT 230 SQ FT EXISTING SHED: 716 5Q FT EXISTING PORCHES 165 FXISTING + 2,836 NEW = 3,028 SQ FT PROPOSED HOUSE: 739 EXISTING + 113 NEW = 852 SQ FT + 373 SQ FT LOFT PROPOSED BARN (1ST FLOOR) 230 SQ FT (NO CHANGE) PROPOSED SHED 286 EXISTING + 1,235 NEW = 1,520 SQ.FT PROPOSED PORCH

#### HISTORIC RESOURCE ASSESSMENT

REFER TO REPORT PREPARED BY DIANA PAINTER DATED 9/14 & LETTER OF REVIEW DATED 9/16/14

(E) NATURAL GAS

#### ARBORIST REPORT

UTILITIES:

WATER

SEPTIC:

GAS:

REFER TO REPORT PREPARED BY PACIFIC TREE CARE DATED 1/12

#### GEOTECHNICAL REPORT

REFER TO REPORT PERFORMED BY BAUER ASSOCIATES DATED 8/15/11 4 LETTER OF REVIEW DATED 2/19/13

#### CULTURAL RESOURCES EVALUATION

REFER TO REPORT PERFORMED BY ARCHAEOLOGICAL RESOURCES GROUP DATED 9/18/13

#### BIOLOGICAL RESOURCE ASSESMENT

REFER TO REPORT PERFORMED BY ENVIRONMENTAL COLLABORATIVE DATED 3/20/14

# **DRAWING INDEX:**

TITLE SHEET AO.O PROPOSED SITE PLAN AQ 1 EXISTING FLOOR PLANS A1.0 EXISTING EXTERIOR ELEVATIONS A1.1 PROPOSED FLOOR PLANS

PROPOSED EXTERIOR ELEVATIONS A30 PROPOSED EXTERIOR ELEVATIONS A3.1

PROPOSED EXTERIOR ELEVATIONS A3.2

#### LANDSCAPE

LANDSCAPE PLANTING, IRRIGATION, & LIGHTING PLAN L1.0

CIVIL

C2

**C**3

C1

GRADING PLAN SHEET NOTES & DETAILS SHEET


EROSION CONTROL SHEET

SURVEY TOPO-1 MAP OF TOPOGRAPHY

#### SCOPE OF PROJECT:

- 1. REMODELING THE EXISTING 1,398-SQUARE FOOT HOUSE BY RETAINING 165 SQUARE FEET OF THE ORIGINAL STRUCTURE (AS RECOMMENDED BY ARCHITECTURAL HISTORIAN DIANA PAINTER), MOVING THIS SECTION FORWARD ON THE LOT AND CONSTRUCTING A 2,836-SQUARE FOOT, SINGLE-STORY ADDITION AND DECK. THE HOUSE AND DECK WILL BE CONSTRUCTED ON A DRILLED PIER-TYPE FOOTING TO MINIMIZE IMPACT TO THE SITE, THE HOUSE REQUIRES DESIGN REVIEW BY THE
- 2 CONVERTING AN EXISTING 139-SQUARE FOOT BARN INTO AN 852-SQUARE FOOT TWO-CAR GARAGE WITH A 373-SQUARE FOOT STORAGE LOFT, A 113-SQUARE FOOT ADDITION ON THE NORTH SIDE OF THE BARN WILL INCLUDE A STAIR TO ACCESS THE EXISTING LOFT. ITS HEIGHT WILL INCREASE ONE FOOT BECAUSE A CONCRETE SLAB ON GRADE WILL BE INSTALLED TO REPLACE THE DIRT FLOOR ALONG WITH NEW CONCRETE CURBS UNDER THE EXTERIOR WALLS.
- 3. MAKING MINOR REPAIRS TO THE EXISTING 230-SQUARE FOOT SHED, WHICH WAS CONSTRUCTED INTO THE BANK OF CYRUS CREEK PRIOR TO THE EXISTENCE OF BUILDING CODES. THIS STORAGE BUILDING REQUIRES ONLY MINIMAL REPAIRS TO THE ROOF AND EXTERIOR FINISHES TO REMOVE LEAKING SKYLIGHTS, WEATHERIZE, AND MATCH THE ARCHITECTURAL STYLE OF THE NEW RESIDENCE.
- 4.0THER PROPOSED SITE ALTERATIONS INCLUDE DEMOLITION OF THE EXISTING CURB CUT AND INSTALLATION OF A NEW CURB CUT AT THE NEW DRIVEWAY AND GARAGE DOORS; UPGRADING THE SIDEWALK TO CURRENT ACCESSIBILITY STANDARDS; RE-CONNECTION OF EXISTING UTILITIES; REMOVAL AND RELOCATION OF TREES AS NOTED IN THE ARBORIST REPORT; LANDSCAPING; STORM WATER DRAINAGE IMPROVEMENTS: RELOCATION OF THE EXISTING OUTDOOR FIREPLACE: AND MINOR GRADING NEAR THE BACK OF THE HOUSE

### VICINITY MAP:

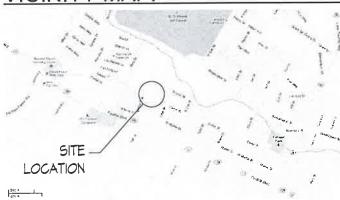

TITLE SHEET



ATRICK




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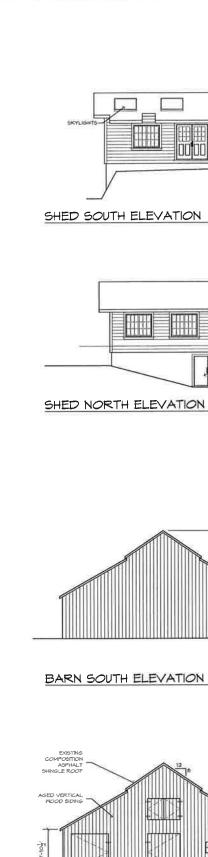
RAGI GA ంర

CEDAR STREET, CALISTOG, 011-410-015-000 SIDENC ш IMP 1998 APN

SCALE: AS NOTED

IOB NO. 1402 SHEET NO:



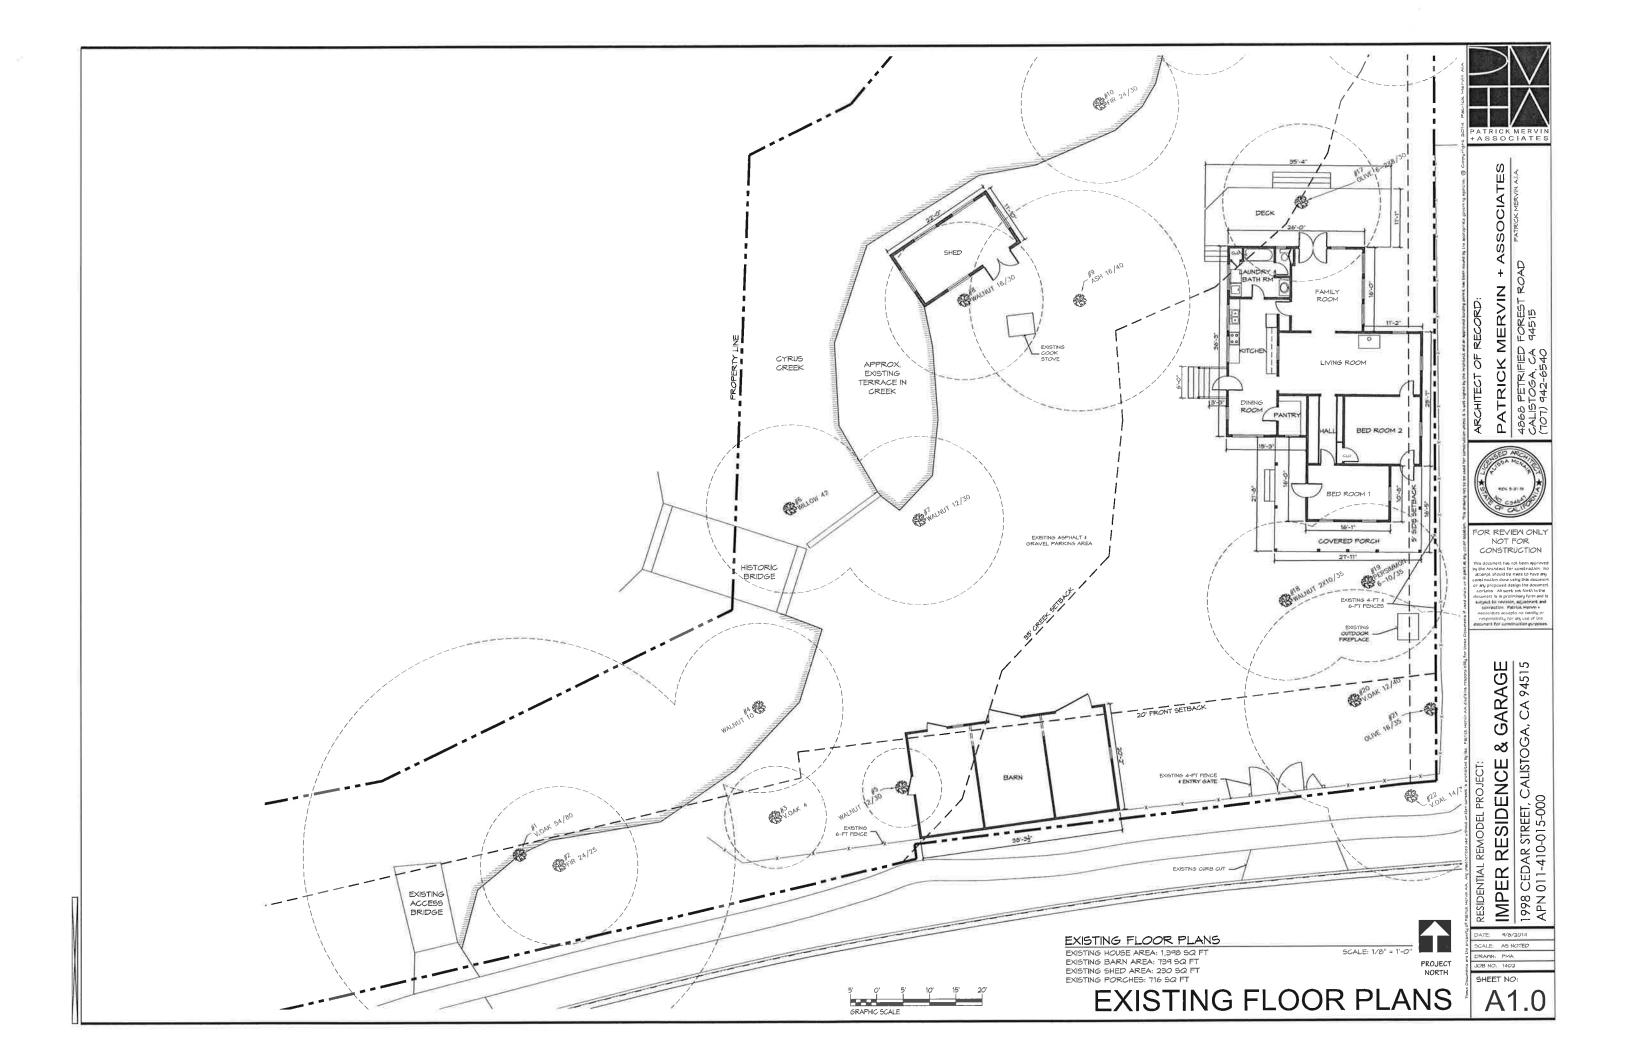


BARN NORTH ELEVATION


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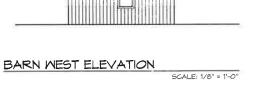
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SCALE: 1/8" = 1'-0"









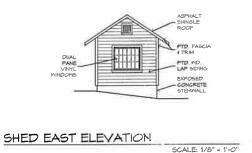

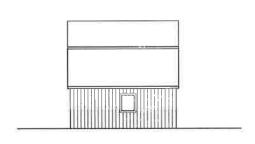


SCALE: 1/8" = 1'-0"

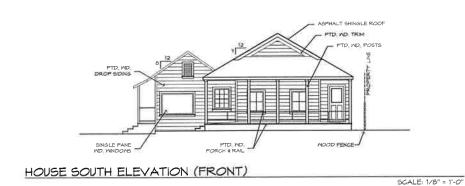

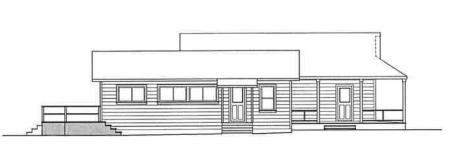





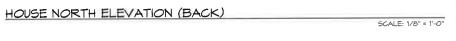



HOUSE EAST ELEVATION (NEIGHBOR SIDE)





IN + ASSOCIATES
TROAD PATRICK MEN'NIN ALA PATRICK MERVIN 4 4868 PETRIFIED FOREST ROA CALISTOGA, CA 94515 (101) 942-6540 ARCHITECT OF RECORD:





FOR REVIEW ONLY NOT FOR CONSTRUCTION


IMPER RESIDENCE & GARAGE 1998 CEDAR STREET, CALISTOGA, CA 94515 APN 011-410-015-000

JOB NO. 1402

SHEET NO: A1.1

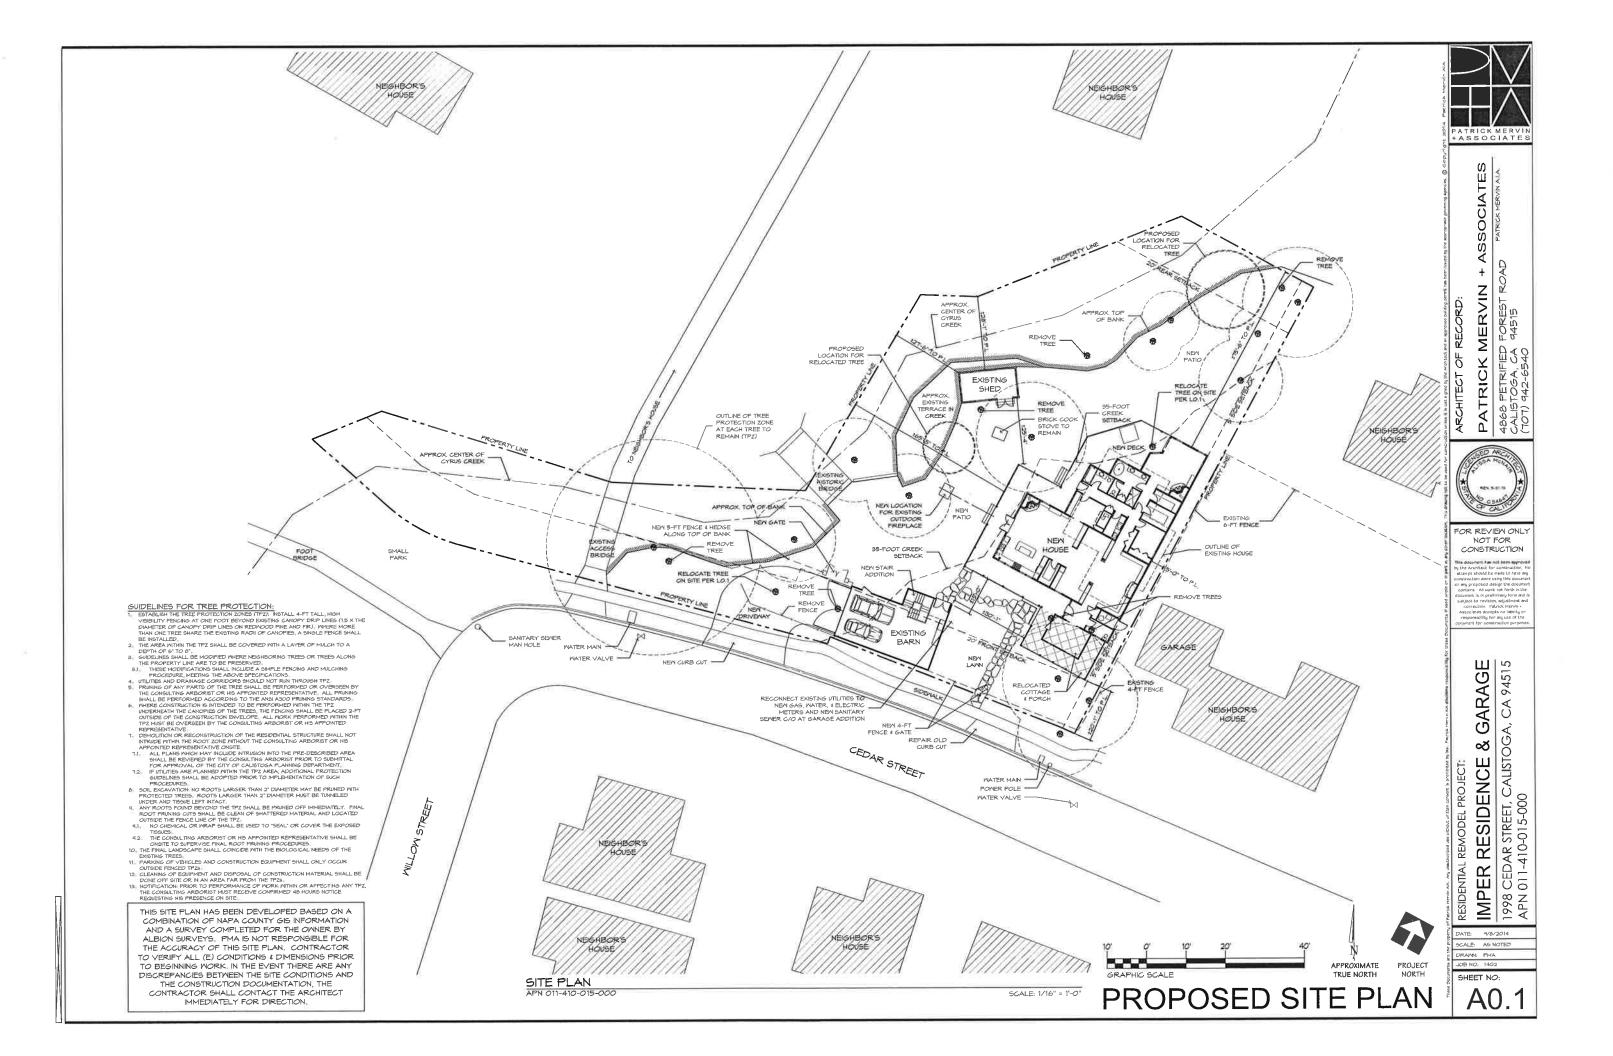


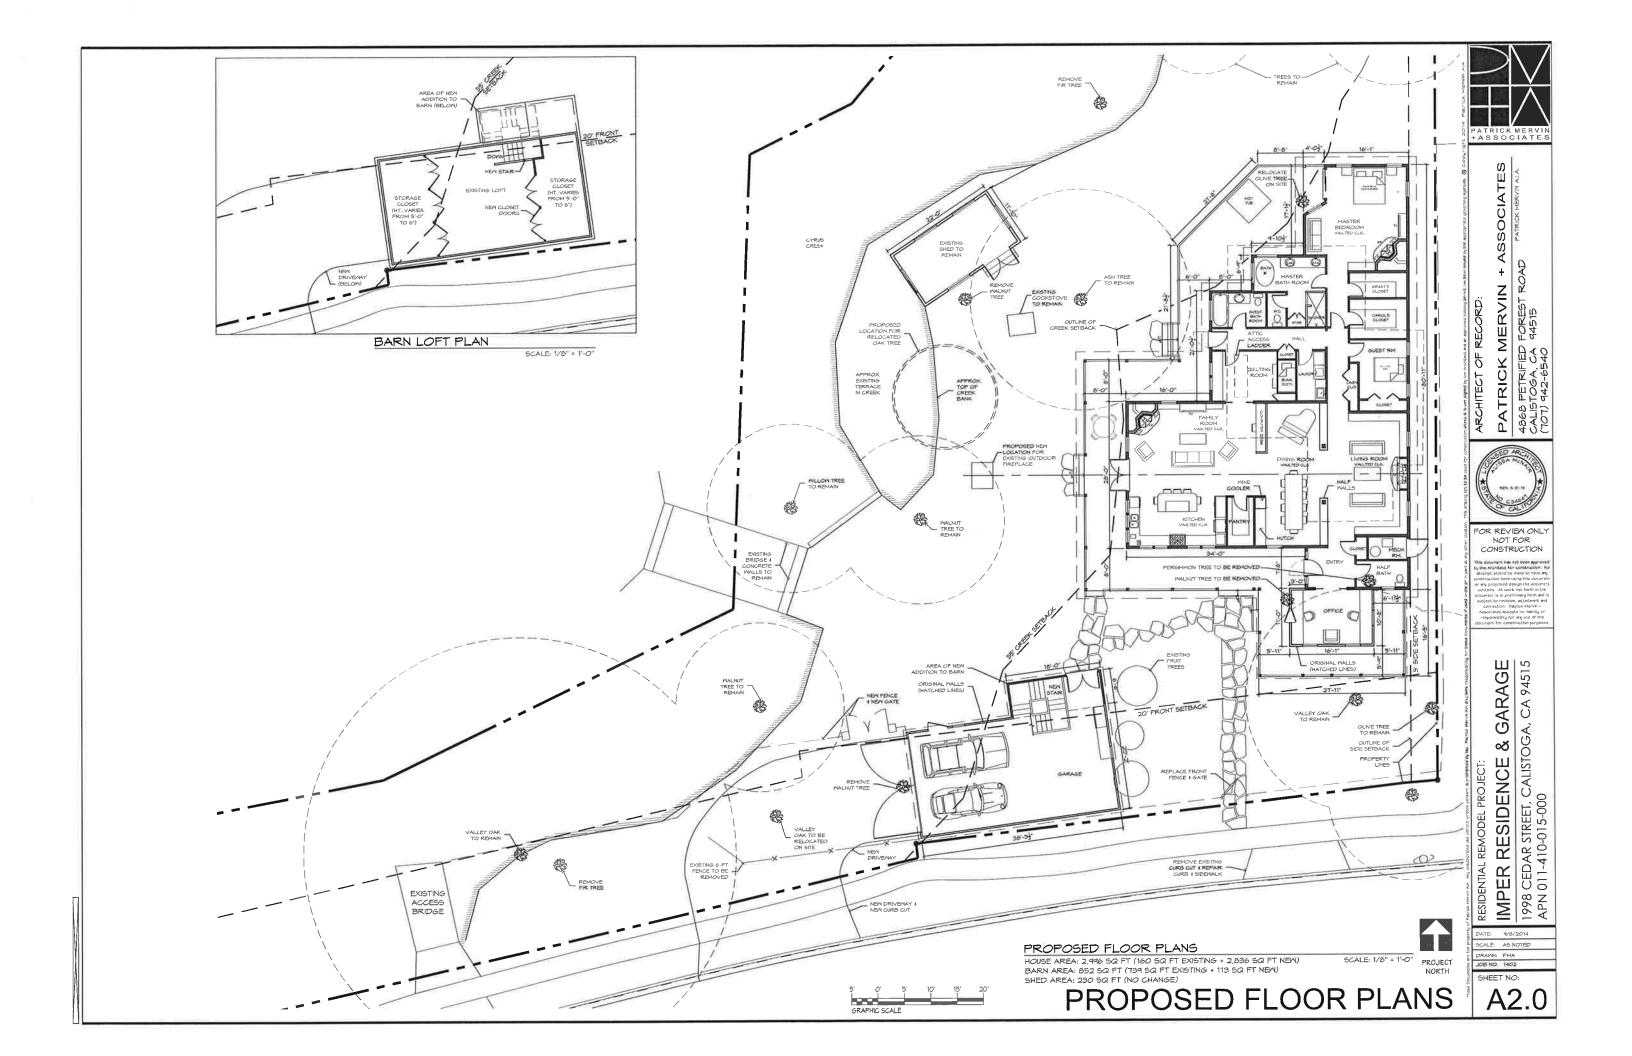

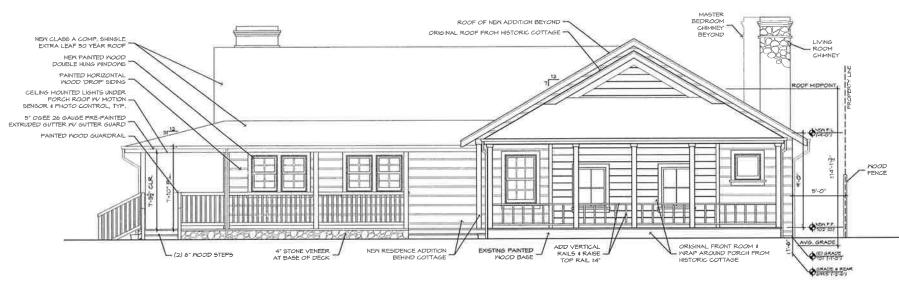

HOUSE SOUTH ELEVATION (FACING STREET)

HOUSE NORTH ELEVATION (BACK)

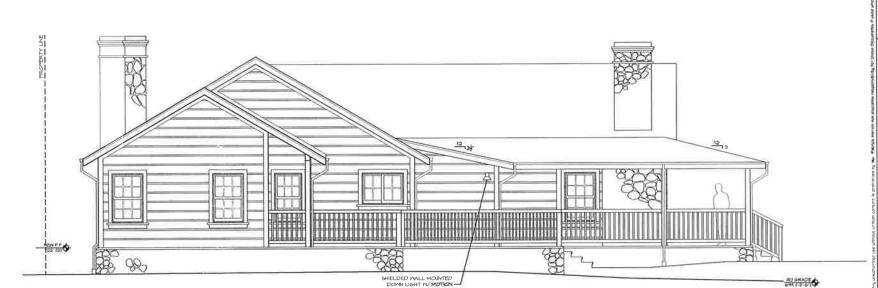

PROPOSED EXTERIOR ELEVATIONS



ARE BAILED ARE

SCALE: 1/4" = 1'-0"

SCALE: 1/4" = 1'-0"

FOR REVIEW ONLY NOT FOR CONSTRUCTION

E & GARAGE STOGA, CA 94515

RESIDENTIAL REMODEL PROJECT:

IMPER RESIDENCE & G/
1998 CEDAR STREET, CALISTOGA, O
APN 011-410-015-000

DATE: 4/0/2014


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JOB NO. 1402

SHEET NO:

A3.0



PROPOSED EXTERIOR ELEVATIONS

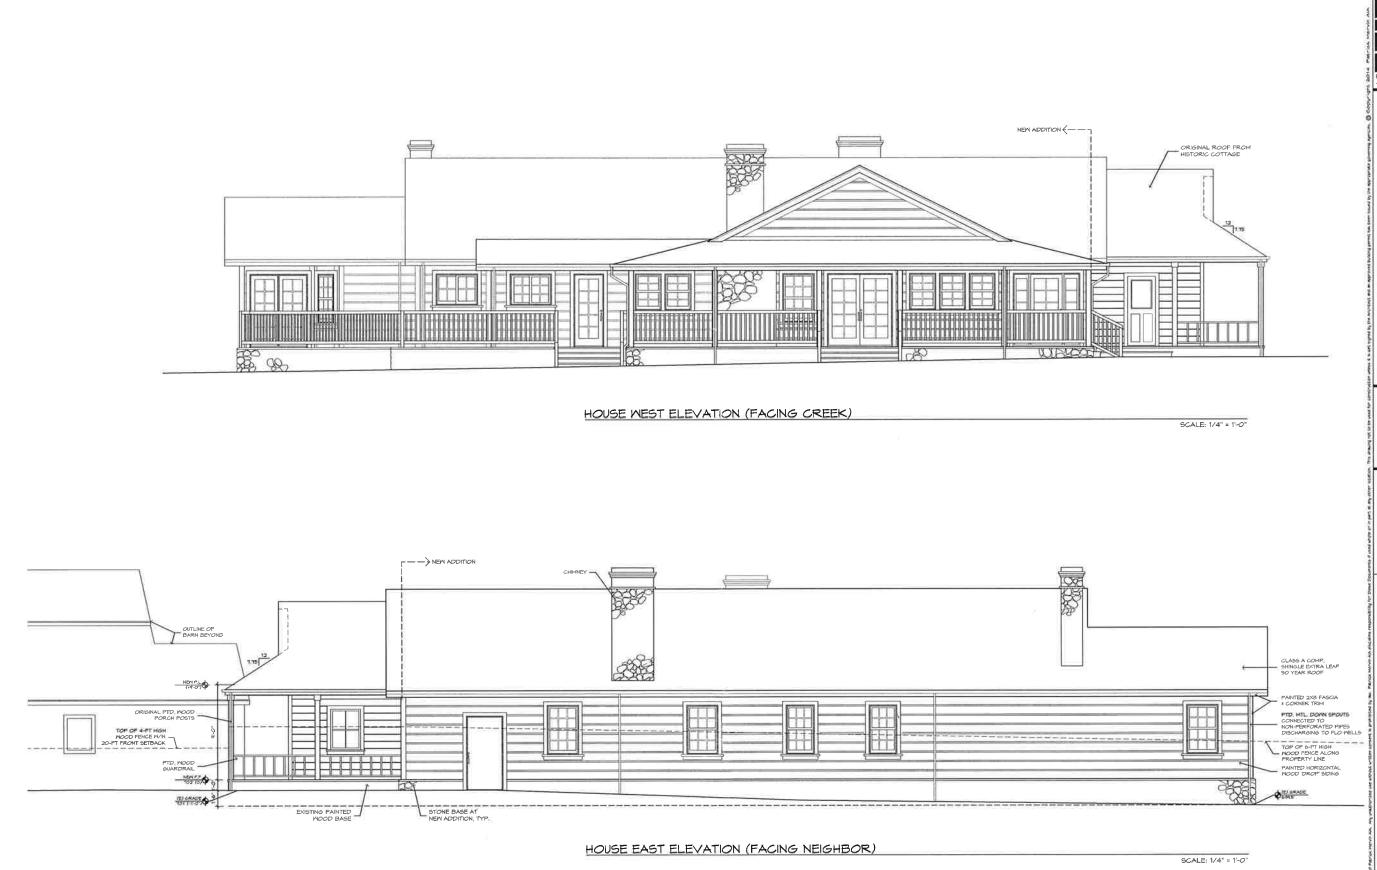

PATRICK MERVIN + ASSOCIATES
4868 PETRIFIED FOREST ROAD
CALISTOGA, CA 94515
(101) 942-6540

FOR REVIEW ONLY NOT FOR CONSTRUCTION

1998 CEDAR STREET, CALISTOGA, CA 94515 APN 011-410-015-000

DATE: 9/8/2014 SCALE: AS NOTED SHEET NO:

A3.1



SHED WEST ELEVATION

SCALE: 1/4" = 1'-0"

PROPOSED EXTERIOR ELEVATIONS



N + ASSOCIATES
ROAD PAIRICK MERVIN ALA. PATRICK MERVIN - 4868 PETRIFED FOREST ROA CALISTOGA, CA 94515 (101) 942-6540


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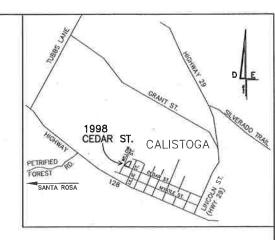
GARAGE SA, CA 94515

IMPER RESIDENCE & G, 1998 CEDAR STREET, CALISTOGA, APN 011-410-015-000

DRAWN PHA

SHEET NO: A3.2



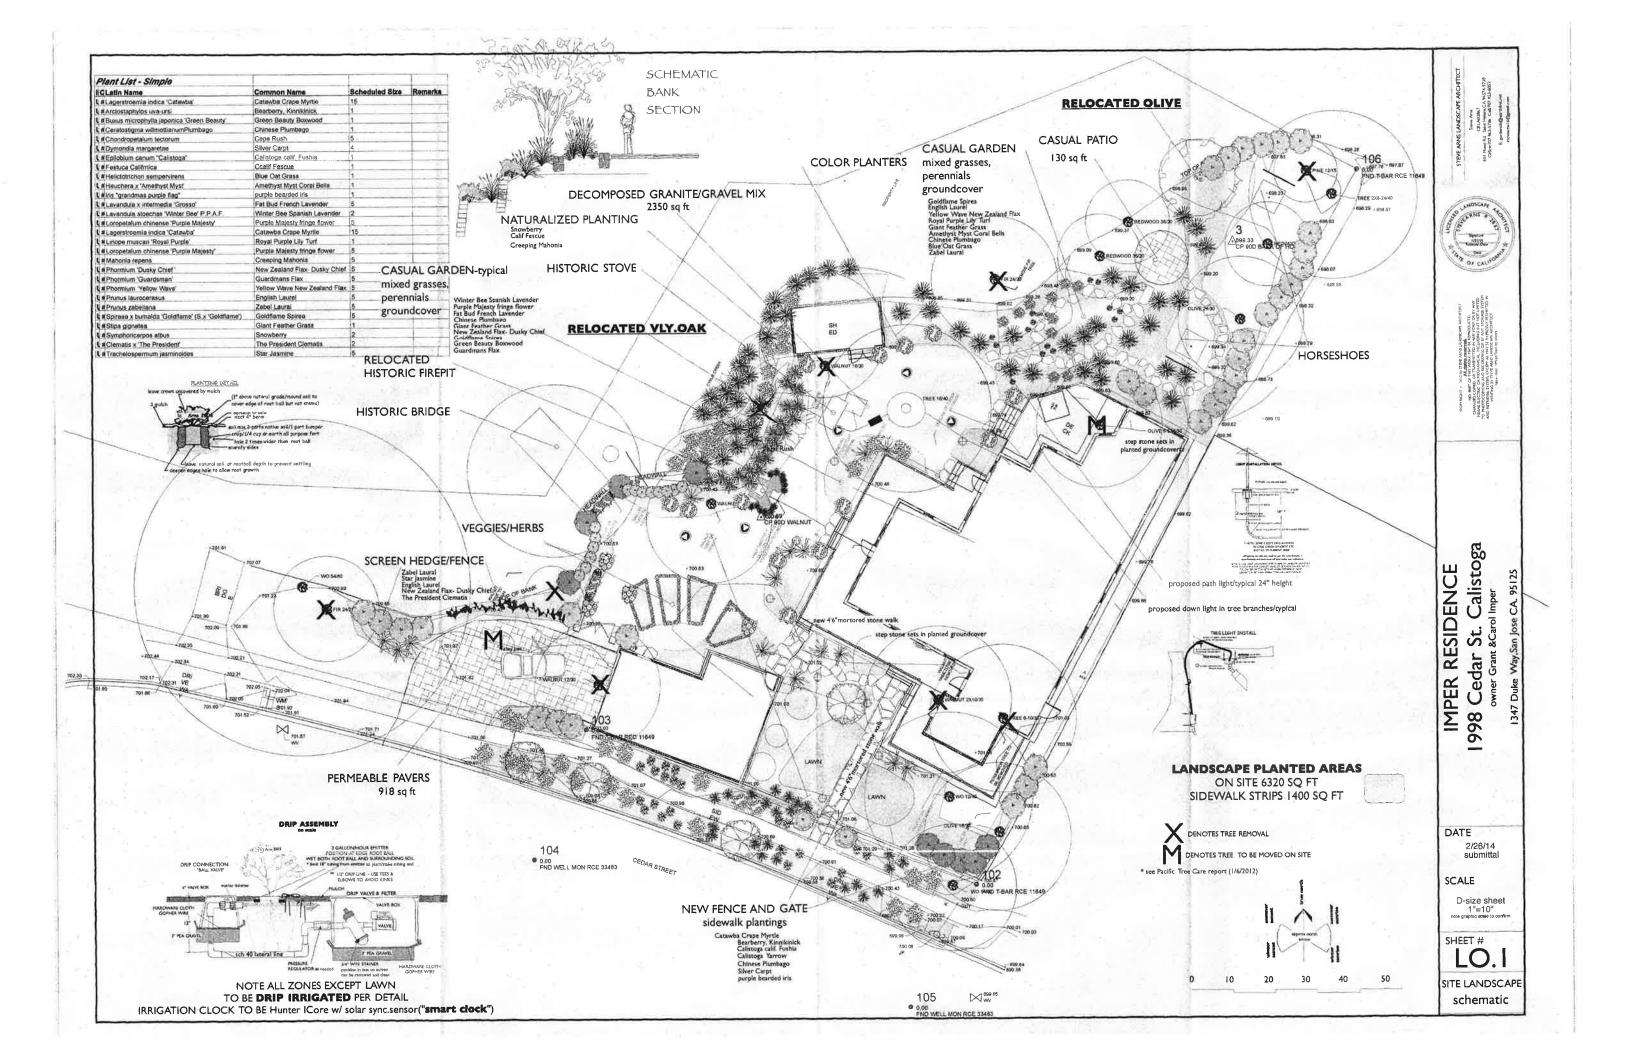

LOCATION MAP

# IMPROVEMENT PLANS LANDS OF IMPER CALISTOGA, CALIFORNIA

#### TOPOGRAPHIC NOTE:

TOPOGRAPHIC INFORMATION SHOWN IS TAKEN FROM A TOPOGRAPHIC SURVEY BY ALBION SURVEYS, INC. IN JUNE OF 2011.

#### REVISIONS

REVISION	DATE	BY
Δ		
		_
	4	-

#### LEGEND

A.B.	= AGGREGATE BASE	G.V.	GATE VALVE	S.W.E.	= SIDEWALK EASEMENT
A.C.	- ASPHALT CONCRETE	I.G.	= INVERT GRADE	t.w.	= TOP OF WALL
A.S.B.	= AGGREGATE SUBBASE	LP.	IRON PIPE, SIZE AS NOTED	b.w.	= BASE OF WALL
B.O.	= BLOW-OFF	J.P.	= JOINT POLE	T.C.	= TOP OF CURB
B.V.C.	= BEGIN VERTICAL CURVE	L.F.	= LINEAL FEET	T.G.	= TOP OF GRATE
C.B.	= CATCH BASIN	NT	NEW TREE	TYP.	= TYPICAL
C.I.	= CURB INLET	P.I.	= POINT OF INTERSECTION	W.M.	= WATER METER
C.L.	= CENTERLINE	P.L.	PROPERTY LINE	W -	EX. WATER LINE
C.M.P.	- CORRUGATED METAL PIPE	P.U.E.	PUBLIC UTILITIES EASEMENT	<del></del>	⇒ EX. SEWER LINE
CONC.	= CONCRETE	R =	= RADIUS	==>	= EX. STORM DRAIN
D.I.	= DROP INLET	R.C.P	# REINFORCED CONCRETE PIPE	<u>—</u> G——	= EX. GAS LINE
D/W	= DRIVEWAY	RED.	= REDUCER	E	= EX. UNDERGROUND ELECTRIC
E.P.	= EDGE OF PAVEMENT	R/W	= RIGHT OF WAY	GATV	= EX. UNDERGROUND CABLE T.V.
ESMT.	= EASEMENT	S =	= SLOPE	<del></del>	= EX. UNDERGROUND TELEPHONE
E.V.C.	= END VERTICAL CURVE	S.D.	STORM DRAIN		- APPROXIMATE PROPERTY LINE
EX.	= EXISTING	S.S.C.O.	= SANITARY SEWER CLEANOUT	6AX9	= EX. SPOT ELEVATION
F.G.	= FINISH GRADE	S.S.M.H.	= SANITARY SEWER MANHOLE	100-	= EX, GROUND CONTOUR
F.H.	= FIRE HYDRANT	STD.	= STANDARD	,-	= STREET LIGHT
G.B.	= GRADE BREAK	S/W	= SIDEWALK	□PB	= PULL BOX

California Council of Civil Engineers & Land Surveyors

UNAUTHORIZED CHANGES & USES: The engineer preparing these plans will not be responsible
for, or liable for, unauthorized changes to or uses of these plans. All changes to the plane
must be to writing and must be approved by the preparer of these plans.

Construction contractor agrees that in accordance with quentity accepted construction procless, construction contractor will be required to assume sale and complete responsible for job stat conditions during the course of construction of the project. Including adulty is also constructed to the project, including adulty in the project, including adulty in the project including adulty and acceptance of the project including adulty and acceptance of the project including adulty and professional formation from the project in the project including and had design professional humilies from only and all Bability, read or alleged, in connection within the performance of which is the project, it respects adulty after the project in scarce of the project in the project in which is the performance of which is the project, its expects adults design from the project in the project in scarce of which is the project, its expects adults design from the project in the

#### PROJECT DISTURBANCE AREA

0.38 ACRES ±

#### PROPERTY OWNER INFORMATION

OWNER: GRANT & CAROL IMPER ADDRESS: 1347 DUKE WAY SAN JOSE, CA. 95125

OWNER REPRESENTATIVE.: PATRICK MERVIN & ASSOCIATES 4868 PETRIFIED FOREST ROAD CALISTOGA, CA. 94515 (707)484-0323

#### PURPOSE STATEMENT

THESE PLANS ARE BEING PREPARED FOR THE PURPOSE OF PROVIDING GRADING & DRAINAGE IMPROVEMENTS TO SUPPORT NEW RESIDENCE AND DRIVEWAY

#### GEOTECHNICAL REFERRAL

SOILS INVESTIGATION REPORT FOR 1998 CEDAR STREET., CALISTOGA BY BAUER ASSOCIATES AND DATED 08/15/11 UNDER PROJECT NO. 2810.0

CONTRACTOR TO BE FAMILIAR WITH AND FOLLOW ALL CONSTRUCTION REQUIREMENTS AS ADDRESSED IN THE SOILS REPORT.



## APPROVED: PRELIMINARY

SUBJECT TO REVISION

DAN WRIGHT, R.C.E. 22296 DATE

# INDEX OF SHEETS

SHEET NO.															TITLE			
	1	•	Œ.	Æ	8		2	•	٠	٠	٠,			8	TITLE SHEET			
	2	÷	÷				÷	ē			٠		÷	÷	GRADING PLAN SHEET			
															NOTES & DETAILS SHEET			
	4	•		9		ě	•	•	٠	٠		٠	•	٠	EROSION CONTROL SHEET			

# HOUSE SITE & PRIVATE DRIVEWAY IMPROVEMENT PLAN

FOR

GRANT & CAROL IMPER

1998 CEDAR STREET

CALISTOGA, CALIFORNIA

APN 011-410-015





ANALYSIS • PLANNING • SURVEYING • ENGINEERING 2852 MENDOCINO AVENUE, SANTA ROSA CA. 85403 (707) 578-3433


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SHEET 1 OF 4






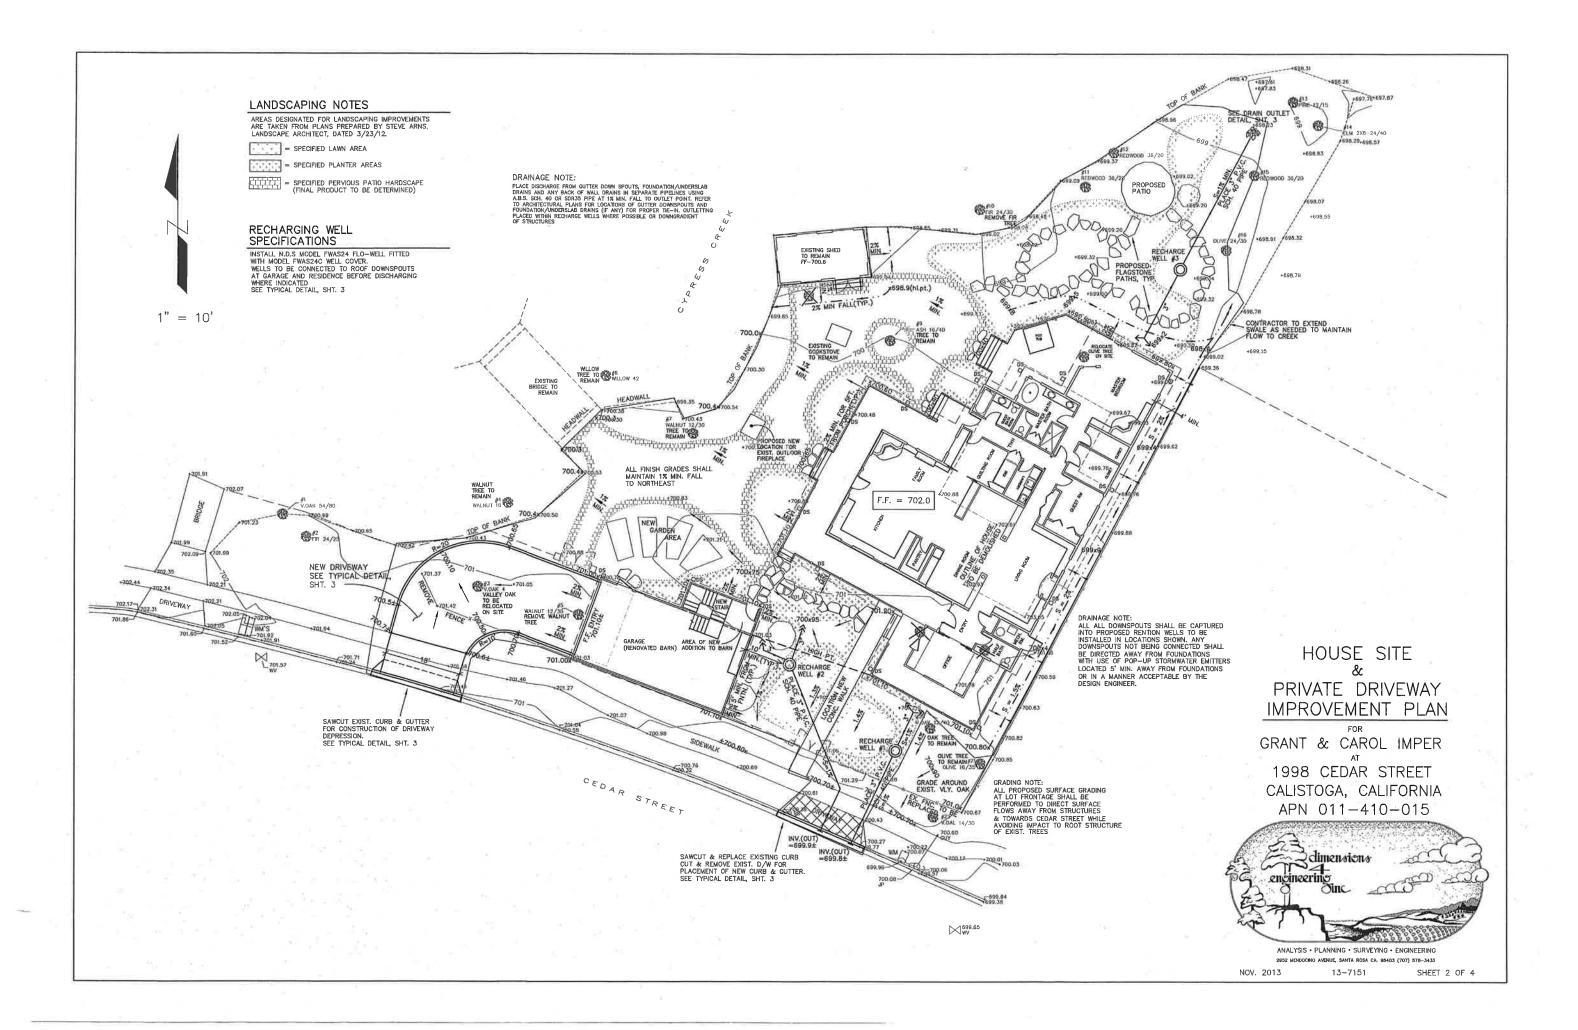
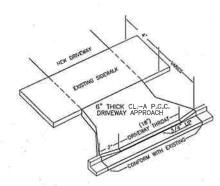
#### NEW DRIVEWAY APPROACH DETAIL

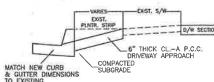N.T.S

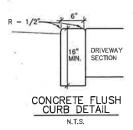

NOTE:
FINAL SELECTION OF PAVER MATERIAL
TO BE DETERMINED BY ARCHITECT.
PAVER STRUCTURAL SECTION IS
SUGGESTED ONLY, CONTRACTOR TO
FOLLOW MANUFACTURERS PLACEMENT
SPECIFICATIONS TO CONJUNCTION WITH
SPECIFICATIONS TO CONJUNCTION WITH
RECOMMENDATION OF THE SOILS ENGR.

PERMEABLE PAVER, TYP.
(FILLED WITH 1/4" - 3/8"
FOLION FINES)


AASHTO #8

2"
AASHTO #8

2"
AASHTO #8

2"
AASHTO #1
AASHTO #1
AASHTO #1
SUGGREGATE
(NO FINES)

COMPACTED
SUBGRADE

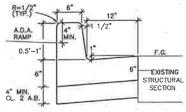


DRIVEWAY PAVING DETAIL

N.T.S.


CONCRETE
CURB & GUTTER
DETAIL

N.T.S.

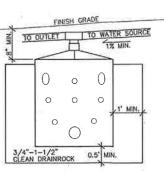

RECHARGING WELL SHALLOW GRADE DETAIL

EXIST.
CURB & GUTTER
CEDAR ST.
OUTLET DRAIN

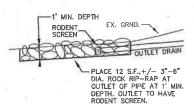

DRAIN OUTLET DETAILS

#### GRADING AND DRAINAGE NOTES

- 1. ALL WORK SHALL BE DONE IN COMPLANCE WITH THE APPROVED PLANS AND SPECIFICATIONS. THE CONTRACTOR SHALL IMMEDIATED WORTH THE REGISTER OF RECORD UPON DISCOVERING DISCREPANCES, ERRORS, OR OWNESSIONS IN THE PLANS PROFIT OF PROCEEDING, THE OWNER SHALL HAVE THE PLANS RESIDED TO CLAMPY IDENTIFIED DISCREPANCES, CROWNERS, OR OWNERSONS, THE APPROVED PLANS AND SPECIFICATIONS SHALL NOT BE CHANGED WITHOUT THE WRITTEN APPROVAL OF THE COUNTY
- THE GRADING/ORAINAGE PERMIT AND AN APPROVED COPY OF THE GRADING/DRAINAGE PLANS SHALL BE MAINTAINED ON THE PROJECT SITE
- ISSUANCE OF A GRADING/ORAHAGE PERMIT DOES NOT ELMINATE THE RESPONSIBILITY OF THE OWNER TO SECURE PERMITS FROM OTHER AGENCIES WITH REGULATORY RESPONSIBILITIES FOR THE CONSTRUCTION ACTIVITIES ASSOCIATED WITH THE WORK ON THESE PILMS. FAILURE TO OBTAIN ALL REGUIRED PERMITS MAY RESULT IN FIRES FROM THE
- EXISTING DRAINAGE COURSES RECEIVING WATERS FROM THIS SIT AND LOCATED THROUGHOUT THIS SITE SHALL REMAIN OPEN AND CLEAR OF DEBRIS TO PROPERLY CONVEY STORM WATER. THE OWNER AND/OR CONTRACTOR SHALL BE HELD LIABLE FOR ANY DAMAGE ONLY TO REPRIECTIVE MAD THE ALL DEBLANCE BATTERS
- 5. THE CONTRACTOR SHALL BE RESPONSIBLE FOR NOTIFYING UNDERGOOND SERVICE ALERT (U.S.A.). TOLL FREE X 17-800-642-2444 AT LEAST TWO WORKING DAYS BUT NOT MORE THAN 14 CALENDAR DAYS PRORT TO EXCAVATION. THE CONTRACTOR SHALL UNCOVER RELEVANT UTILITIES TO VERIEY THEIR LOCATION AND LEEVATION, IF MOREOLOGICAL OF THE STANDARD OF THE STANDARD
- B. IN THE EVENT CULTURAL RESOURCES (I.E. HISTORICAL, ARCHAEOLOGICAL, AND PALEONICO, GRADING OR OTHER CONSTRUCTION ACTIVITIES, DISCOVERED DURING GRADING OR OTHER CONSTRUCTION ACTIVITIES, WORK SHALL MEDITATE VE HALTED WITHIN THE MCINITY OF THE FIRD, THE MORTHWEST INFORMATION CENTER ALL BE NOTIFIED AND ACTIVITIES OF THE ACTIVITIES SHALL BE NOTIFIED FOR ACTIVITIES SHALL BE CONSULTED FOR AN ON-SITE EXAULATION.
- , SHOULD GRADING OPERATIONS ENCOUNTER HAZARDOUS MATERIALS, OR WHAT APPEAR TO BE HAZARDOUS MATERIALS, STOP WORK IMMEDIATELY IN THE AFFECTED AREA AND CONTACT 911 OR THE APPENDEDIATE ACENTY FOR EINDIRG INSTRUCTION OF THE
- RETAINING WALLS, UNLESS EXEMPTED PER SCC 7.13(A)(3)4, ARE NOT APPROVED UNDER A GRADING PERMIT. A SEPARATE BUILDING PERMIT IS REQUIRED.
- EQUIPMENT SHALL NOT CROSS OR DISTURB CHANNELS OF ACTIVEL FLOWING STREAMS WITHOUT APPROVED PERMIT AND BEST MANAGEMENT PRACTICES
- D. CONTOURS, ELEVATIONS, AND SHAPES OF FINISHED SUFFACES SHALL BE BLENDED WITH ADJACENT NATURAL TERRAIN TO ACHIEVE. A THE CUIT SUBSISTENCY OF THE CUIT OF THE CUIT
- 11. FILL MATERIAL SHALL NOT INCLUDE ORGANIC, FROZEN, OR OTHER DELETERIOUS MATERIALS. NO ROCK OR SMILAR INFEDUCIBLE BE MATERIAL GREATER THAN 6 INCHES IN ANY DIMENSION SHALL BE INCLUDED IN FILLS EXCEPT WHERE APPROVED BY THE ORGANICHES IN DEPTH. COMPLETED FILLS SHALL BE STABLE. WELL INTEGRATED, AND BONDED TO ADJACENT MATERIALS AND THE MATERIALS ON WHICH THE REST, FILLS SHALL BE COMPETENT TO SUPPORT ANTICIPATED LOADS FALLS. THE SHALL BE COMPETENT TO SUPPORT ANTICIPATED LOADS FALLS SHALL BE COMPETENT TO SUPPORT SATISFACTORY OF THE PROPERTY OF THE PRO
- 12. GROUND SURFACES SHALL BE PREPARED TO RECOVE FILL BY REMOVING VECETATION, TOPSOIL, AND OTHER UNSUITABLE MATERIALS, AND SCARIFYING THE GROUND TO PROVIDE A BOND WITH THE FILL MATERIAL 13. FILL SHALL NOT BE PLACED ON NATURAL SLOPES STEEPER THAN 2H:1V (5072).
- 14. FILLS INTENDED TO SUPPORT STRUCTURES OR SURCHARGES SHALL BE
- 14. FILLS INTENDED TO SUPPORT STRUCTURES OR SURCHARGES SHALL BE COMPACTED TO A MINIMUM OF 90% OF MAXIMUM DRY DENSITY, AS DETERMINED BY ASTIM D 1557, MODIFIED PROCTOR. A HIGHER COMPACTION PERCENTAGE MAY BE REQUIRED BY THE SOILS ENGINEER.
- 15. FILLS NOT INTENDED TO SUPPORT STRUCTURES OR SURCHARGES SHALL BE COMPACTED AS FOLLOWS: (1) FILL GREATER THAN 3 FEET I DEPTH SHALL BE COMPACTED TO THE DENSITY SPECIFIED BY THE SOLE DEGINEER. (2) FILLS NO GREATER THAN 3 FEET IN DEPTH SHALL BE COMPACTED TO THE DENSITY NECKSSARY FOR THE INTENDED USE OR AS DIRECTED BY THE SOLE SHORING.

#### GRADING AND DRAINAGE INSPECTION NOTES

- 1. THE PERMITTEE AND THE PROPERTY OWNER SHALL BE RESPONSIBLE FOR THE WORK TO BE PERFORMED IN COMPLIANCE WITH A PPROVED WORK SHALL BE SUBJECT TO RESPECTION AS REQUIRED BY THE PERMIT AUTHORITY TO VERIFY COMPLIANCE. THE CONTRACTOR SHALL CONSULT THE PROJECT JOB CARD FOR COORDINATION OF INSPECTION REQUESTS.
- THE PROJECT JOB CARD FOR COURDINATION OF INSPECTION REQUESTS.

  2. PRIOR TO THE START OF ANY GRADING WORK, THE PERMITTEE SHALL
  HAVE A PIRE-CONSTRUCTION CONSULTATION WITH COUNTY OF NAPA TO
  DISCUSS THE SCOPE OF THE PROJECT, PERMIT CONDITIONS, REQUIRED
  INSPECTIONS, APPROPRIATE APPLICATION OF BEST MANAGEMENT
  PRACTICES (BMPS) AND ANY OTHER CONSTRUCTION ISSUESS.
- 3) THE PERMITTEE SHALL PROVIDE ADEQUATE AND SAFE ACCESS TO THE
- 4. DURING CONSTRUCTION ACTIVITIES, THE PROJECT SIX ADDRESS SHALL BE POSTED AS FOLLOWS: (1) THE STREET KNIMBERS MUST BE AT LEAST FOUR INCKES TALL, WITH A REFLICTIVE SURFACE. (2) THE ADDRESS MUST BE WISILE FROM BOTH DIRECTIONS ALONG THE ROAD. (3) THE ADDRESS MUST BE POSTED AT ALL FORKS IN ANY ACCESS ROAD AND AT THE SITE.

#### STORM DRAIN NOTES

- 1. ALL STORM DRAINS (S.D.) SHALL BE P.V.C. SDR35, H.D.P.E. OR APPROVED EQUAL WITH 1' MIN. COVER ABOVE TOP OF PIPE.
- 2. PLACE DISCHARGE FROM GUITTER DOWN SPOUTS, FOUNDATION/UNDERSLAB DRAINS AND BACK OF WALL DRAINS IN SEPARATE PIPEUNES USING A.B.S. SCH. 40 OF SDR35 PIPE AT 28 MIN. FALL TO OUTLET. REFER TO ARCHITECTURAL PLANS FOR LOCATIONS OF GUITTER DOWNSPOUTS AND FOUNDATION/UNDERSLAB DRAINS FOR PROPER TIE-IN, OUTLETTING TO BE PLACED DOWNGRADIENT AND AWAY FROM ALL IMPROVEMENTS.
- 3. TRENCH AND BACKFILL CONSTRUCTION FOR STORM DRAIN PIPE SHALL BE IN ACCORDANCE WITH ACAIRRANS STANDARD PLANS DRAWING A62—D FOR CONCRETE CULVERTS AND A62—F FOR METAL AND PLASTIC CULVERTS, EXCEPT THAT THE TRENCH WIDTH NEED ONLY BE ONE FOOT ON EACH SIDE OF THE PIPE.
- 4. VERTICAL CONTROL OF PIPE LAYING MAY BE BY EITHER (A) "BATTER BOARDS", STRING LINE & GRADE ROO, OR (B) BY LASER BEAM. FOR STORM DEARN PIPES (OTHER THAN CIPE) WHICH HAVE SUPES FLATTER THAN 0.0030 FT./FT., THE SOL CEMENT BEDOING DESCRIBED IN SECTION 19-3.0250 CALIFAINS STANDIAND SPECIFICATIONS SHALL BE USED.
- OFF-SITE DRAINAGE IMPROVEMENTS SHALL BE COMPLETED PRIOR TO NOVEMBER 1ST.
- 8. FOUNDATION DRAIN MATERIALS & PLACEMENT TO BE IN ACCORDANCE WITH THE SOILS REPORT.
- FINAL PLACEMENT LOCATIONS OF FOUNDATION DRAINS TO BE DETERMINED BY CONTRACTOR AND SOILS ENGINEER.
- BACK-OF-RETAINING WALL SUBDRAIN MATERIALS AND PLACEMENT TO BE IN ACCORDANCE WITH SPECIFICATIONS FOR CONSTRUCTION OF THE RETAINING WALLS.

#### STRUCTURAL SECTION NOTES

- THE ROAD SUBGRADE WITHIN THE ROADWAY SECTION SHALL BE SCARIFIED TO A DEPTH OF SIX INCHES AND COMPACTED TO A TIGHT NON-VIELDING SURFACE WITH NO VISIBLE DISPLACEMENT TO AT LEAST 95% OF RELATIVE COMPACTION AND SHALL BE FREE OF LOOSE OR EXTRANEOUS MATERIAL.
- THE CLASS II AGGREGATE BASE SHALL HAVE A RELATIVE COMPACTION OF AT LEAST 95%, SHALL BE FREE OF LOOSE OR EXTRANEOUS MATERIAL, AND BE A TIGHT NON-YIELDING SURFACE WITH NO VISIBLE DISPLACEMENT.
- 3. ANY ASPHALT CONCRETE SHALL HAVE A RELATIVE COMPACTION OF AT LEAST 95%
- A SOILS ENGINEER SHALL TEST, AND APPROVE THE CONSTRUCTION OF ROADS, AND, IF REQUIRED, PARKING AREAS. THE SOILS ENGINEER SHALL PROVIDE COPIES OF THE TEST RESULTS AND WRITTEN APPROVIALS TO THE COUNTY'S INSPECTOR WITHIN 3 WORK DAYS OF TESTING OR APPROVIAL THE APPROVIAL SHALL INCLUDE THE STRIBILTY AND RELATIVE DENISTY OF SUBGRADES BASE COURSES PRIOR TO THE PLACEMENT OF ASPHALT CONCRETE. A FINAL SOILS REPORT SHALL BE SUBMITTED BY THE PROJECT SOILS ENGINEER TO THE CONSTRUCTION INSPECTION SUPERVISOR WHICH CONTAINS AN ANALYSIS OF THE SOILS ENCOUNTERED AND COMPILATION OF THE COMPACTION TESTS PERFORMED,

#### MISCELLANEOUS NOTES (IF APPLICABLE)

- THE CONTRACTOR SHALL STAMP THE LETTER "S" ON THE FACE OF THE CURB DIRECTLY ABOVE SEWER LATERALS, AND "M" ON THE FACE OF CURB DIRECTLY ABOVE WATER SERVICE LATERALS, AND "B" ON THE FACE OF THE CURB DIRECTLY ABOVE BLOW-FF OR AIR RELIEF VALVES,
- SIDEWALK WARPS SHALL BE PROVIDED TO ALLOW A CLEAR 4-FOOT WALKWAY IN AREAS WHERE DESTRUCTIONS (LE, MAILBOXES, UTILITY POLES) ARE TO BE INSTALLED, PLACEMENT OF MAILBOXES MUST BE COORDINATED WITH AND APPROVED BY THE LOCAL BRANCH OF THE UNITED STATES POST OFFICE.
- TESTING FOR RELATIVE DENSITIES SHALL BE IN ACCORDANCE WITH CALTRANS TEST METHOD NO. 216, PART II OR A.S.T.M. 1557. THE USE OF SAND CONE METHODS SUCH AS ASTM 1556 OR CALTRANS 216, PART I SHALL NOT BE ALLOWED.
- ALL UNDERGROUND IMPROVEMENTS SHALL BE INSTALLED AND APPROVED PRIOR TO ROAD PAVING AND PLACEMENT OF CURB, GUTTER, AND SIDEWALKS.


# HOUSE SITE & PRIVATE DRIVEWAY IMPROVEMENT PLAN

GRANT & CAROL IMPER

1998 CEDAR STREET

CALISTOGA, CALIFORNIA

APN 011-410-015

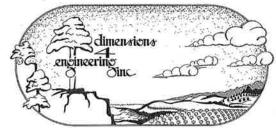


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# EROSION PREVENTION AND SEDIMENT CONTROL NOTES

#### GENERAL

- PERFORM EROSION PREVENTION AND SEDIMENT CONTROL IN ACCORDANCE WITH CHAPTER 11A AND 11 OF THE SONOMA COUNTY CODE (SCC).
- THE APPROVED PLANS SHALL CONFORM WITH THE PERMIT AND RESOURCE MANAGEMENT DEPARTMENT'S (PRMD) EROSION PREVENTION AND SEDIMENT CONTROL BEST MANAGEMENT PRACTICES (BMP'S) GUIDE AS POSTED ON THE PRMD WEBSITE.
- THE OWNER IS RESPONSIBLE FOR PREVENTING STORM WATER POLLUTION GENERATED FROM THE CONSTRUCTION SITE YEAR ROUND, WORK SITES WITH INADEQUATE EROSION AND SEDIMENT CONTROL MAY BE SUBJECT TO A STOP WORK ORDER,
- IF DISCREPANCIES OCCUR BETWEEN THESE NOTES, MATERIAL REFERENCED HEREIN OR MANUFACTURER?'S RECOMMENDATIONS, THEN THE MOST PROTECTIVE SHALL APPLY.
- AT ALL TIMES THE OWNER IS RESPONSIBLE FOR OBTAINING AND COMPLYING WITH THE STATE OF CALIFORNIA NATIONAL POLLUTANT DISCHARGE ELMINATION SYSTEM (NPDES) GENERAL PERMIT WASTE DISCHARGE ELMINGTHON SYSTEM (NPDES) GENERAL PERMIT WASTE DISCHARGE REQUIREMENTS FOR DISCHARGES OF STORM WATER RUNOFF ASSOCIATED WITH CONSTRUCTION ACTIVITY. CONSTRUCTION ACTIVITY. CONSTRUCTION ACTIVITES INCLUDE BUT ARE NOT LIMITED TO CLEARING, GRADING, EXCAVATION, STOCKPUING, AND RECONSTRUCTION OF EXISTING FACILITIES INVOLVING REMOVAL AND REPLACEMENT.

#### RAINY SEASON OPERATIONS

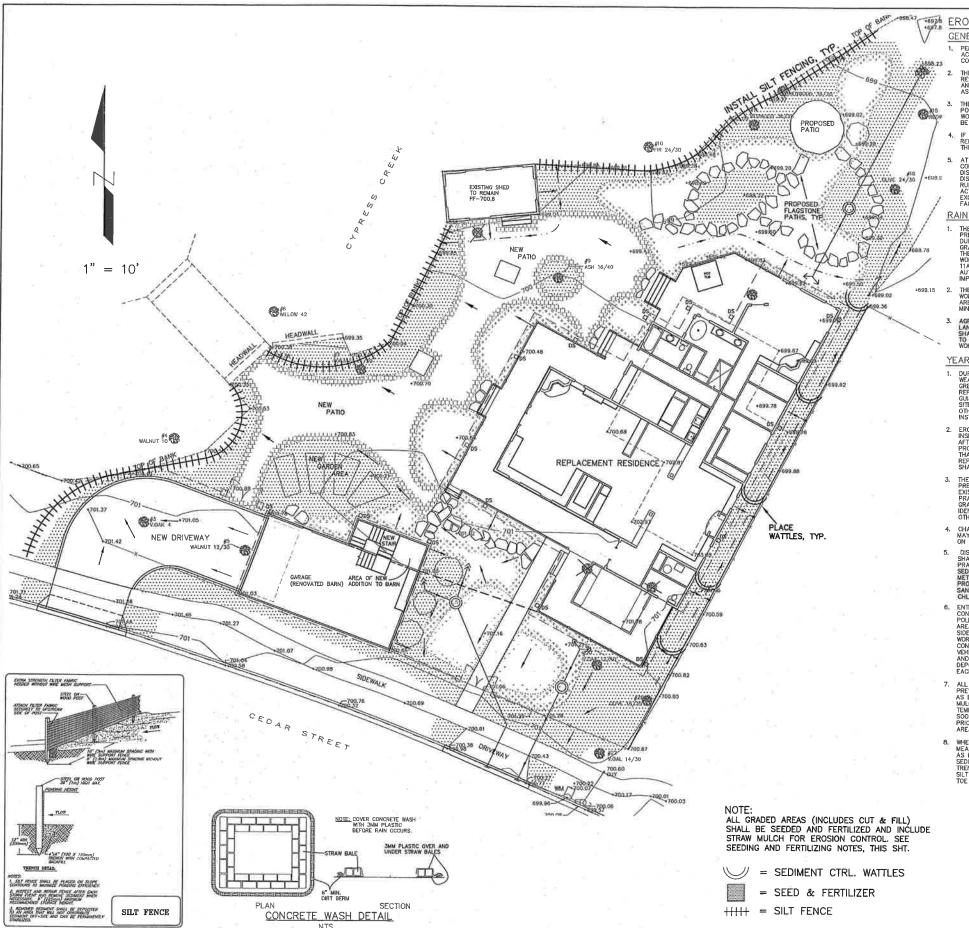- THE OWNER MUST IMPLEMENT AN EFFECTIVE COMBINATION OF EROSION PREVENTION AND SEDIMENT CONTROL ON ALL DISTURBED AREAS DURING THE RAINY SEASON (OCTOBER 15—APRIL 15). CONSTRUCTION GRADING AND DRAINAGE IMPROVEMENT SHALL BE PERMITTED DURING THE RAINY SEASON ONLY WHEN ON-SITE SOIL CONDITIONS PERMIT THE WORK TO BE PERFORMED IN COMPLIANCE WITH SCC CHAPTER 11 AND 11A. STORM WAITER BMPS REFERENCED OR DETAILED IN THE PERMIT AUTHORITYS BEST MANAGEMENT PRACTICES GUIDE SHALL BE IMPLEMENTED AND FUNCTIONAL ON THE SITE AT ALL TIMES
- THE AREA OF ERODIBLE LAND EXPOSED AT ANY ONE TIME DURING THE WORK SHALL NOT EXCEED 1 ACRE OR 20% OF THE PERMITTED WORK AREA, WHICHEVER IS GREATER. AND THE TIME OF EXPOSURE SHALL BE MINIMIZED TO THE MAXIMUM EXTENT PRACTICABLE.
- AGRICULTURAL GRADING AND DRAINAGE IMPROVEMENTS, AND INITIAL LAND PREPARATION WORK FOR VINEYARD AND ORCHARD PLANTING, SHALL BE PERMITTED DURING THE RAINY SEASON ONLY FROM APRIL TO APRIL 15, AND ONLY WHEN ON-SITE SOIL CONDITIONS PERMIT TH WORK TO BE PERFORMED IN COMPULANCE WITH SC CCH. 11A AND 11.

#### YEAR ROUND REQUIREMENTS

- 1. DURING THE NON-RAINY SEASON, ON ANY DAY WHEN THE NATIONAL WEATHER SERVICE FORECAST IS A CHANCE OF RAIN OF 30% OR GRAITER WITHIN THE NEXT 24 HOURS, STORM WATER BMPS REFERENCED OR DETAILED IN PRADTS BEST MANAGEMENT PRACTICES GUIDE SHALL BE IMPLEMENTED, INSTALLED, AND FUNCTIONAL ON THE SITE TO PREVENT SOIL AND OTHER POLLUTANT DISCHARGES, AT ALL OTHER THES, BMPS SHOULD BE STORED ON SITE IN PREPARATION FOR INSTALLATION PRIOR TO RAIN EVENTS.
- EROSION PREVENTION AND SEDIMENT CONTROL MEASURES SHALL BE INSPECTED BY THE OWNER BEFORE FORECASTED STORM EVENTS AND AFTER STORM EVENTS TO ENSURE MEASURES ARE FUNCTIONING FROM THE PROPERTY. EROSION PREVENTION AND SEDIMENT CONTROL MEASURES ARE NO ONORGE EFFECTIVE SHALL BE PROMPTLY REPLACED. AREA OF AREA NO ONORGE FEFFECTIVE SHALL BE PROMPTLY REPLACED. AREA TO STABLEZOR.
- THE LIMITS OF GRADING SHALL BE DEFINED AND MARKED ON SITE TO PREVENT DAMAGE TO SURROUNDING VEGETATION. PRESERVATION OF EXISTING VEGETATION SHALL OCCUR TO THE MAXIMUM EXTENT PRACTICABLE. ANY EXISTING VEGETATION WITHIN THE LIMITS GRADING THAT IS TO REMAIN UNDISTURBED BY THE WORK SHALL BE IDENTIFIED AND PROTECTED FROM DAMAGE BY MARKING, FENCING, OR OTHER MEASURES.
- ON THE PLAN.

  DISCHARGES OF POTENTIAL POLLUTANTS FROM CONSTRUCTION SITES SHALL BE PREVENTED USING SOURCE CONTROLS TO THE MAXIMUM EXTENT PRACTICABLE. POTENTIAL POLLUTANTS INCLUDE BUT ARE NOT UNITED TO: SEDMENT, TRASH, NUTRIENTS, PATHOGENS, PETROLEUM HYDROCARBONS, METALS, CONCRETE, CEMENT, ASPHALT, LIME, PANT, STAINS, GLUES, WOOD PRODUCTS, PESTICIDES, HERBICIDES, CHEMICAL, HAZARDOUS WASTES, SANITARY WASTE, VEHICLE OR EQUIPMENT WASH WATER, AND CHLORINATED WATER.
- CHICKINATED WATER.

  ENTRANCE(S) TO THE CONSTRUCTION SITE SHALL BE MAINTAINED IN A CONDITION THAT WILL PREVENT TRACKING OR FLOWING OF POTENTIAL POLLUTANTS DEPOSITED ON PAYED AREAS WITHIN THE COUNTY RIGHT-OF-WAY, SUCH AS ROADWAYS AND SIDEWALKS, SHALL BE PROPERLY DISPOSED OF AT THE END OF EACH WORKING DAY OR MORE FREQUENTLY AS NECESSARY. THE CONTRACTOR SHALL BE RESPONSIBLE FOR CLEANING CONSTRUCTION VEHICLES LEAVING THE SITE ON A DAILY BASIS TO PREVENT DUST, SILT, AND DIRT FROM BEING RELEASED OR TRACKED OFFSITE ALL SEDIMENT DEPOSITED ON PAYED ROADWAYS SHALL BE REMOVED AT THE END OF EACH WORKING DAY OR MORE OFTEN AS NECESSARY.
- ALL DISTURBED AREAS SHALL BE PROTECTED BY USING EROSION PREVENTION MEASURES TO THE MAXIMUM EXTENT PRACTICABLE, SUCH AS ESTABLISHING VEGETATION COVERAGE, HYDROSEDING, STRAW MULCH, GEOTEXTILES, PLASTIC COVERS, BLANKETS OR MATS. TEMPORARY OR PERMANENT REVEGETATION SHALL BE INSTALLED AS SOON AS PRACTICAL AFTER VEGETATION REMOVAL BUT IN ALL CASES PRIOR TO OCTOBER 15. PRIOR TO FINAL INSPECTION, ALL DISTURBED AREAS SHALL BE REVEGETATED OR LANDSCAPING SHALL BE INSTALLED
- WHENEVER IT IS NOT POSSIBLE TO USE EROSION PREVENTION MEASURES ON EMPOSED SLOPES, SEDIMENT CONTROL DEVICES SUCH AS FIBER ROLLS AND SILT FENCES SHALL BE INSTALLED TO PREVENT SEDIMENT MIGRATION. FIBER ROLLS AND SILT FENCES SHALL BE TRENCHED AND KEYED INTO THE SOIL AND INSTALLED ON CONTOUR, SILT FENCES SHALL BE INSTALLED APPROXIMATELY 2 TO 5 FEET FROM TOE OF SLOPE.

#### YEAR ROUND REQUIREMENTS CONTINUED-

HYDROSEDING SHALL BE CONDUCTED IN A THREE STEP PROCESS. FIRST, EVENLY APPLY SEED MIX AND FERTILIZER TO THE EXPOSED SLOPE. SECOND, EVENLY APPLY MULCH OVER THE SEED AND FERTILIZER. THIRD, STABILIZE THE MULCH IN PLACE, AN EQUIVALENT SINGLE STEP PROCESS, WITH SEED, FERTILIZER, WATER, AND BONDED FIBERS IS ACCEPTABLE.

APPLICATIONS SHALL BE BROADCASTED MECHANICALLY OR MANUALLY AT THE RATES SPECIFIED BELOW. SEED MIX AND FERTILIZER SHALL BE WORKED INTO THE SOIL BY ROLLING OR TAMPING. IF STRAW IS USED AS WILLOH, STRAW SHALL BE DERIVED FROM WHEAT, RICE, OR BARLEY AND EACH OF THE STRAW SHALL BE DEFINED FROM WHEAT, RICE, OR BARLEY AND EACH OF THE STRAW SHALL BE SHALL BE DEFINED RICHEST IN LENGTH, STABILIZATION OF MULCI SHALL BE GONE HYDRAU HAVE NOT BE MULCI STABLE AND THE SOIL EQUIVALENT METHODS AND MATERIALS MY BE USED ONLY THEY ADEQUATELY PROMOTE VEGETATION GROWTH AND PROTECT EXPOSED SLOPES.

#### MATERIALS APPLIC. RATE (LBS./AC.)

SEED MIX Bromus mollis (BLANDO BROME) 40
Trifollum hirtum (HYKON ROSE CLOVER) 20

FERTILIZER
16-20-0 & 15% SULFUR

MULCH STRAW 4000

HYDRAULIC STABILIZING\*
M-BINDER OR SENTINEL 75-100

EQUIVALENT MATERIAL PER MANUFACTURER

\*NON-ASPHALTIC, DERIVED FROM PLANTS

DUST CONTROL SHALL BE PROVIDED BY CONTRACTOR DURING ALL PHASES OF CONSTRUCTION.

STORM DRAIN INLETS SHALL BE PROTECTED FROM POTENTIAL POLLUTANTS UNTIL DRAINAGE CONVEYANCE SYSTEMS ARE FUNCTIONAL AND CONSTRUCTION HAS BEEN COMPLETED.

ENERGY DISSIPATERS SHALL BE INSTALLED AT STORM DRAIN OUTLETS WHICH MAY CONVEY EROSIVE STORM WATER FLOW.

SOIL, MATERIAL STOCKPILES, AND FERTILIZING MATERIAL SHALL BE PROPERLY PROTECTED TO MINIMIZE SEDIMENT AND POLLUTANT TRANSPORT FROM THE CONSTRUCTION SITE.

SOLID WASTE, SUCH AS TRASH, DISCARDED BUILDING MATERIALS AND DEBRIS, SHALL BE PLACED IN DESIGNATED COLLECTION AREAS OR CONTINIERS. THE CONSTRUCTION SITE SHALL BE CLEARED OF SOLID WASTE DAILY OR AS NECESSARY. REQULAR REMOVAL AND PROPER DISPOSAL SHALL BE CORDINIATED BY THE CONTRACTOR.

A CONCRETE WASHOUT AREA, SUCH AS A TEMPORARY PIT, SHALL BE DESIGNATED TO CLEAN CONCRETE TRUCKS AND TOOLS. AT NO TIME SHALL CONCRETE PRODUCTS AND WASTE BE ALLOWED TO ENTER COUNTY WATERWAYS SUCH AS CREEKS OR STORM DRAINS, NO WASHOUT OF CONCRETE, MORTAR MIXERS, OR TRUCKS SHALL BE ALLOWED ON SOIL.

PROPER APPLICATION, CLEANING, AND STORAGE OF POTENTIALLY HAZARDOUS MATERIALS, SUCH AS PAINTS AND CHEMICALS, SHALL BE CONDUCTED TO PREVENT THE DISCHARGE OF POLLUTANTS.

TEMPORARY RESTROOMS AND SANITARY FACILITIES SHALL BE LOCATED AND MAINTAINED DURING CONSTRUCTION ACTIVITIES TO PREVENT DISCHARGE OF POLLUTANTS.

APPROPRIATE VEHICLE STORAGE, FUELING, MAINTENANCE, AND CLEANING AREAS SHALL BE DESIGNATED AND MAINTAINED TO PREVENT DISCHARGE OF POLIUTANTS.

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