#### CITY OF CALISTOGA PLANNING COMMISSION RESOLUTION PC 20189-XX

#### APPROVING DESIGN REVIEW DR 2018-10 FOR A SINGLE-FAMILY HOME AT 1406 FOOTHILL BOULEVARD

**WHEREAS,** on December 4, 2018, the property owner submitted a design review application for a three-bedroom, single-family home on a 0.22-acre lot at 1406 Foothill Boulevard (APN 011-242-014) in the R-3: Multi-Family Residential/Office District; and

WHEREAS, staff reviewed the application in a timely manner as required by California law and the Calistoga Municipal Code; and

WHEREAS, the Planning Commission approved a variance for reduced front and interior side yard setbacks for the property via Resolution PC 2018-10 on July 11, 2018; and

WHEREAS, the design review is exempt from the requirements of the California Environmental Quality Act (CEQA) pursuant to Section 15303(a) of the CEQA guidelines; and

**WHEREAS,** the Planning Commission considered the design review request during a public hearing on February 27, 2019. Prior to taking action on the application, the Planning Commission received written and oral reports by the staff, and public testimony; and

**WHEREAS,** the Planning Commission has made the following design review findings per CMC Section 17.41. as part of its deliberations on the project:

- Finding: The design is in accord with all applicable provisions of the Zoning Code.
  - <u>Supporting Evidence</u>: The development standards for the R-3 Zoning District are complied with as modified by the reduction in front and interior side yard setbacks via Planning Commission resolution 2018-10. As this is the reconstruction of a preexisting structure, a single-family home is allowed on this lot (Calistoga Municipal Code Section 17.44.030(B)(2)).
- 2. <u>Finding</u>: The design is consistent with any adopted design review guidelines to the extent possible.

<u>Supporting Evidence</u>: The architectural plans are consistent with the Single-Family Residential Design Guidelines because the structure is proportionate to the size of the buildable area, is compatible with the surrounding neighborhood, has architectural interest, varied rooflines, and a well-placed garage, and uses landscaping, fencing and lighting to enhance the overall design. The design of the home is reminiscent of the Craftsman-style structure that preceded it on this lot. Architectural details such as tapered porch columns and knee braces emphasize the Craftsman style.

PC Resolution 2018-XX Design Review DR 2018-10 Single-Family Residence at 1406 Foothill Boulevard Page 2

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36 3. <u>Finding</u>: The design will not impair or interfere with the development, use or enjoyment of other property in the vicinity or the area.

<u>Supporting Evidence</u>: The proposed structure would not have any shading impacts or significantly disrupt views from adjoining properties. The new structure replaces a preceding structure that had a very similar footprint and massing.

**NOW, THEREFORE, BE IT RESOLVED** by the City of Calistoga Planning Commission that based on the above findings, the design review application for the residential development on the property known as 1406 Foothill Boulevard are hereby approved, subject to the conditions of approval attached hereto as Exhibit A:

**PASSED AND ADOPTED** on February 27, 2019, by the following vote of the Calistoga Planning Commission:


47	AYES:		
48	NOES:		
49	ABSENT:		
50	ABSTAIN:		
51			
52			Paul Coates, Chairman
53			
54			
55	ATTEST:		
56		Lynn Goldberg, Secretary	

58 EXHIBIT A

- This approval constitutes the approval of a design review application for a single-family home at 1406 Foothill Boulevard (APN 011-242-014). The improvements hereby permitted shall substantially conform to the plans submitted to the City on January 28, 2019.
- This approval shall be null and void if not vested within a one-year period. The Planning and Building Director may extend this time line by up to 12 months pursuant to Calistoga Municipal Code Section 17.41.060.
- Upon issuance of a building permit for the single-family residence located at 1406 Foothill Boulevard, this approval shall be deemed vested.
- 68 4. Minor modifications to the approved plans may be approved in writing by the Planning and Building Department.
- This approval does not abridge or supersede the regulatory powers or permit requirements of any federal, state or local agency, special district or department which may retain regulatory or advisory function as specified by statue or ordinance. The applicant shall obtain permits as may be required from each agency.
- An application for a building permit shall be submitted for all construction occurring on the site not otherwise exempt by the California Building Code or any state or local amendment adopted thereto. Prior to the issuance of any building permit, all fees associated with plan check and building inspections, and associated development impact fees established by City ordinance or resolution shall be paid.
- 7. Any asphalt concrete replacement shall conform to the City of Santa Rosa Standard 215.
- 83 8. The sidewalk along the project's Spring Street frontage shall be replaced with a 6' wide sidewalk and an ADA-compliant ramp within the City right of way shall be installed at the Spring St. and Foothill Blvd. intersection.
- 9. Post-development peak stormwater flows to each neighboring property shall be equal or less than existing conditions. (per CMC 19.08 and 16.16, and Santa Rosa Standards)
- 10. Tree preservation measures shall be incorporated into the design of the project 89 improvements and shown on the improvement plans in accordance with the 90 City's Tree Preservation Ordinance (CMC Chapter 19.01) and the project 91 arborist's recommendations. Construction activity shall stay outside the drip line 92 of any protected tree to the maximum extent feasible. Prior to building permit 93 issuance, protective fencing shall be installed subject to the review and approval of the Public Works Department. The project arborist shall be on site during 95 ground-disturbing activities, including all activity associated with digging the 96 foundation. Subsequently, the project arborist shall prepare a letter to the 97

PC Resolution 2018-XX Design Review DR 2018-10 Single-Family Residence at 1406 Foothill Boulevard Page 4


Planning and Building Department stating that the observations were made and that any unexpected root damage was mitigated.

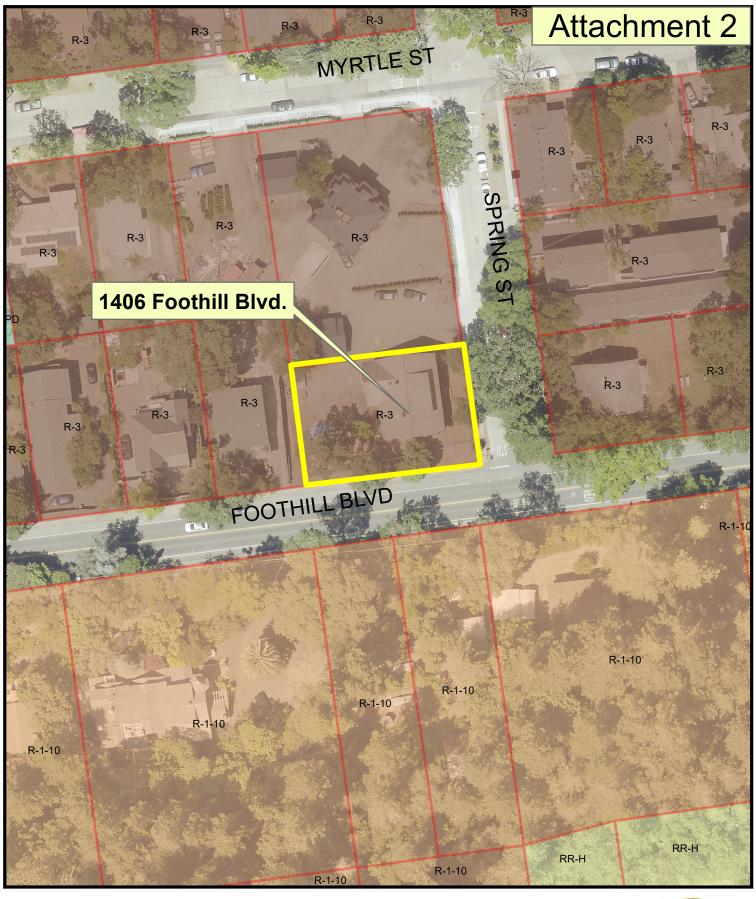

LOCATION MAP
1406 Foothill Boulevard
DR 2018-10



# Calistoga

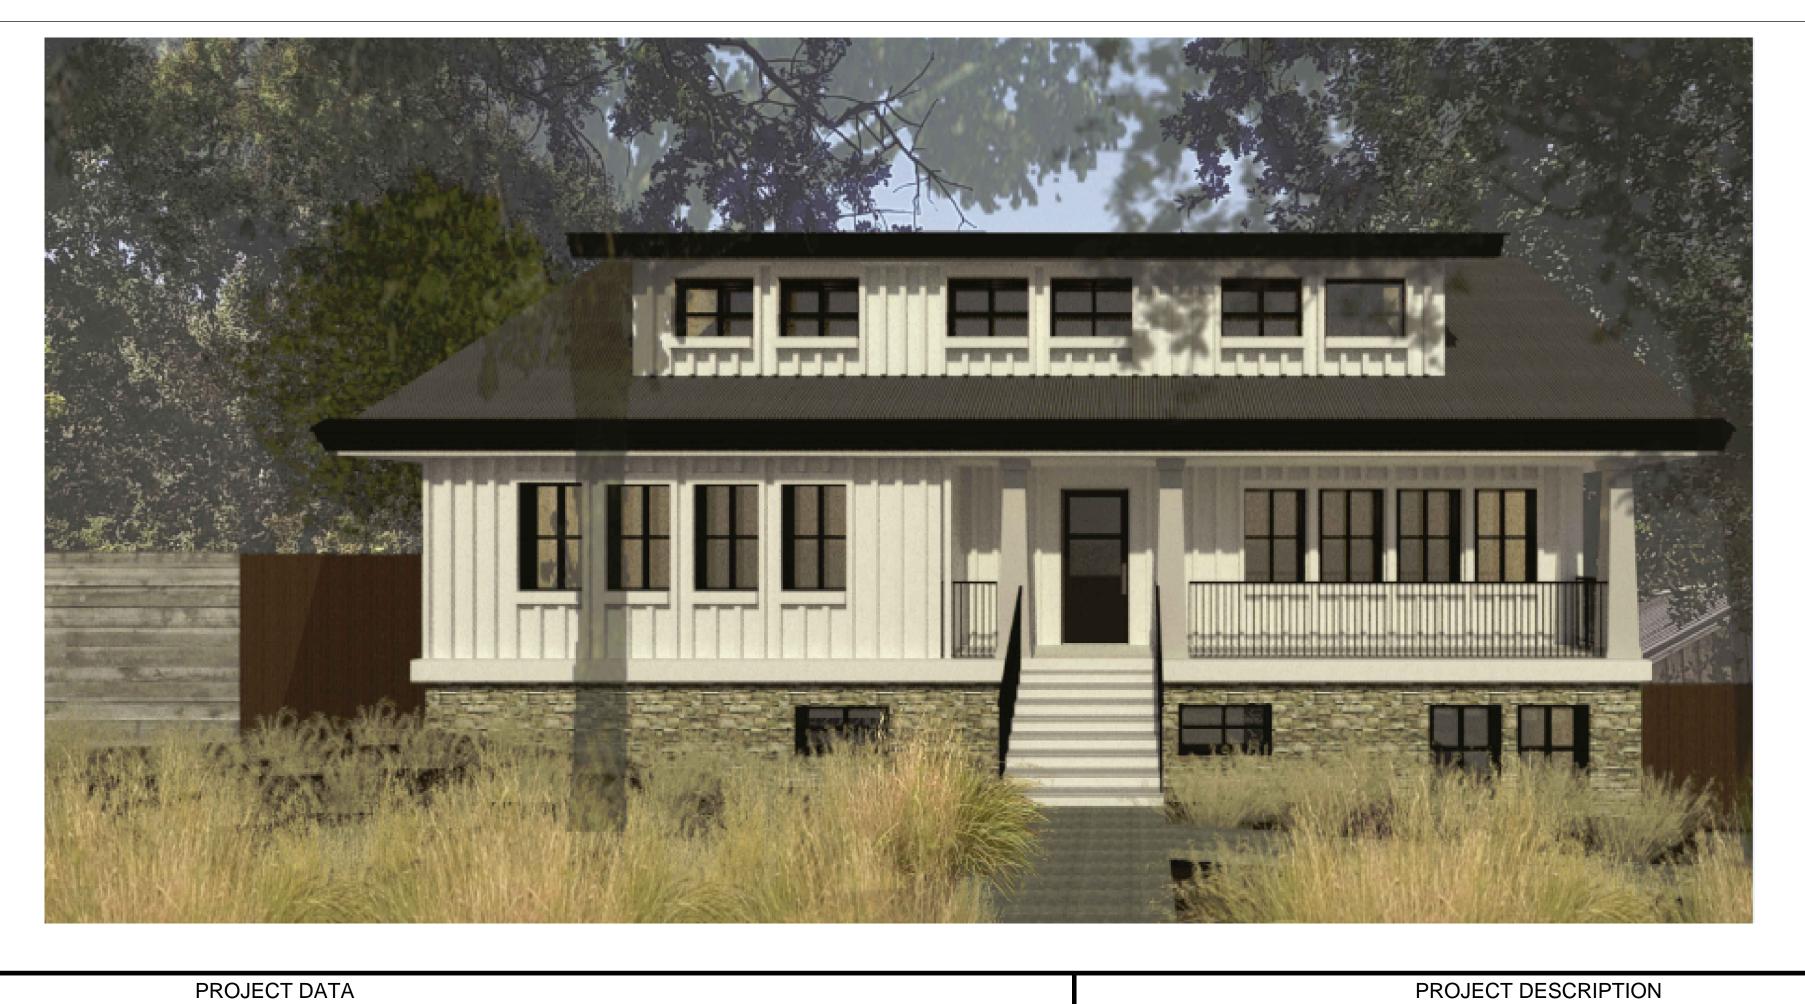

#### PROJECT INFORMATION

ZONING R-3

**CONSTRUCTION TYPE** 

SINGLE FAMILY RESIDENCE

**OCCUPANCIES** 

U - GARAGES

JASON AND JENNIFER PASQUETTI - 3032 THUNDER PROPERTY OWNER VALLEY COURT, SUITE 200, LINCOLN, CA 95648 SITE ADDRESS 1406 FOOTHILL BLVD., CALISTOGA, CA 94515 RESIDENTIAL / PROFESSIONAL OFFICE (R-3) ZONING DOMESTIC & IRRIGATION WATER CITY OF CALISTOGA FIRE PROTECTION WATER SOURCE CITY OF CALISTOGA WASTEWATER DISPOSAL CITY OF CALISTOGA

PARCEL NOTES

011-242-014

ACCORDING TO THE FEDERAL EMERGENCY MANAGEMENT AGENCY (FEMA) FLOOD INSURANCE RATE MAP (FIRM) MAP NUMBER 0655C0229E EFFECTIVE SEPTEMBER 26, 2008, THE PROJECT IS NOT LOCATED WITHIN A SPECIAL FLOOD ZONE

FLOOD HAZARD DISTRICT

+/- 0.22 ACRES OR ±9,600 S.F. PARCEL AREA

SITE COVERAGE HOUSE, POOL & DECK 3,656 SF = 38% SITE COVERAGE THEORETICAL WATER USE ±220 GPD DOMESTIC; ±150 GPD WASTEWATER

#### FLOOR AREA CALCULATIONS:

**BASEMENT FLOOR:** CONDITIONED FLOOR AREA = 326 S.F. UNCONDITIONED FLOOR AREA = 2,509 S.F. TOTAL = 2.835 S.F.

> **UNCOVERED DECK:** 569 S.F.

POOL + COPING: 252 S.F.

2,712 S.F.

FIRST FLOOR: CONDITIONED FLOOR AREA = 2,020 S.F. COVERED PORCHES = 744 S.F. STAIRS (SPRING ST.) = 54 S.F.

SECOND FLOOR: CONDITIONED FLOOR AREA = 1,751 S.F.

TOTAL CONDITIONED AREA = 4,097 S.F. TOTAL UNCONDITIONED AREA = 2,509 S.F. TOTAL COVERED PORCHES = 744 S.F. TOTAL UNCOVERED DECK = 569 S.F. POOL + COPING = 252 S.F. STAIRS (SPRING ST.) = 54 S.F. TOTAL AREA = 8,225 S.F. THE EXISTING SITE CONDITIONS CONSIST OF A VACANT RESIDENTIAL LOT IN WHICH THE PREVIOUS SINGLE FAMILY HOME WAS DEMOLISHED THIS LAST SUMMER UNDER A CITY PERMIT. WE WISH TO BUILD A NEW SINGLE FAMILY HOME OF SIMILAR STYLE TO THE ORIGINAL HOME CONSISTENT WITH THE PLANS SUBMITTED FOR THE VARIANCE RESOLUTION WHICH WAS APPROVED AND ADOPTED ON JULY 11, 2018 BY A UNANIMOUS VOTE BY THE CALISTOGA PLANNING COMMISSION.

THE PROPOSED RESIDENCE WILL CONSIST OF A BASEMENT LEVEL WITH 2 STORIES ABOVE. THREE BEDROOMS AND 3-1/2 BATHROOMS. TWO COVERED PORCHES AND A LOWER DECK WITH A PLUNGE POOL. LANDSCAPING WILL BE MINIMAL WITH LESS THAN 500 S.F. OF PLANTED

## NAPA RIVER PROJECT AREA -

VICINITY MAP

SHEET INDEX

**PLAN SET** 

ARCHITECTURAL SHEETS

A0.0 COVER SHEET

A0.1 SITE PHOTOS

A1.0 OVERALL SITE A2.0 BASEMENT LEVEL FLOOR PLAN A2.1 FIRST LEVEL FLOOR PLAN A2.2 SECOND LEVEL FLOOR PLAN

A3.0 EAST ELEVATION. SPRING ST. A3.1 SOUTH ELEVATION. FOOTHILL BLVD. A3.2 WEST ELEVATION A3.3 NORTH ELEVATION A3.4 SPRING STREET ELEVATION & FOOTHILL BLVD.

#### CR COLOR RENDERING

L1.0 LANDSCAPE / FENCE PLAN

ELEVATION w/ SITE PHOTOS

#### CIVIL SHEETS

C0.0 CIVIL COVER SHEET C0.1 CIVIL GENERAL NOTES C1.0 SITE DEMOLITION PLAN C2.0 SITE GRADING & STORM WATER CONTROL PLAN C3.0 EROSION & SEDIMENT CONTROL PLAN C4.0 SITE DETAILS


#### DOCUMENTS


PRELIMINARY REPORT BASMAA VARIANCE RESOLUTION Drawn by: DBM 12/09/18 NONE bmittals / Revisions:


**COVER SHEET** 


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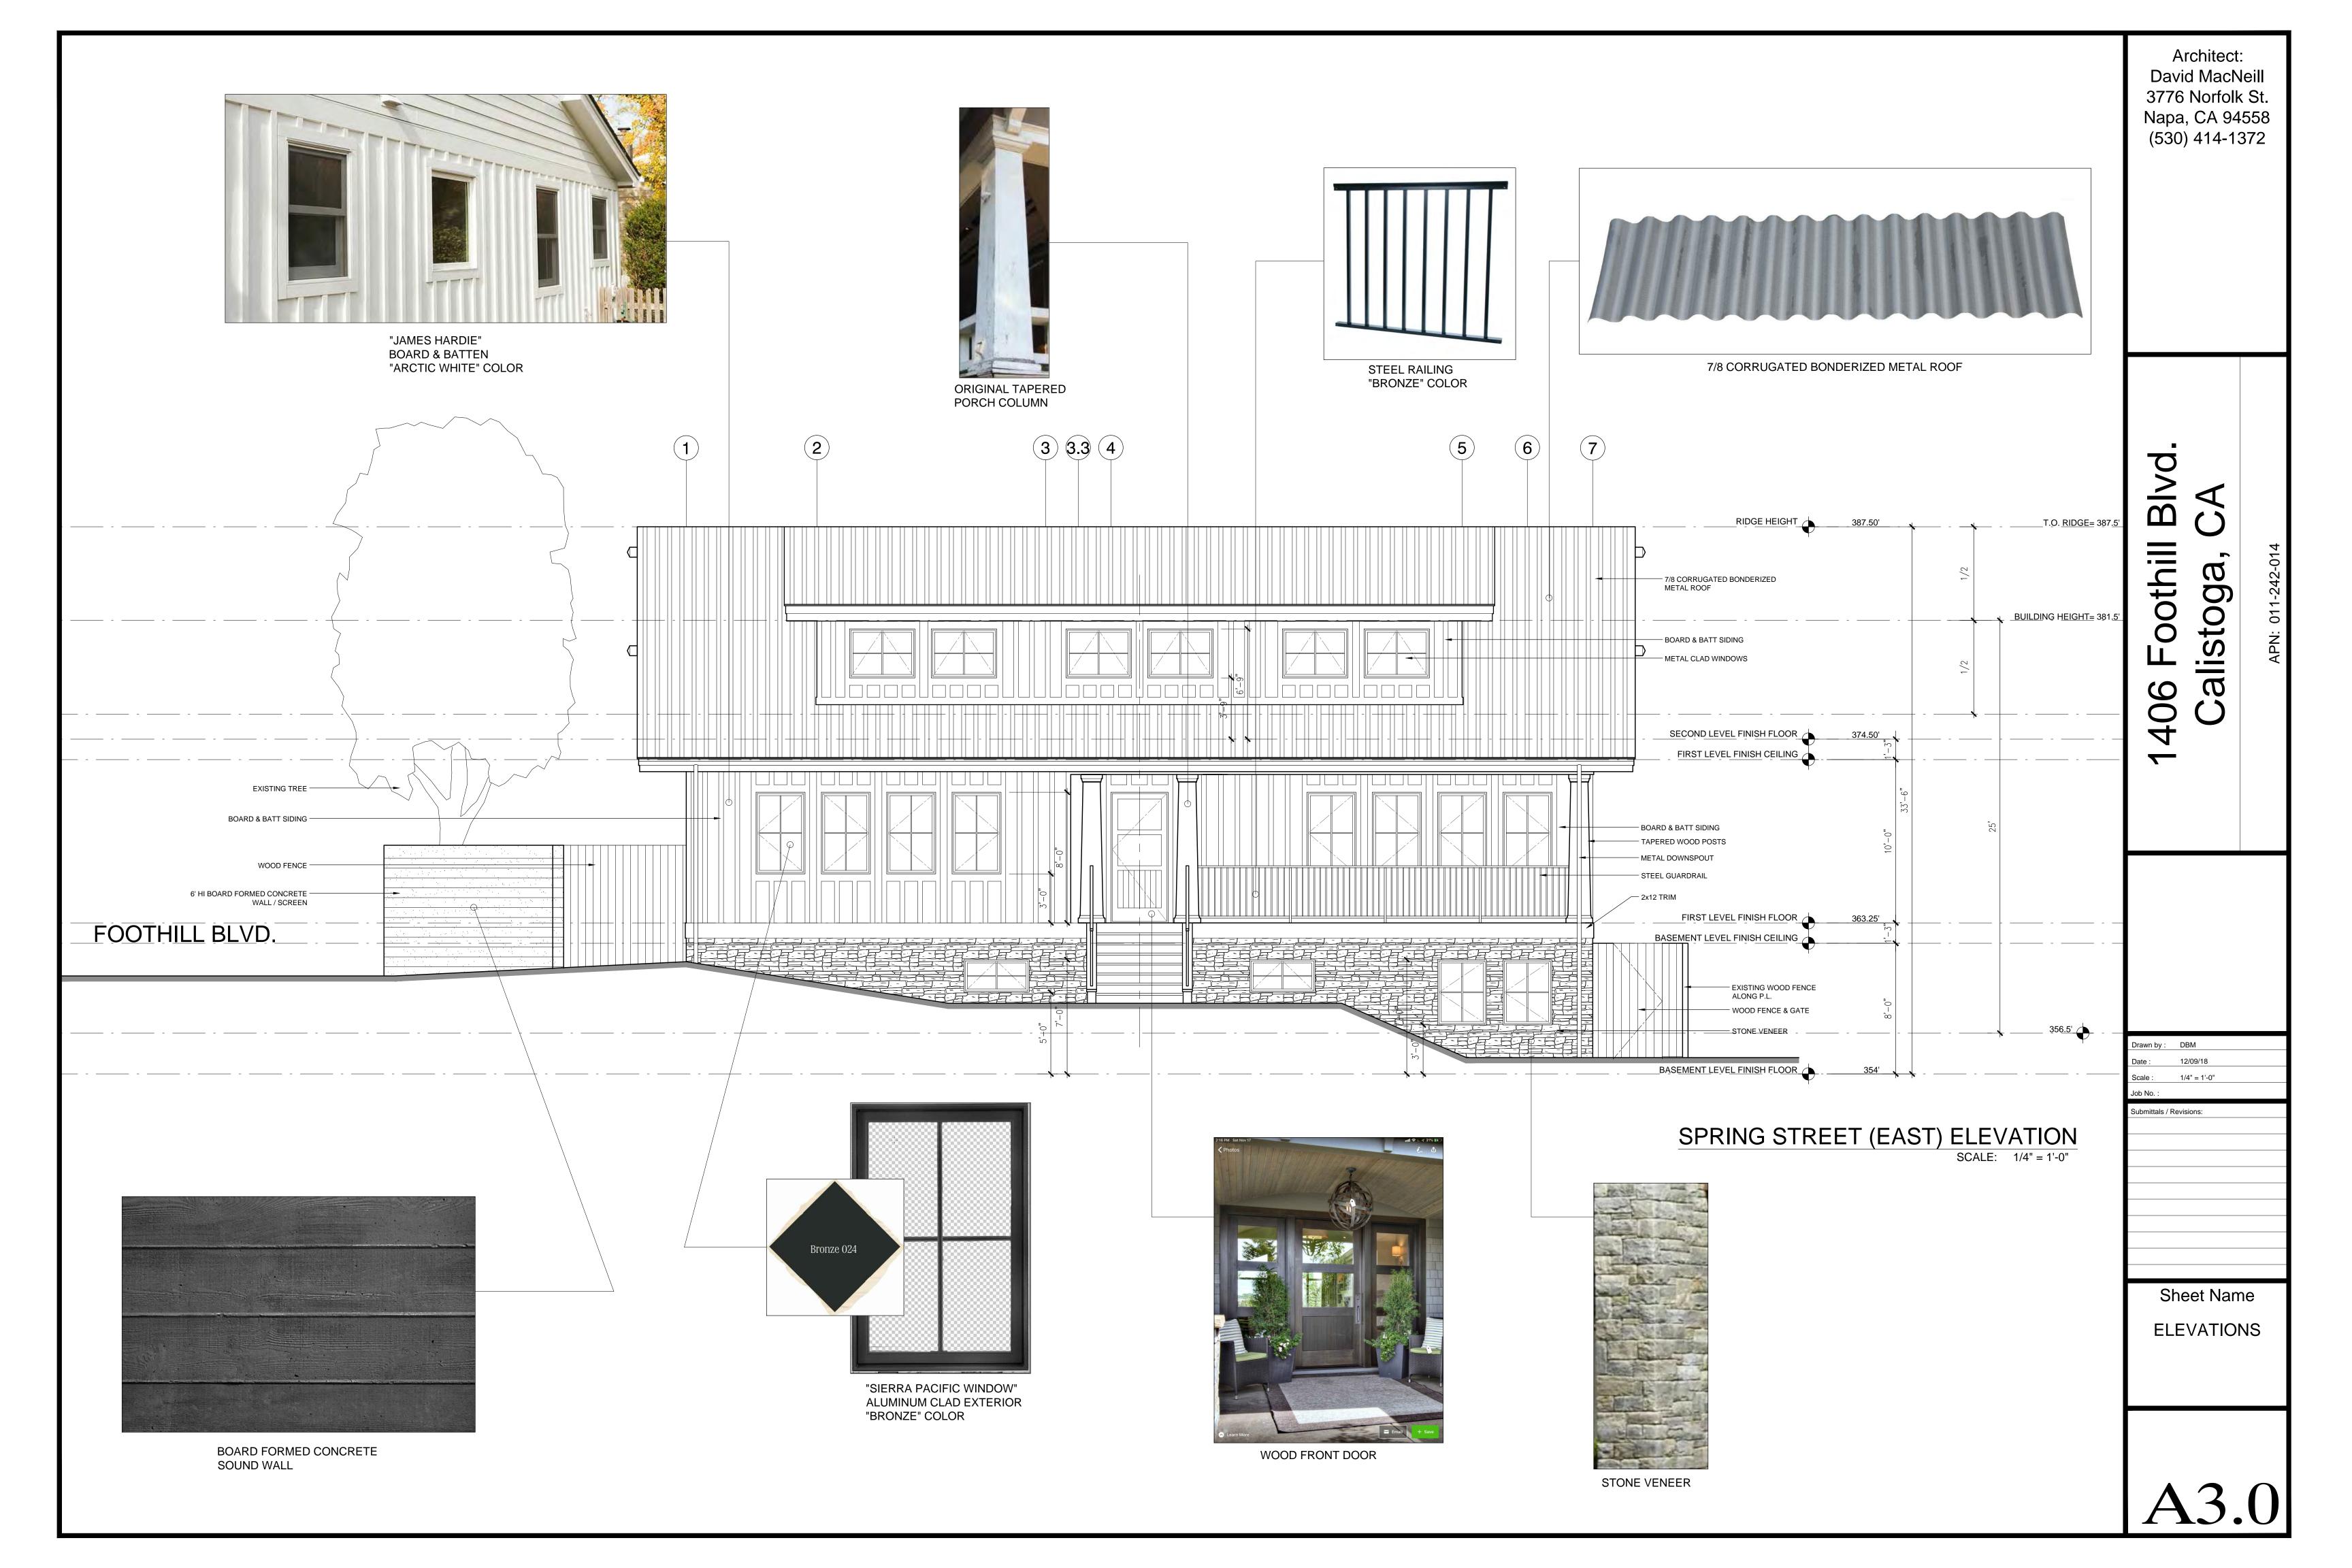





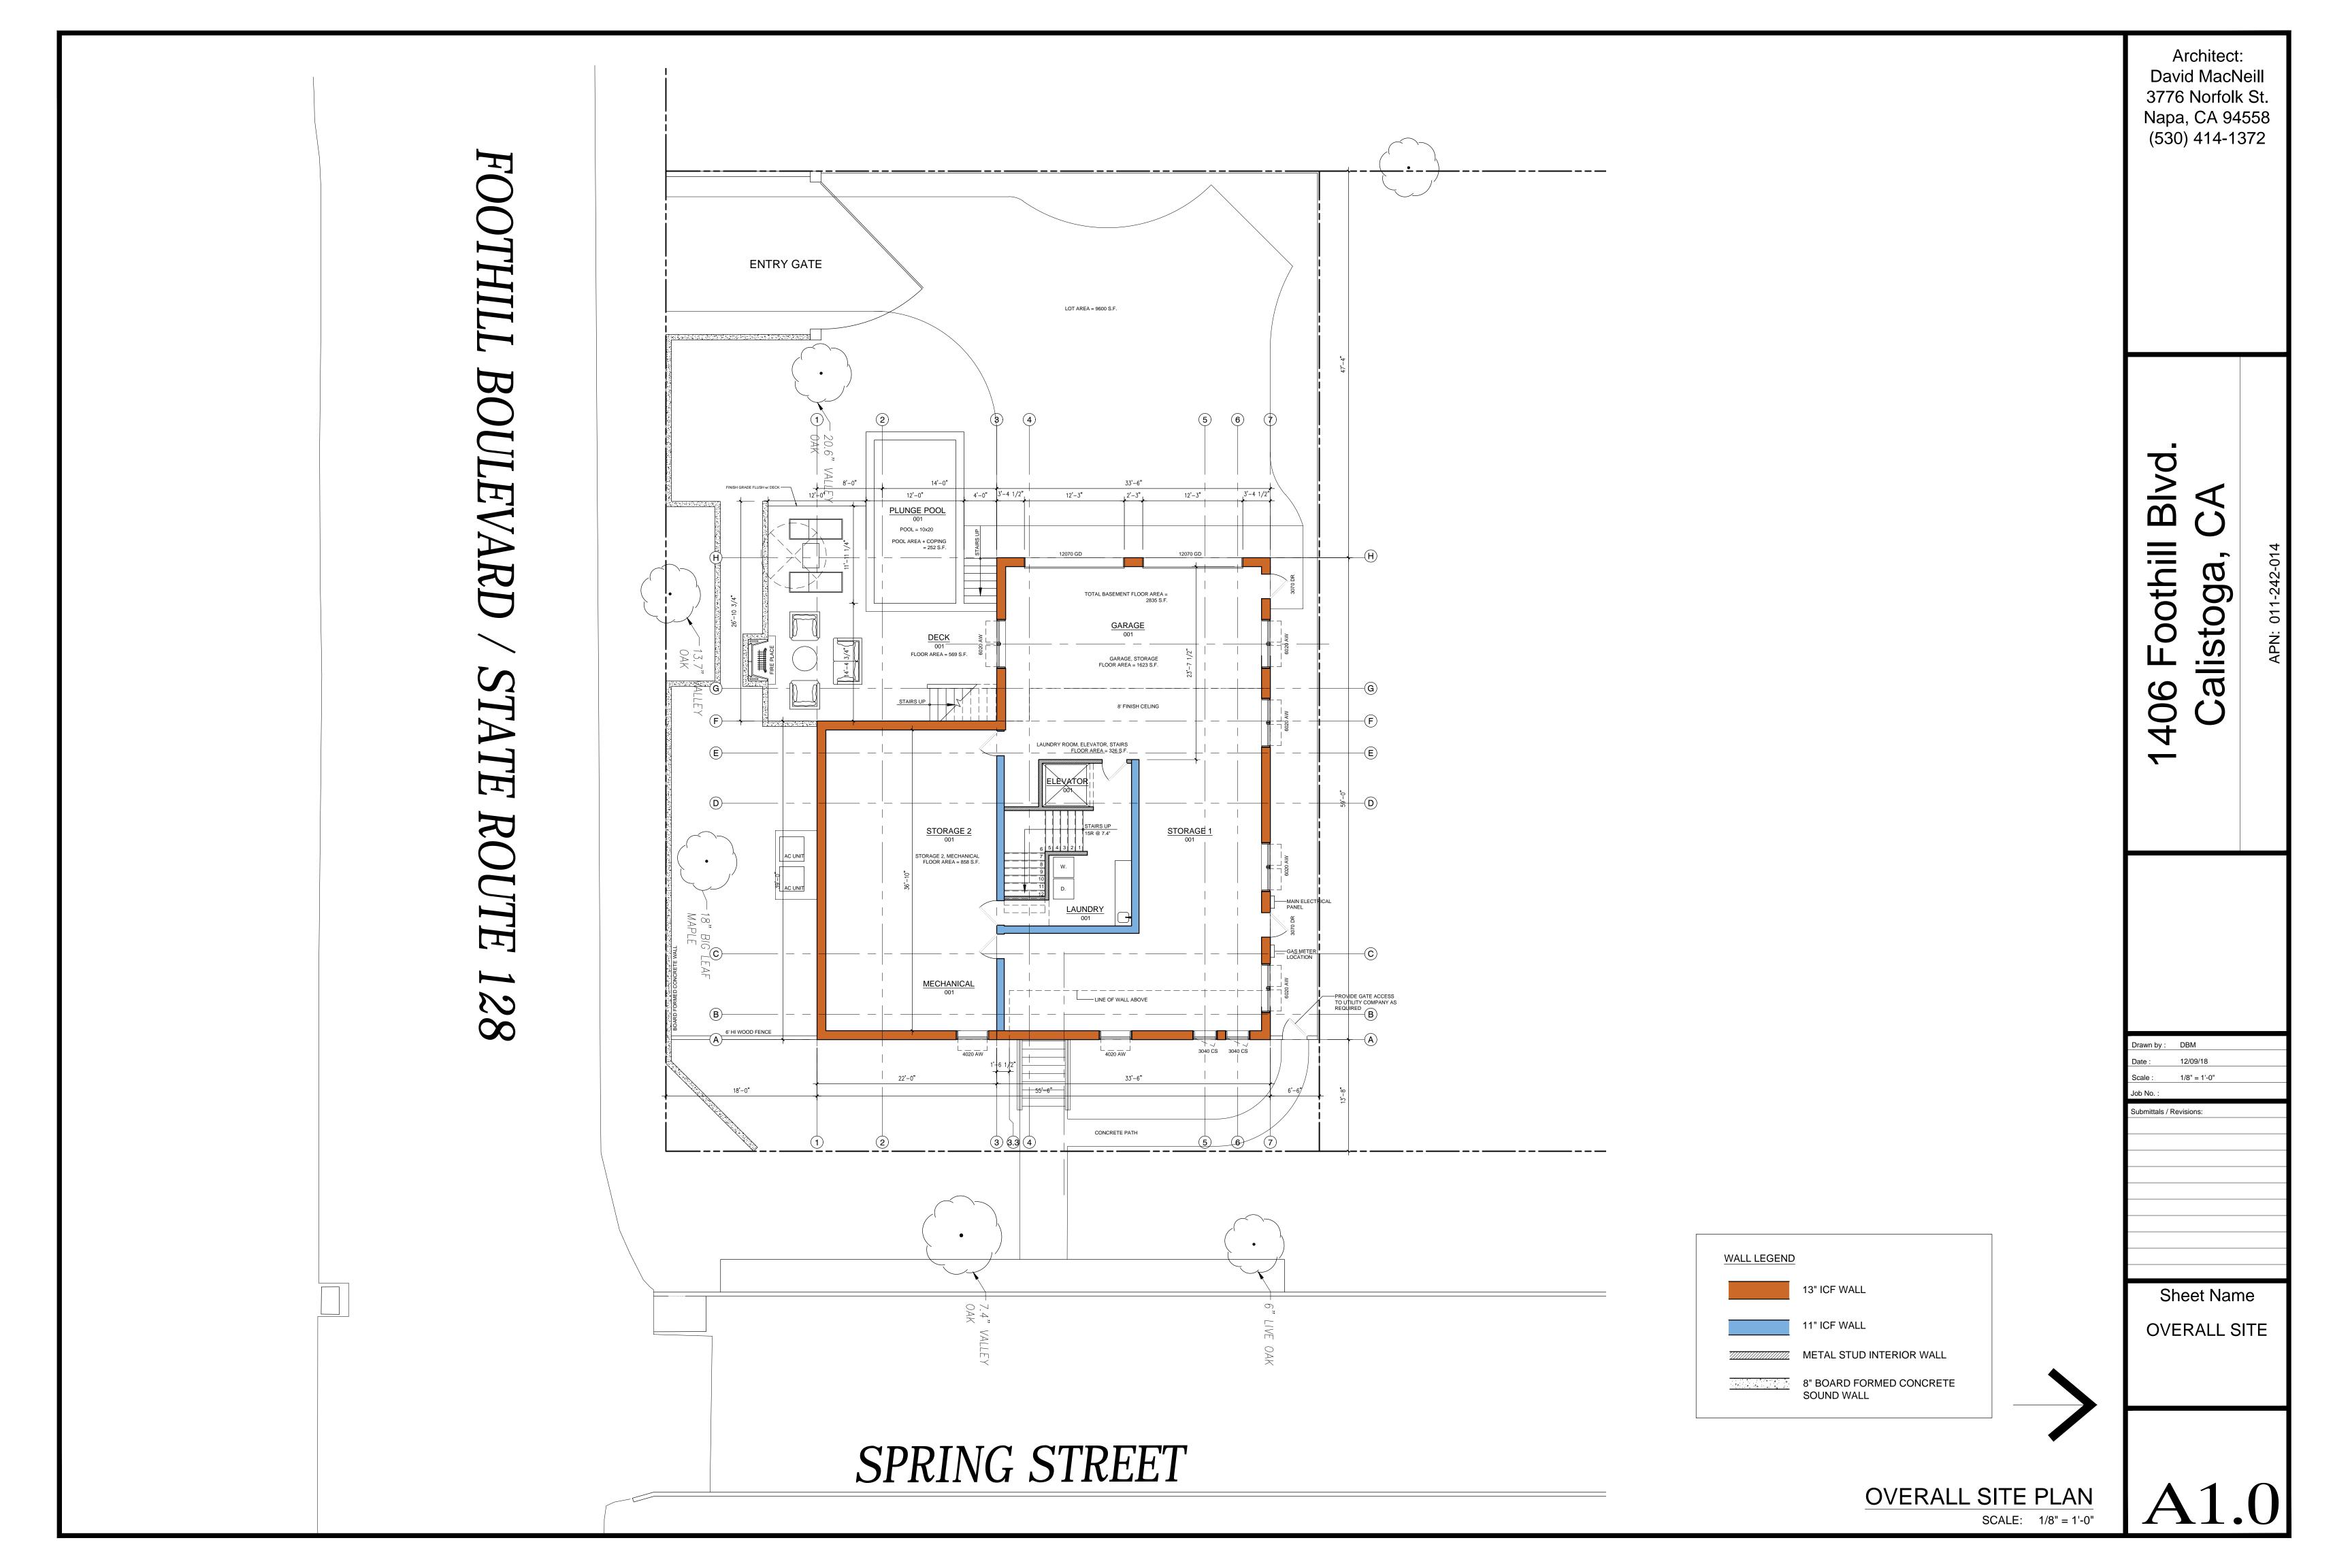


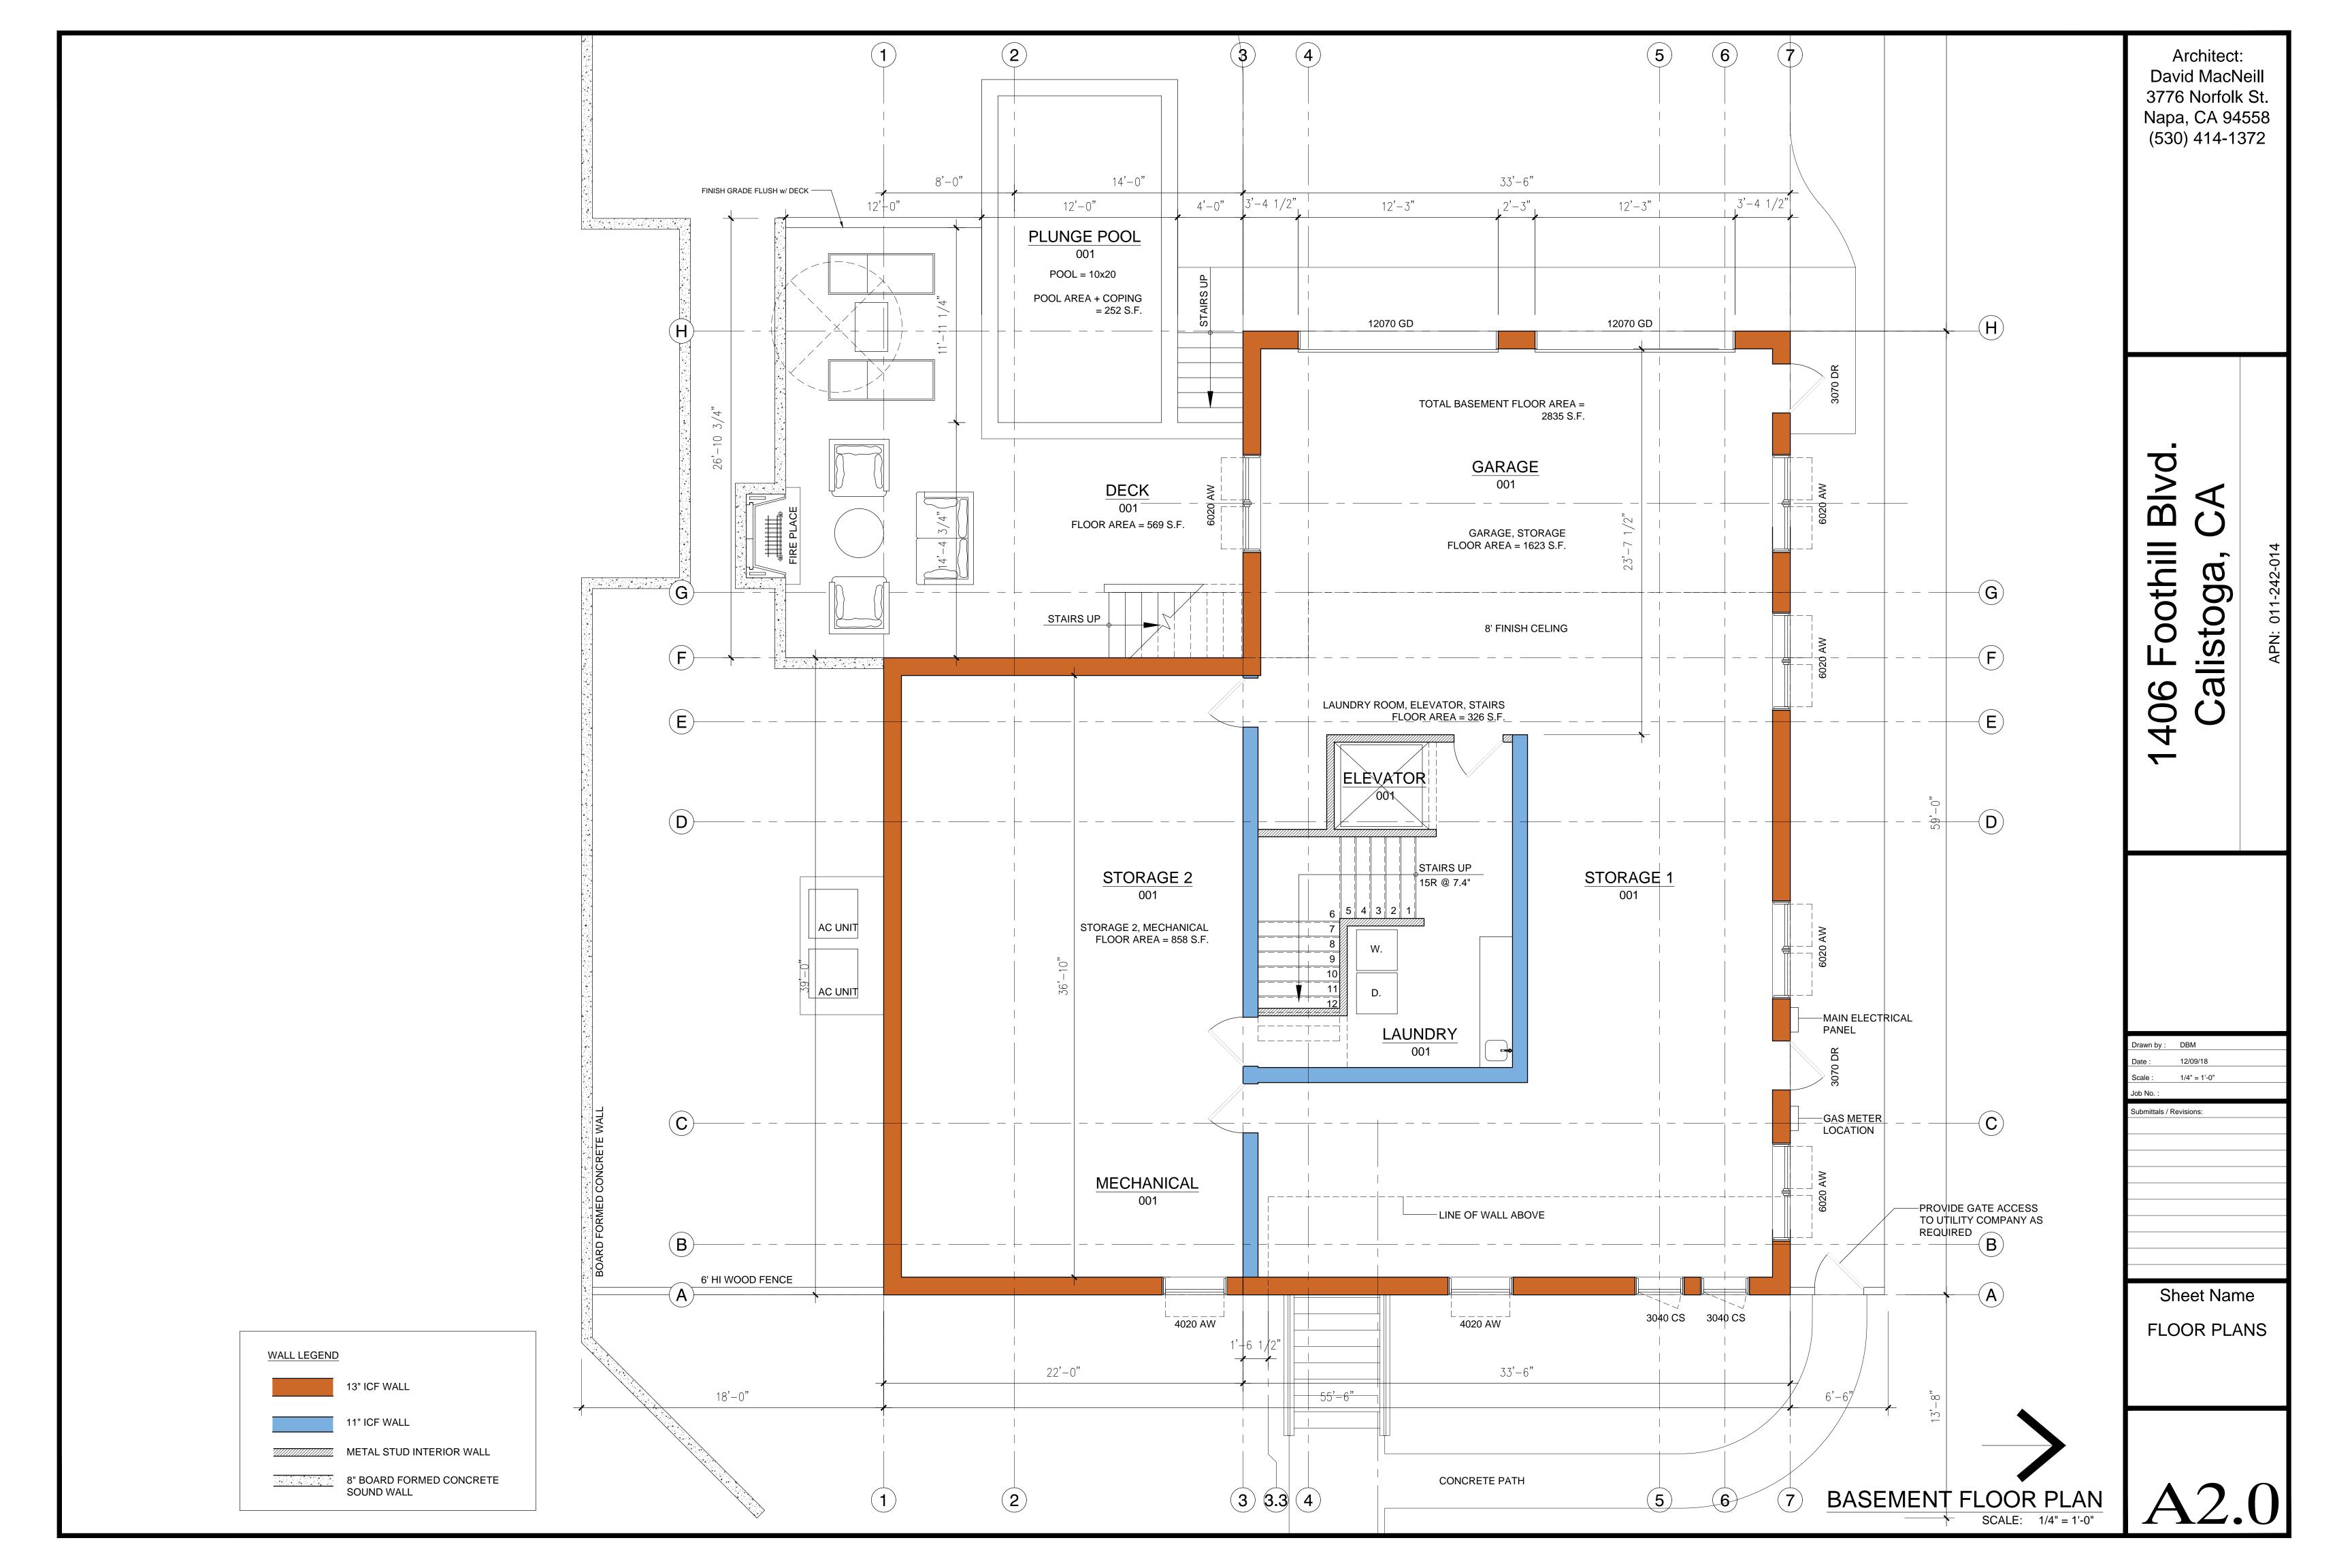


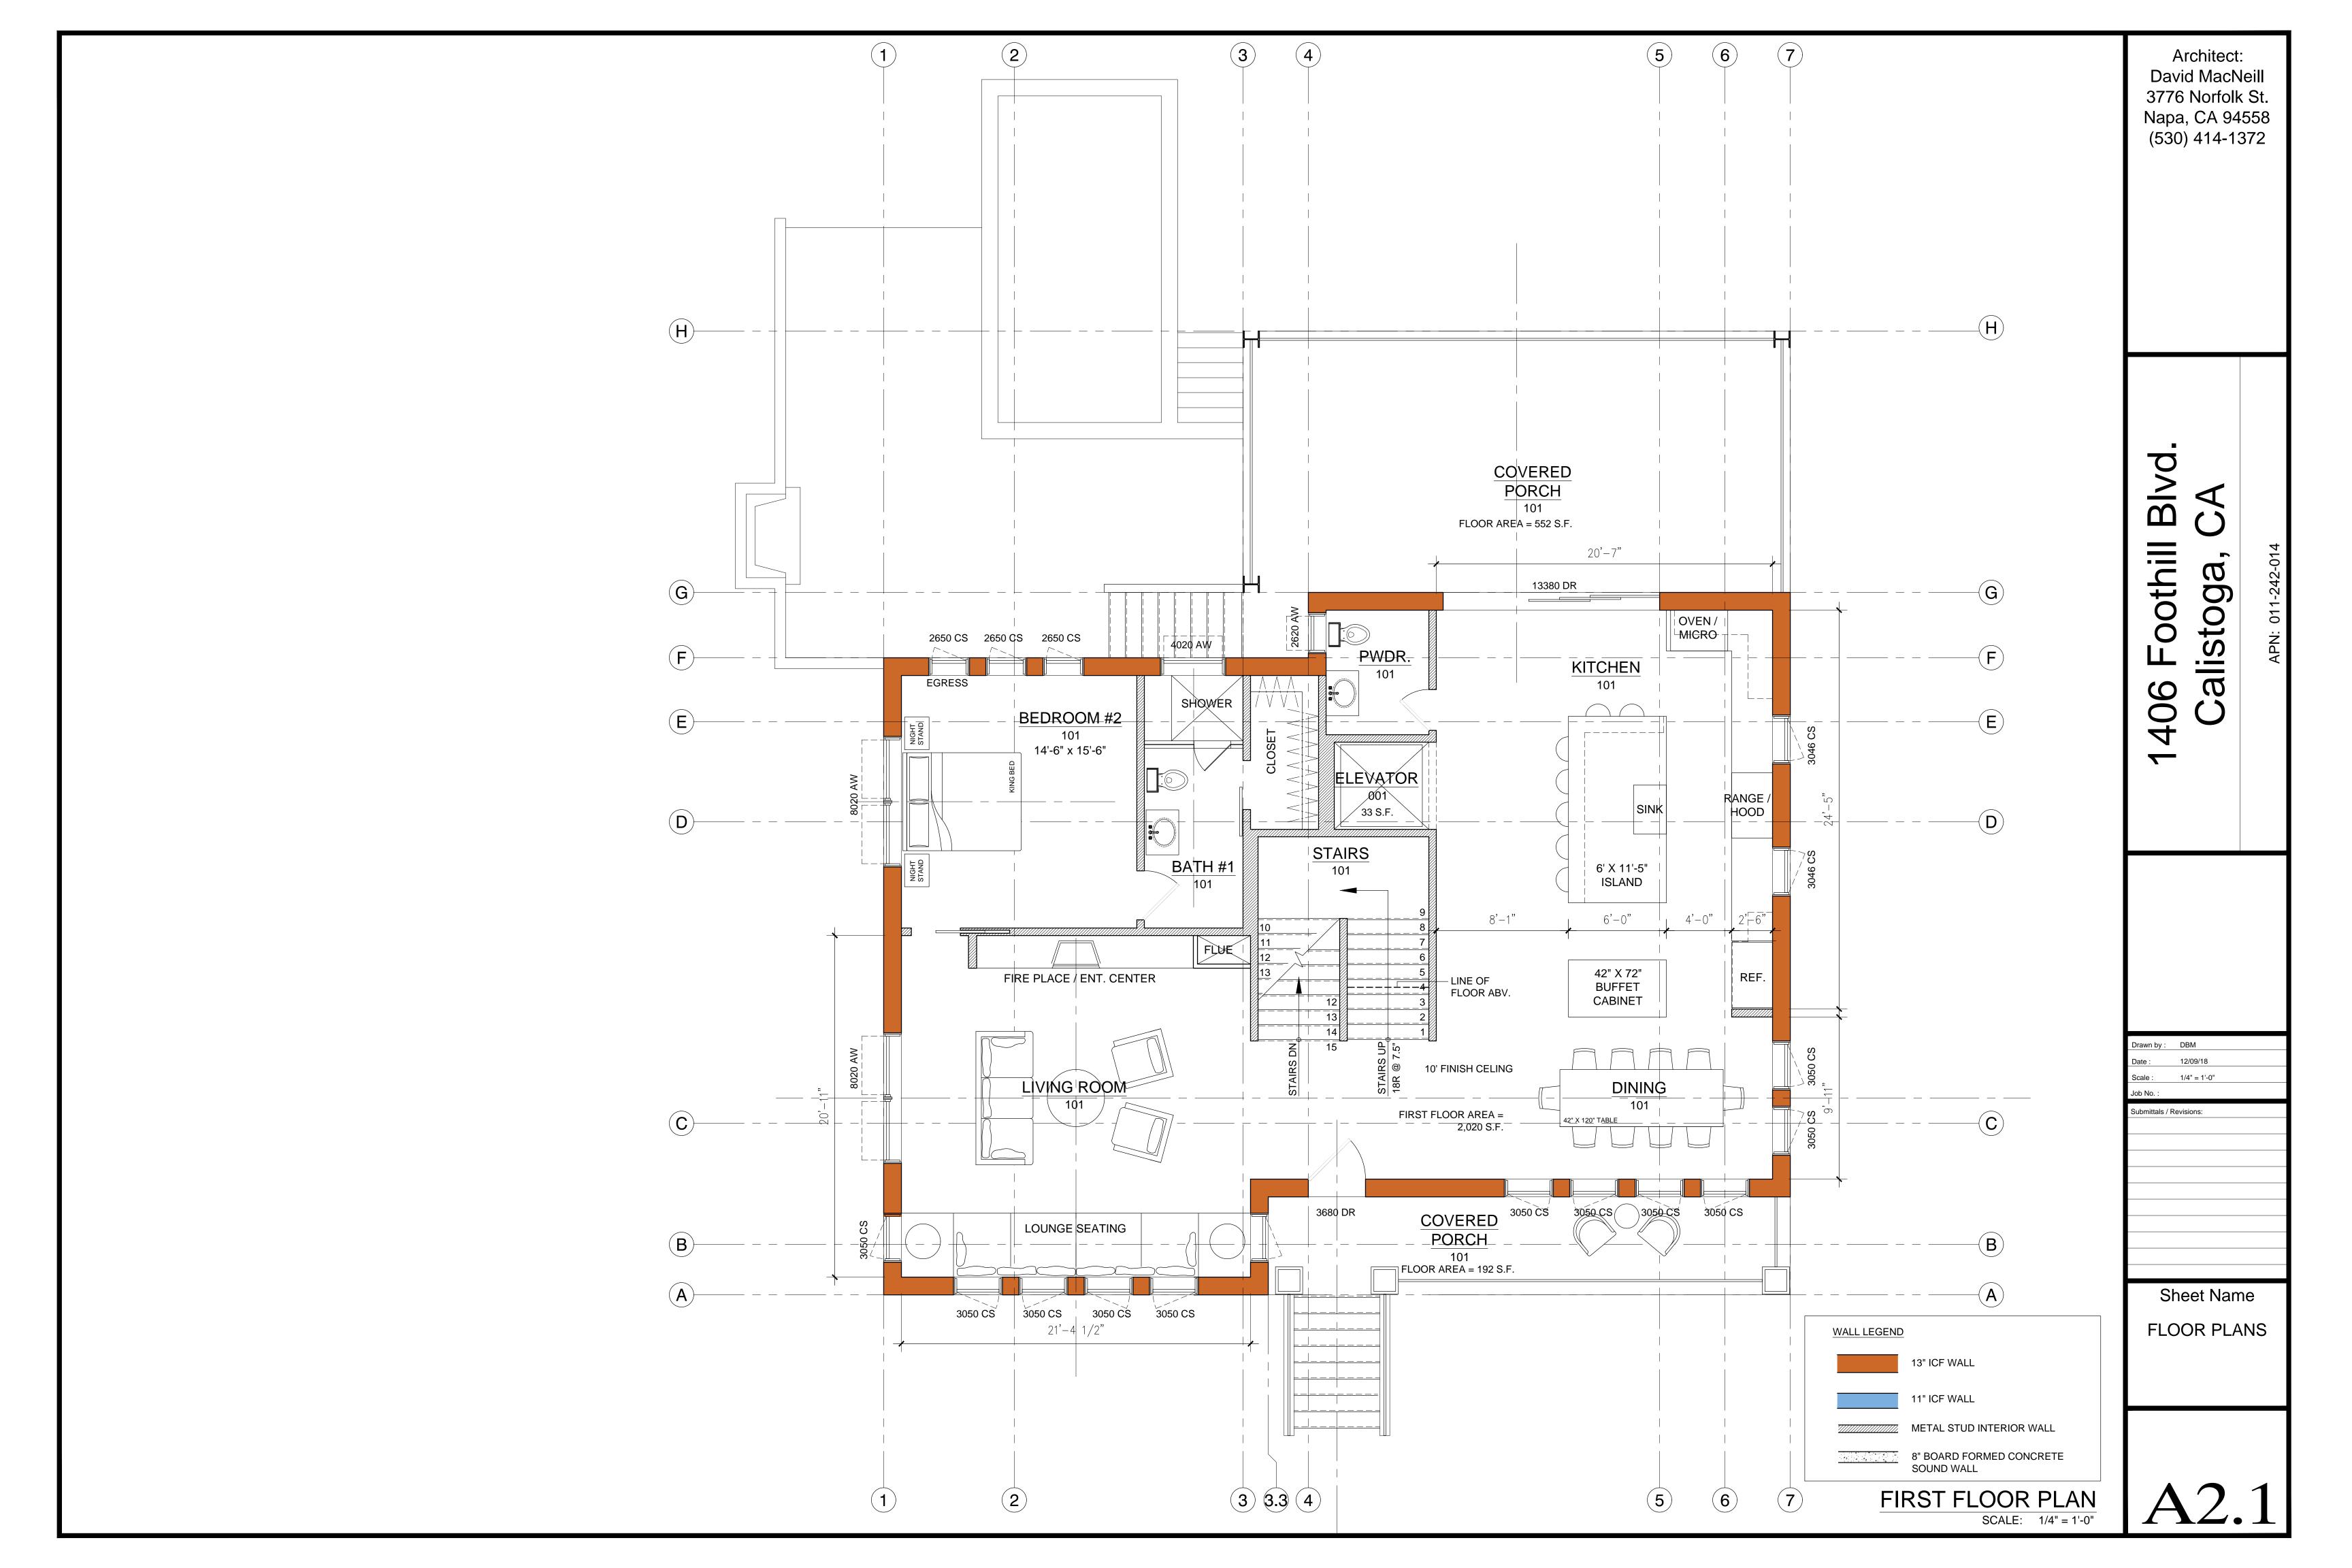

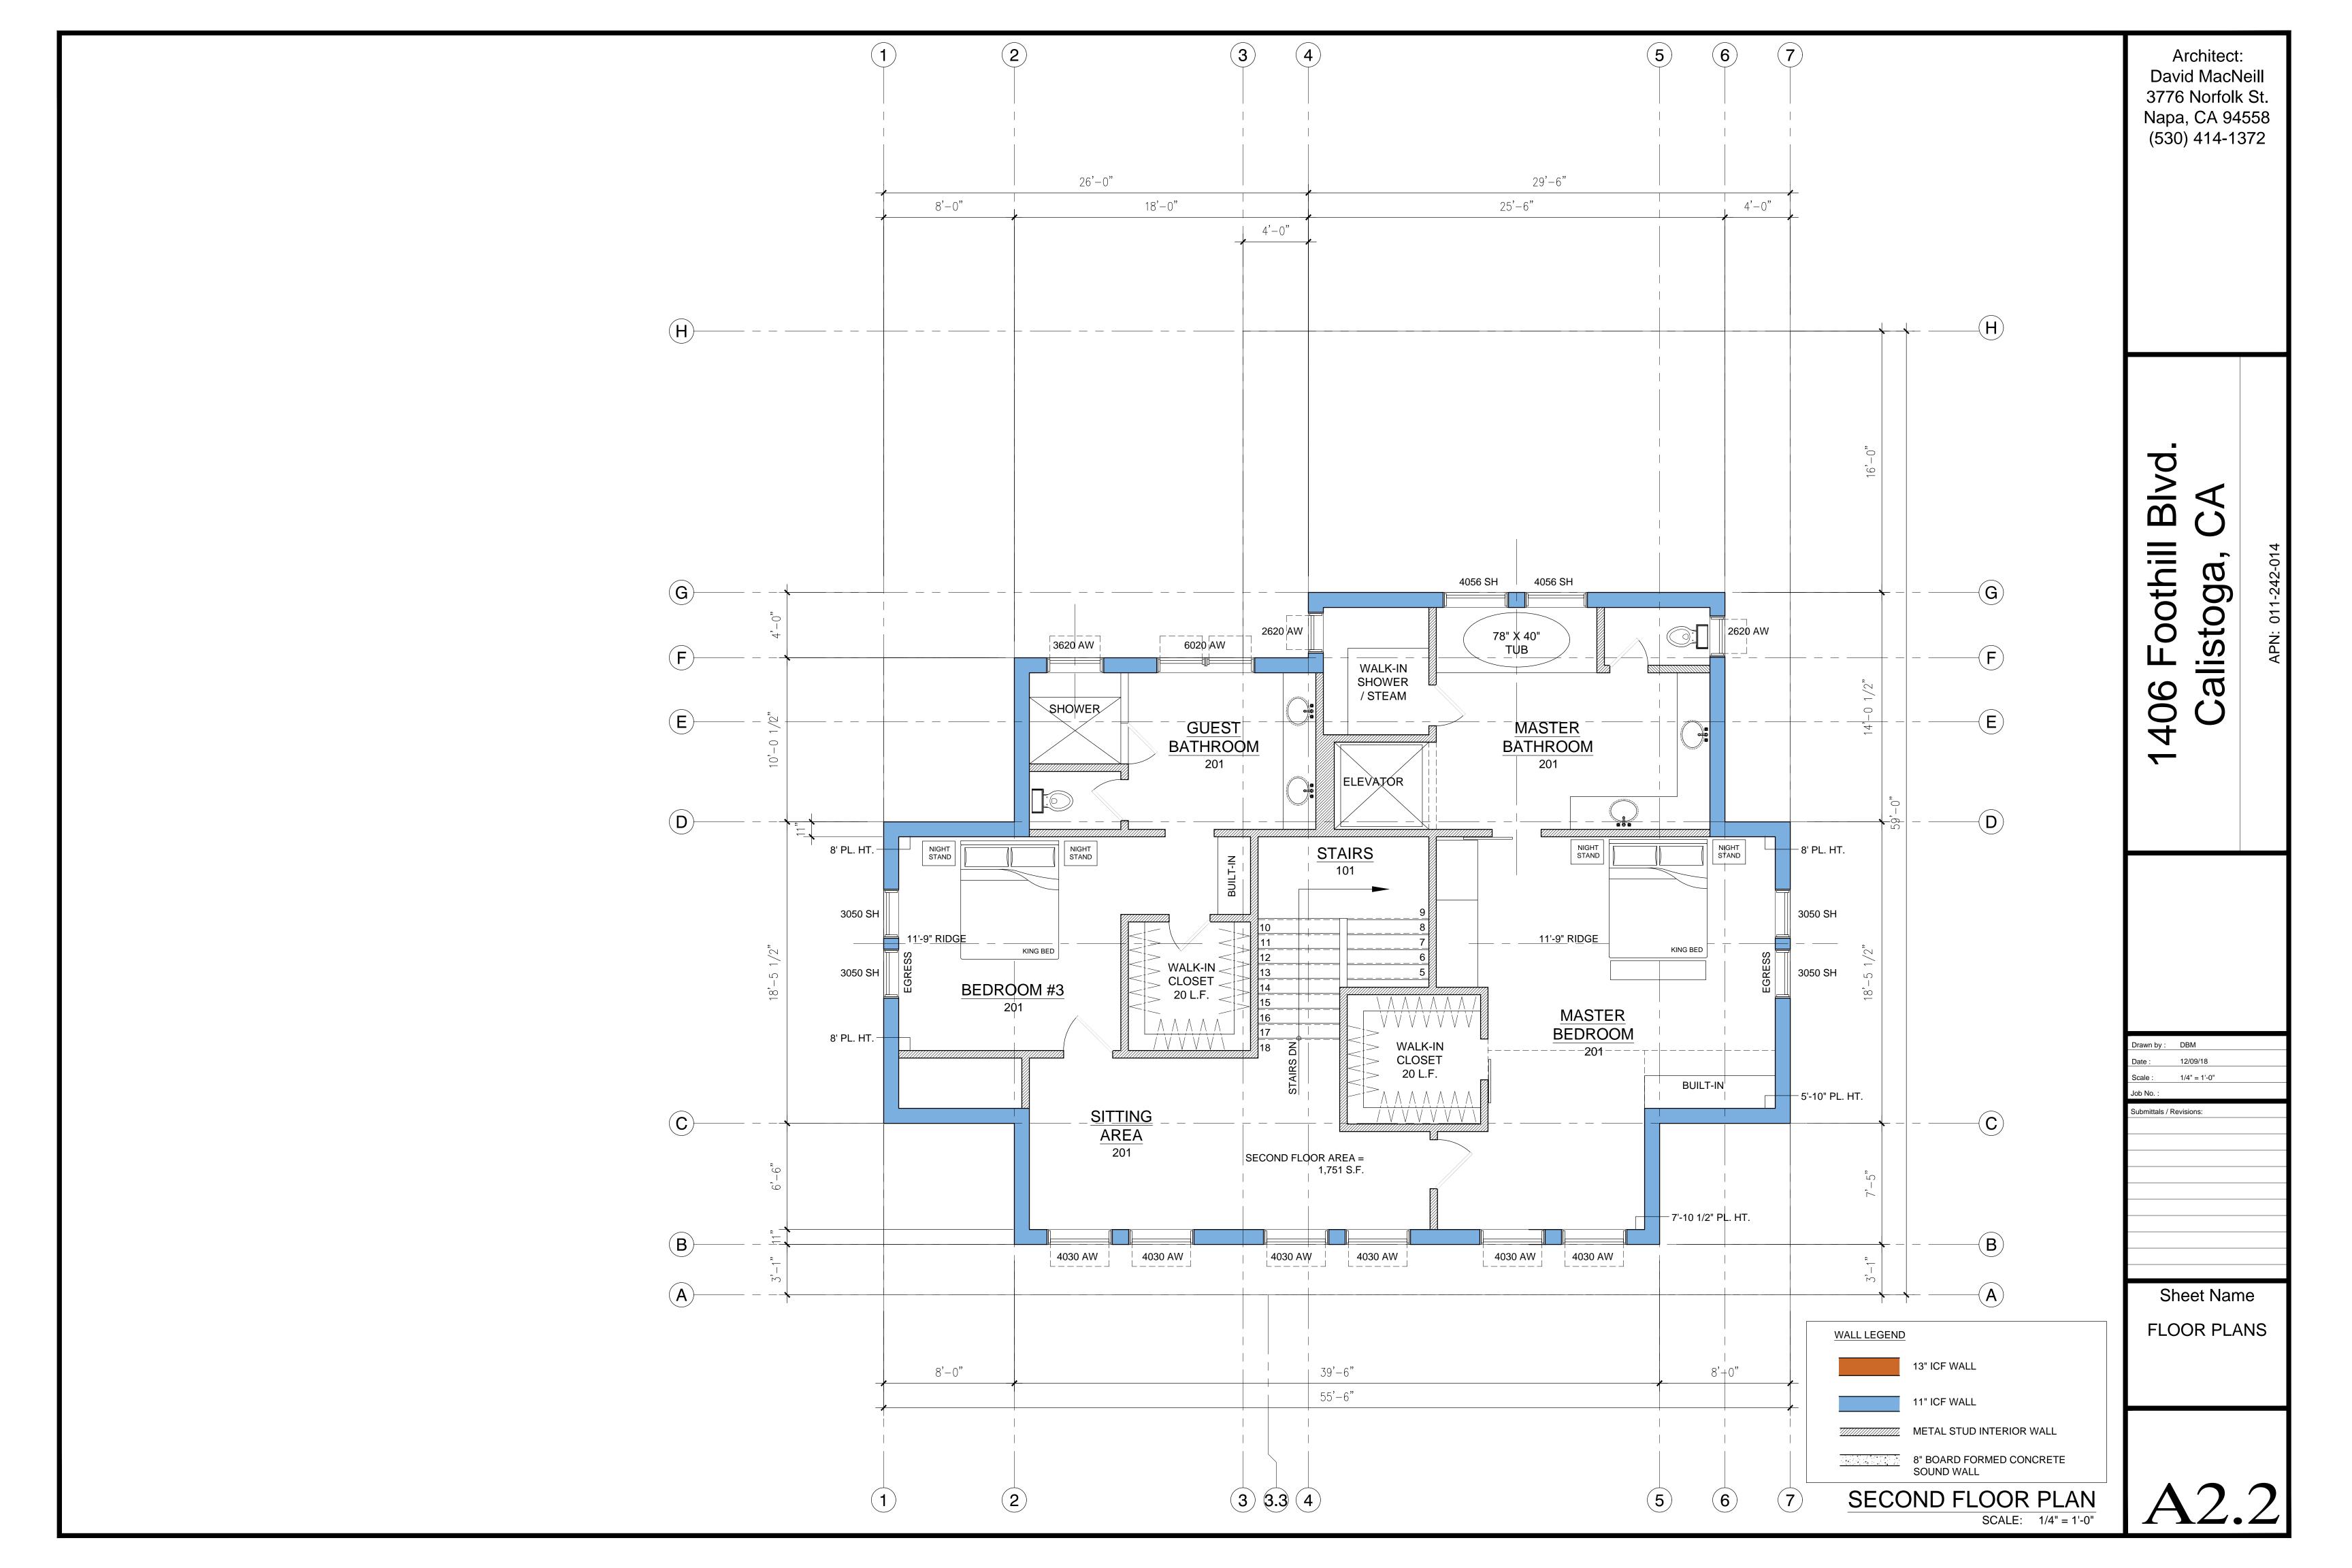

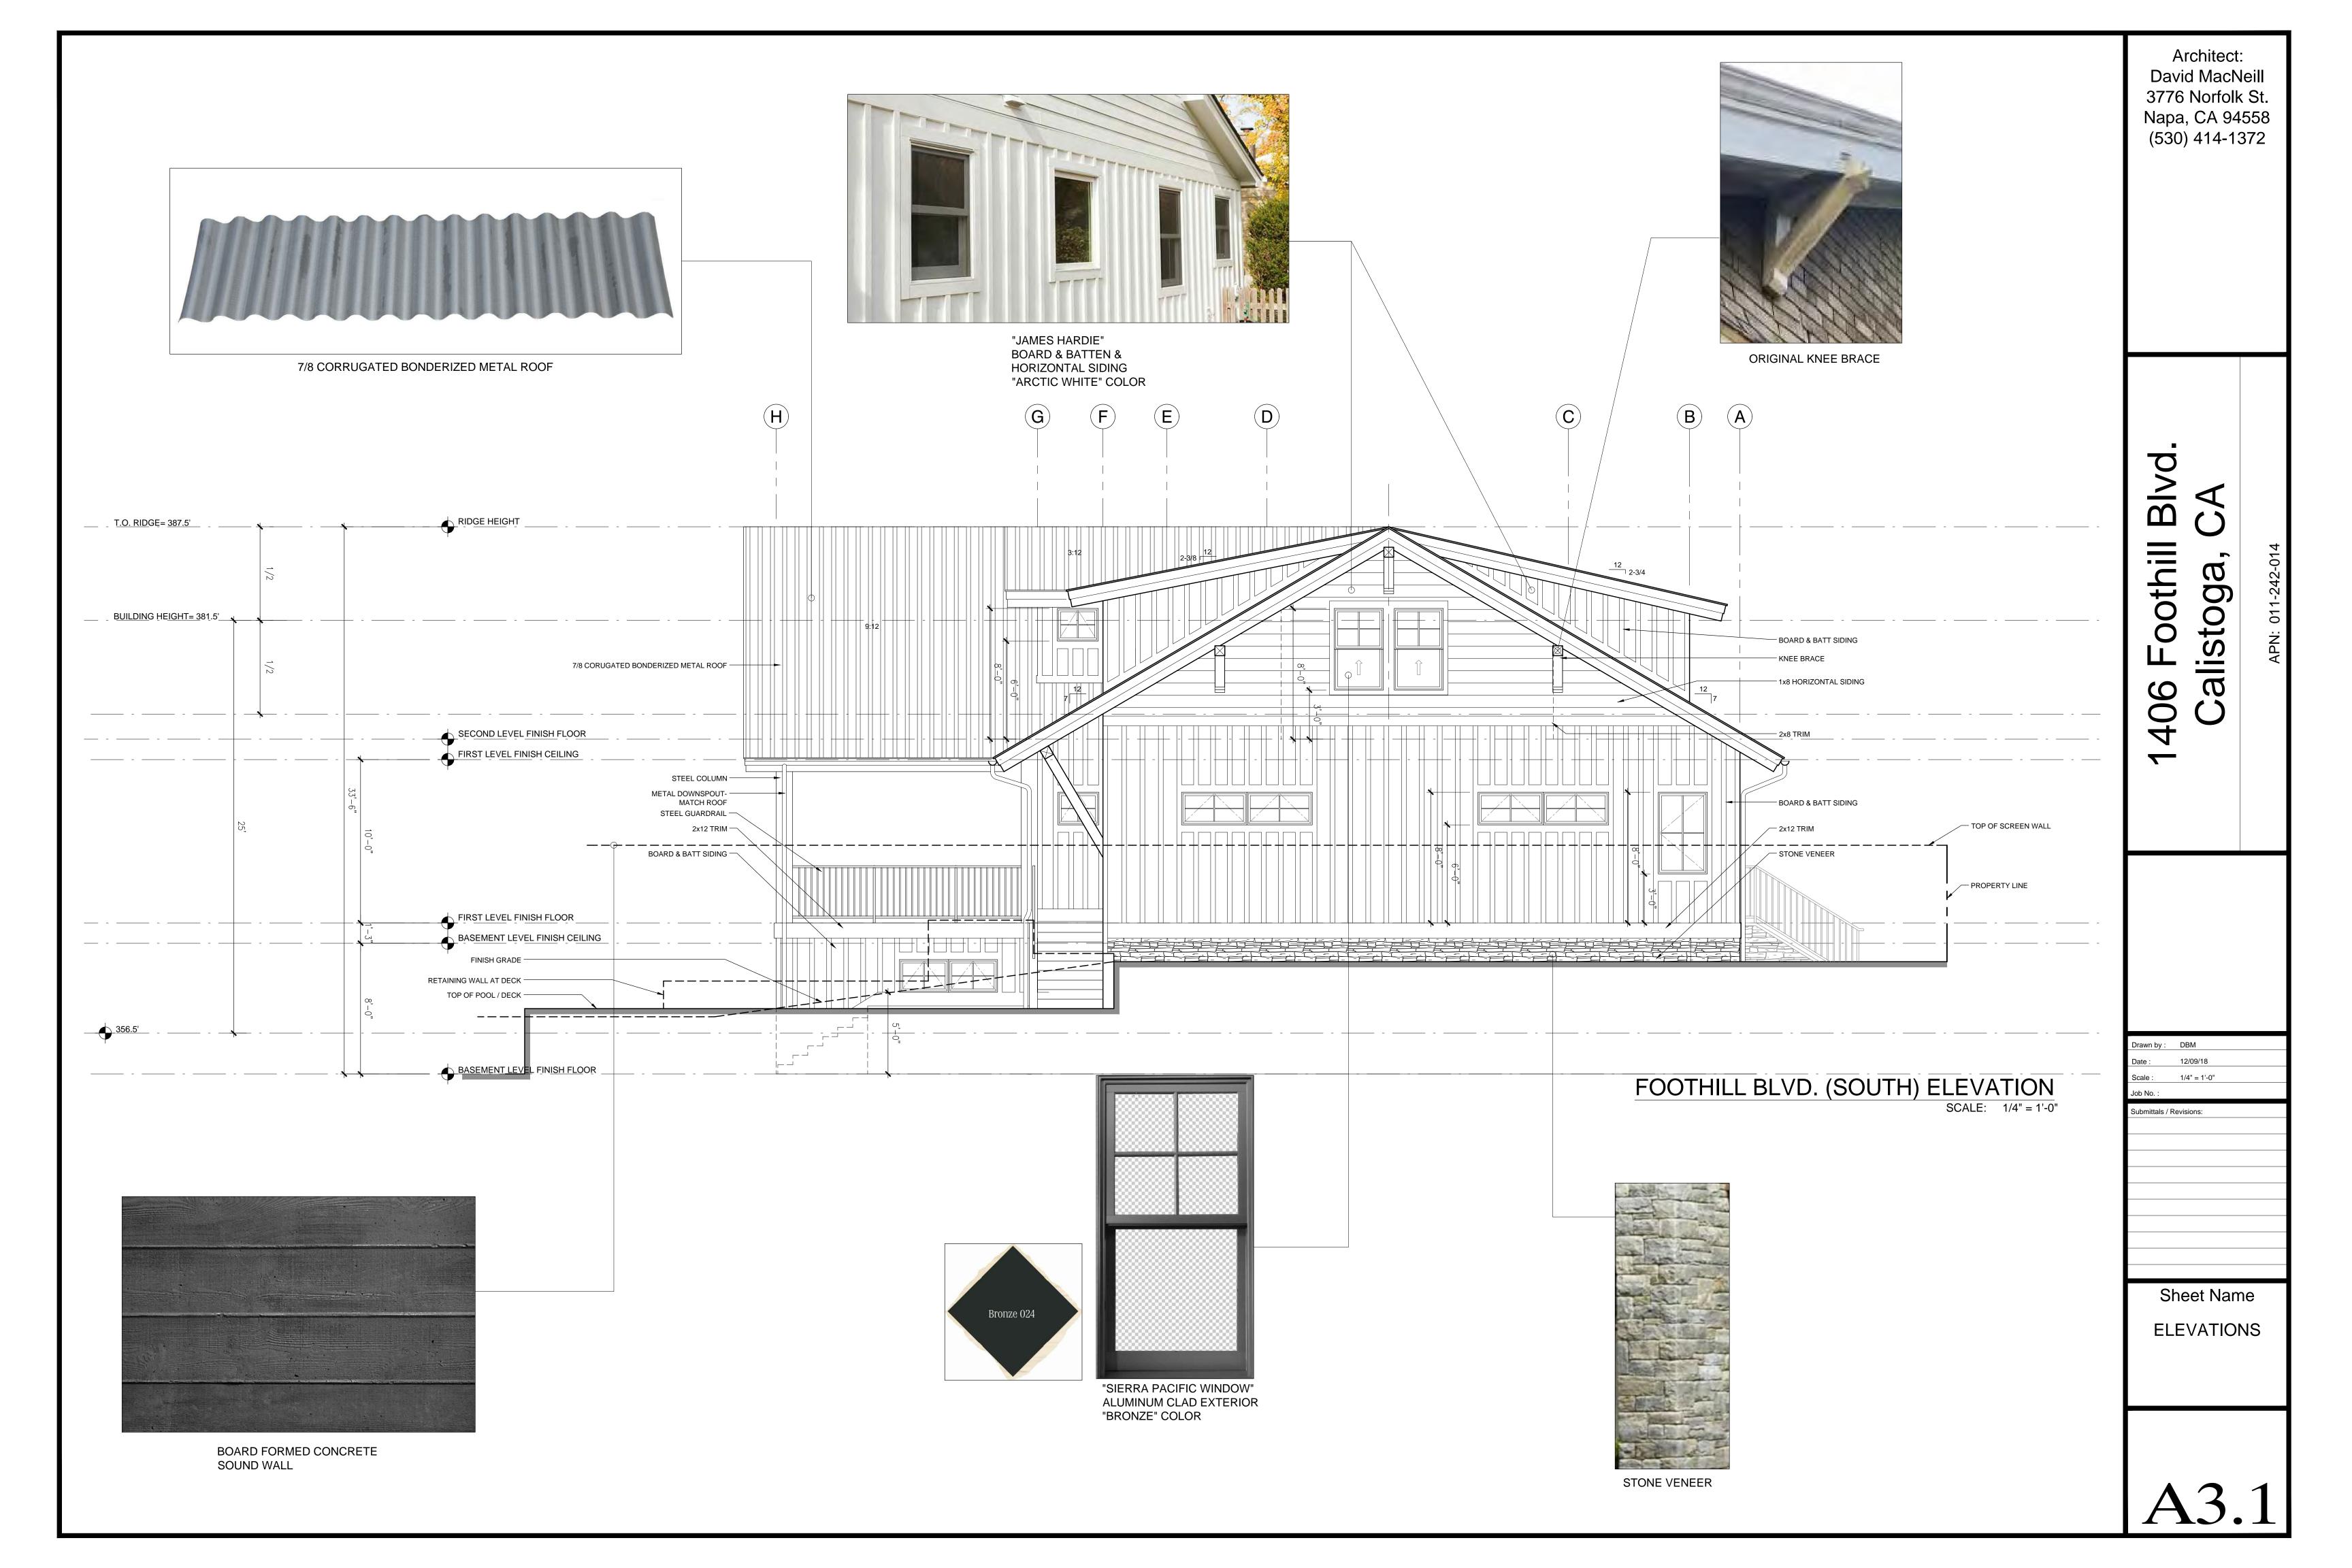

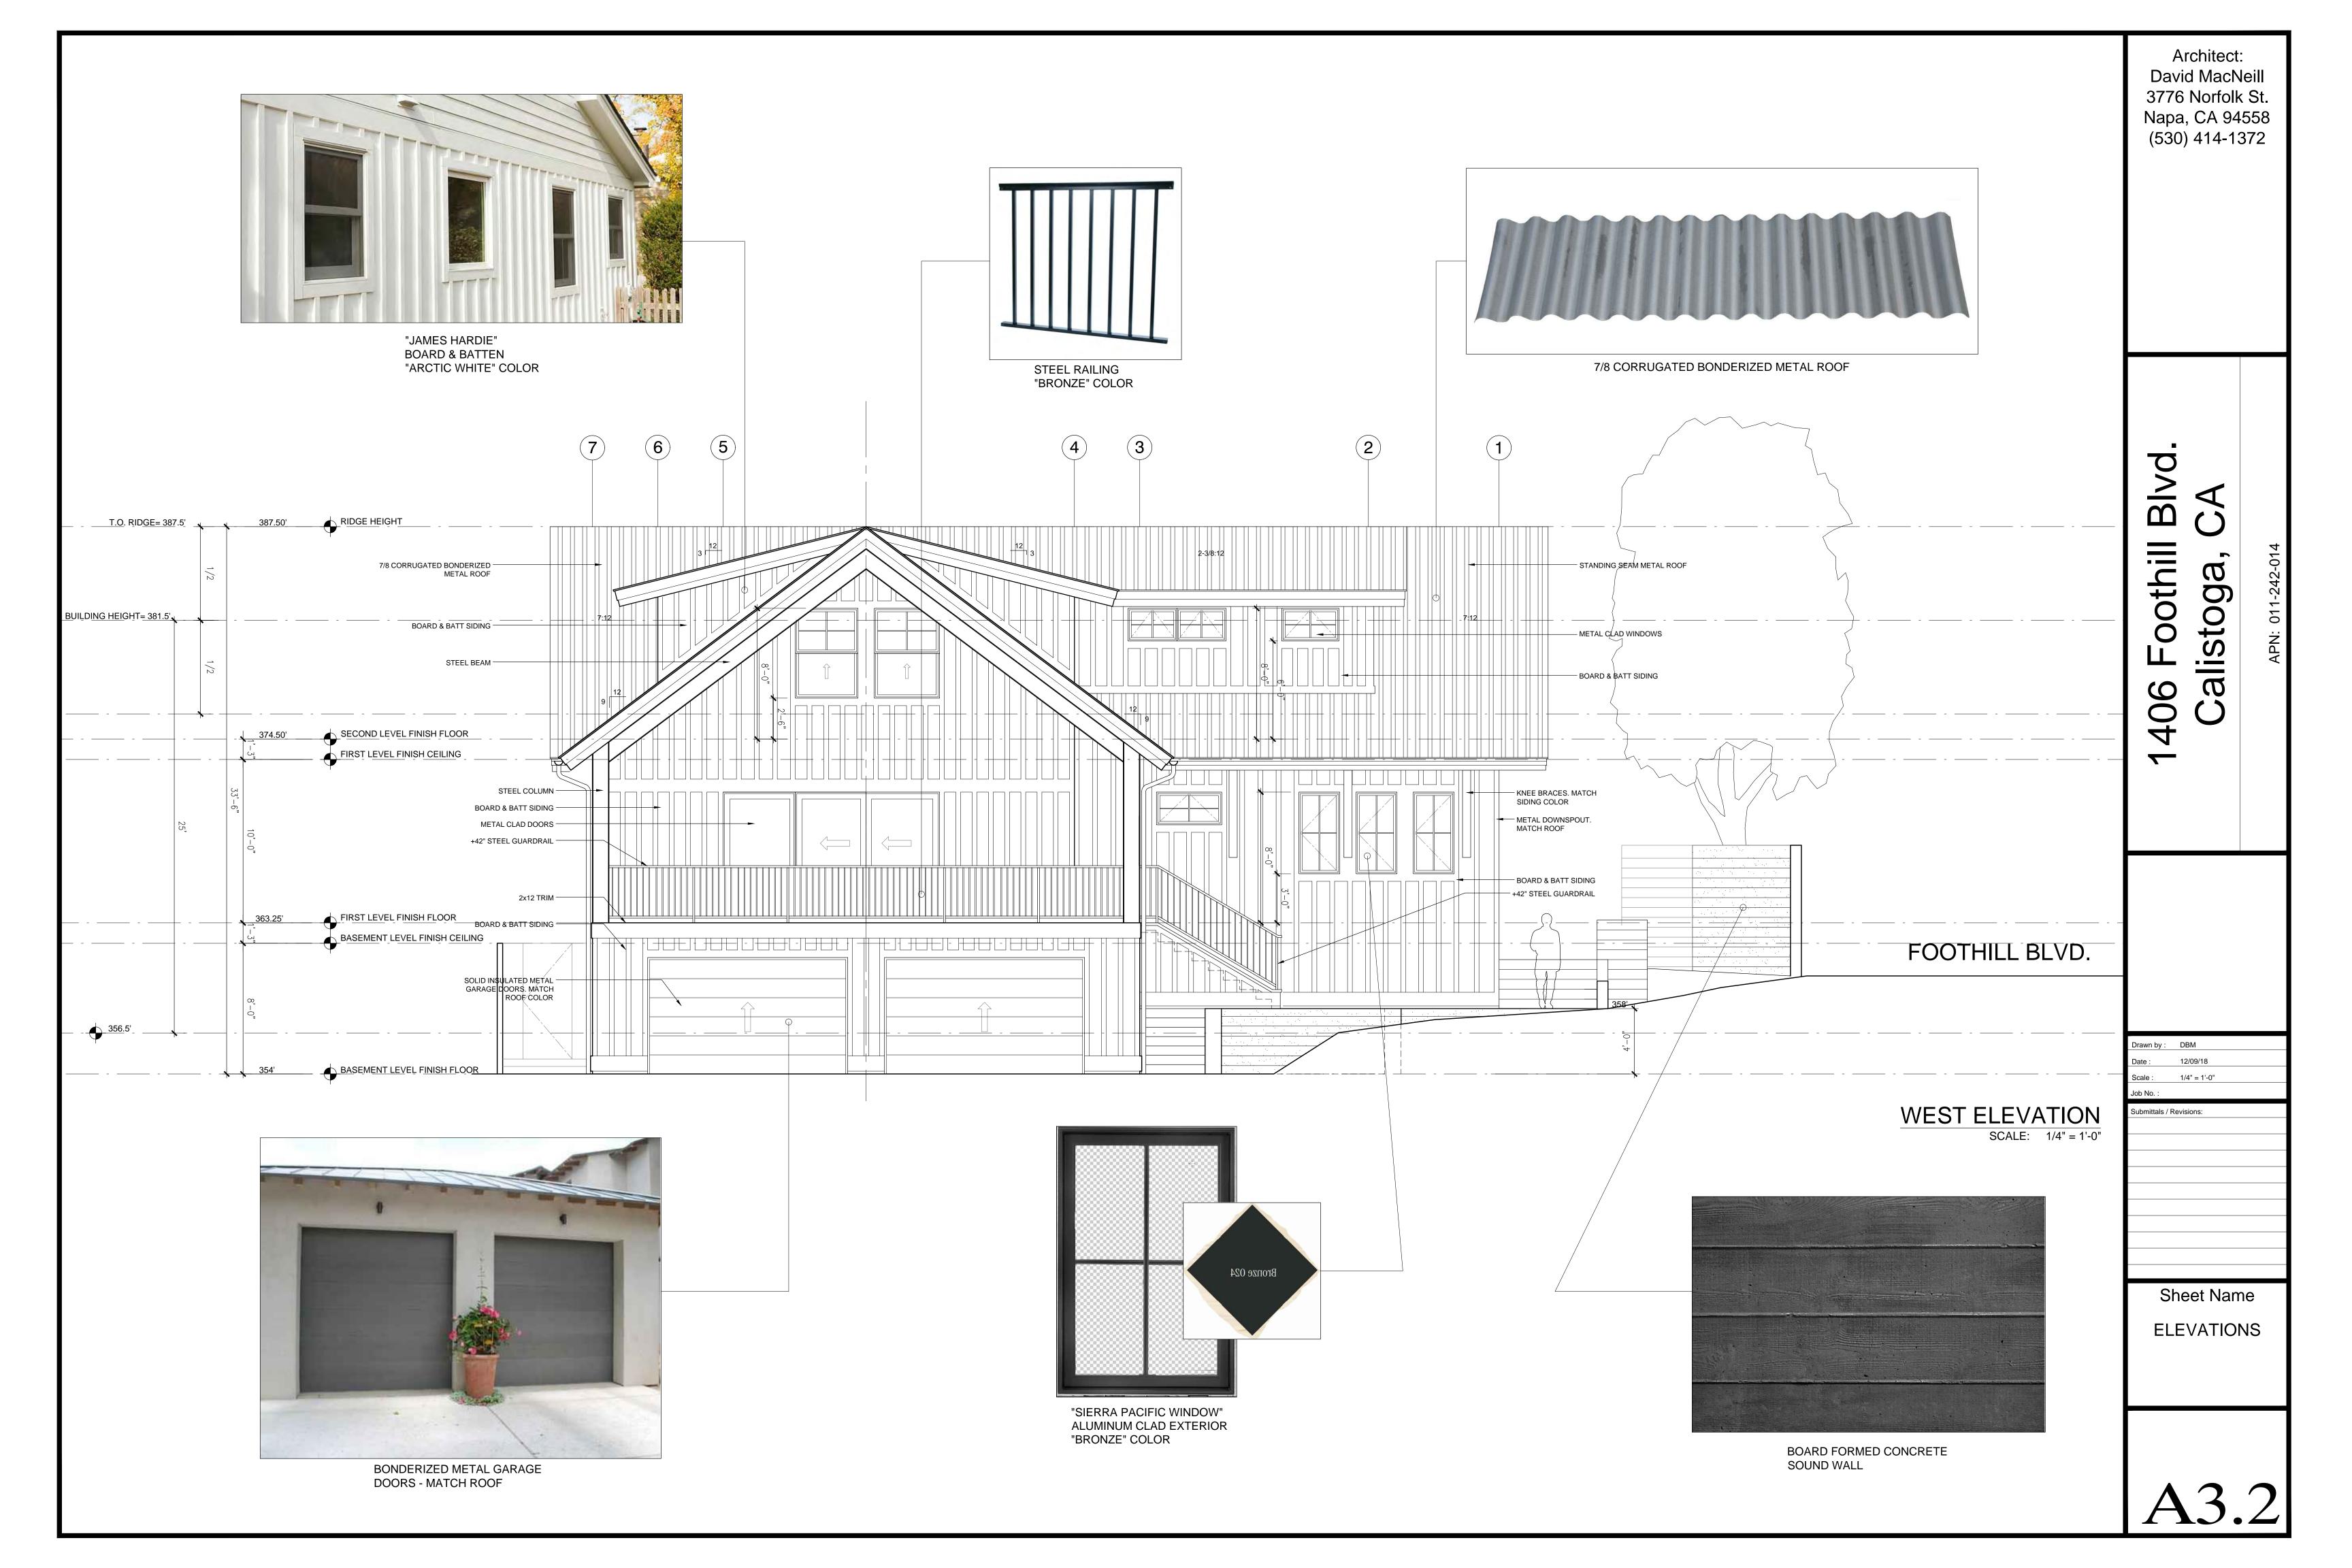

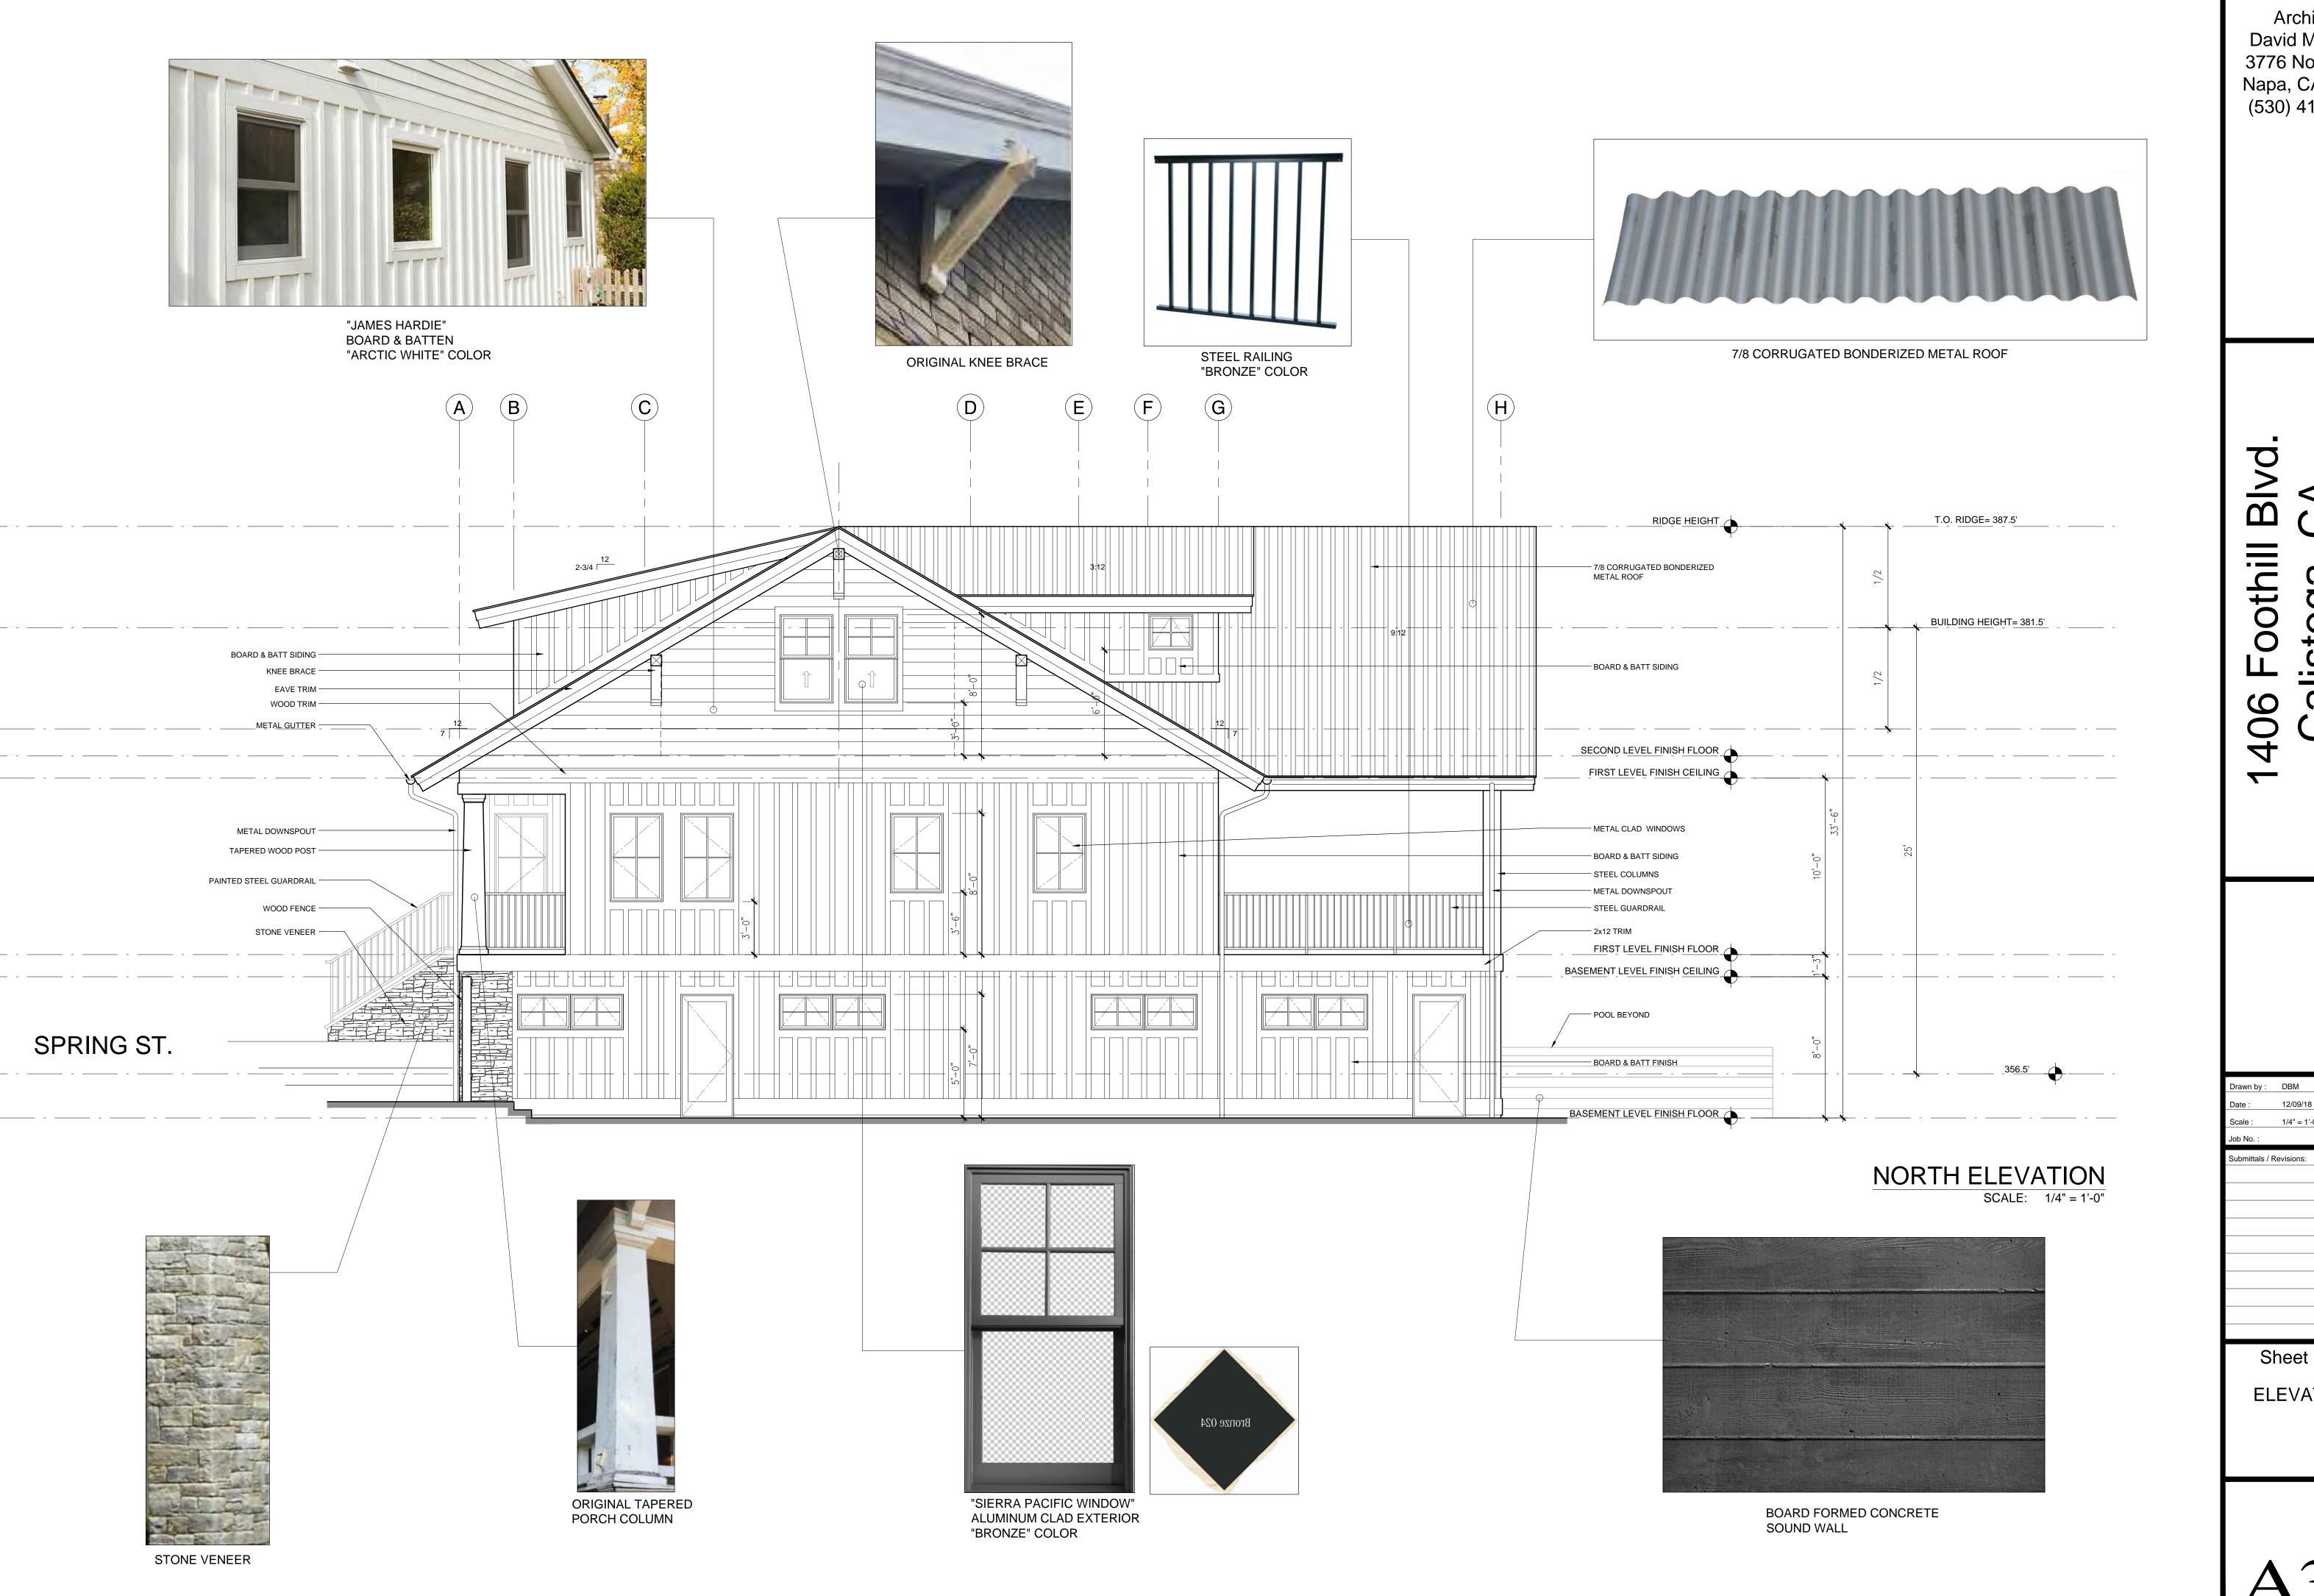


Calistoga

Sheet Name **ELEVATIONS** 




Sheet Name



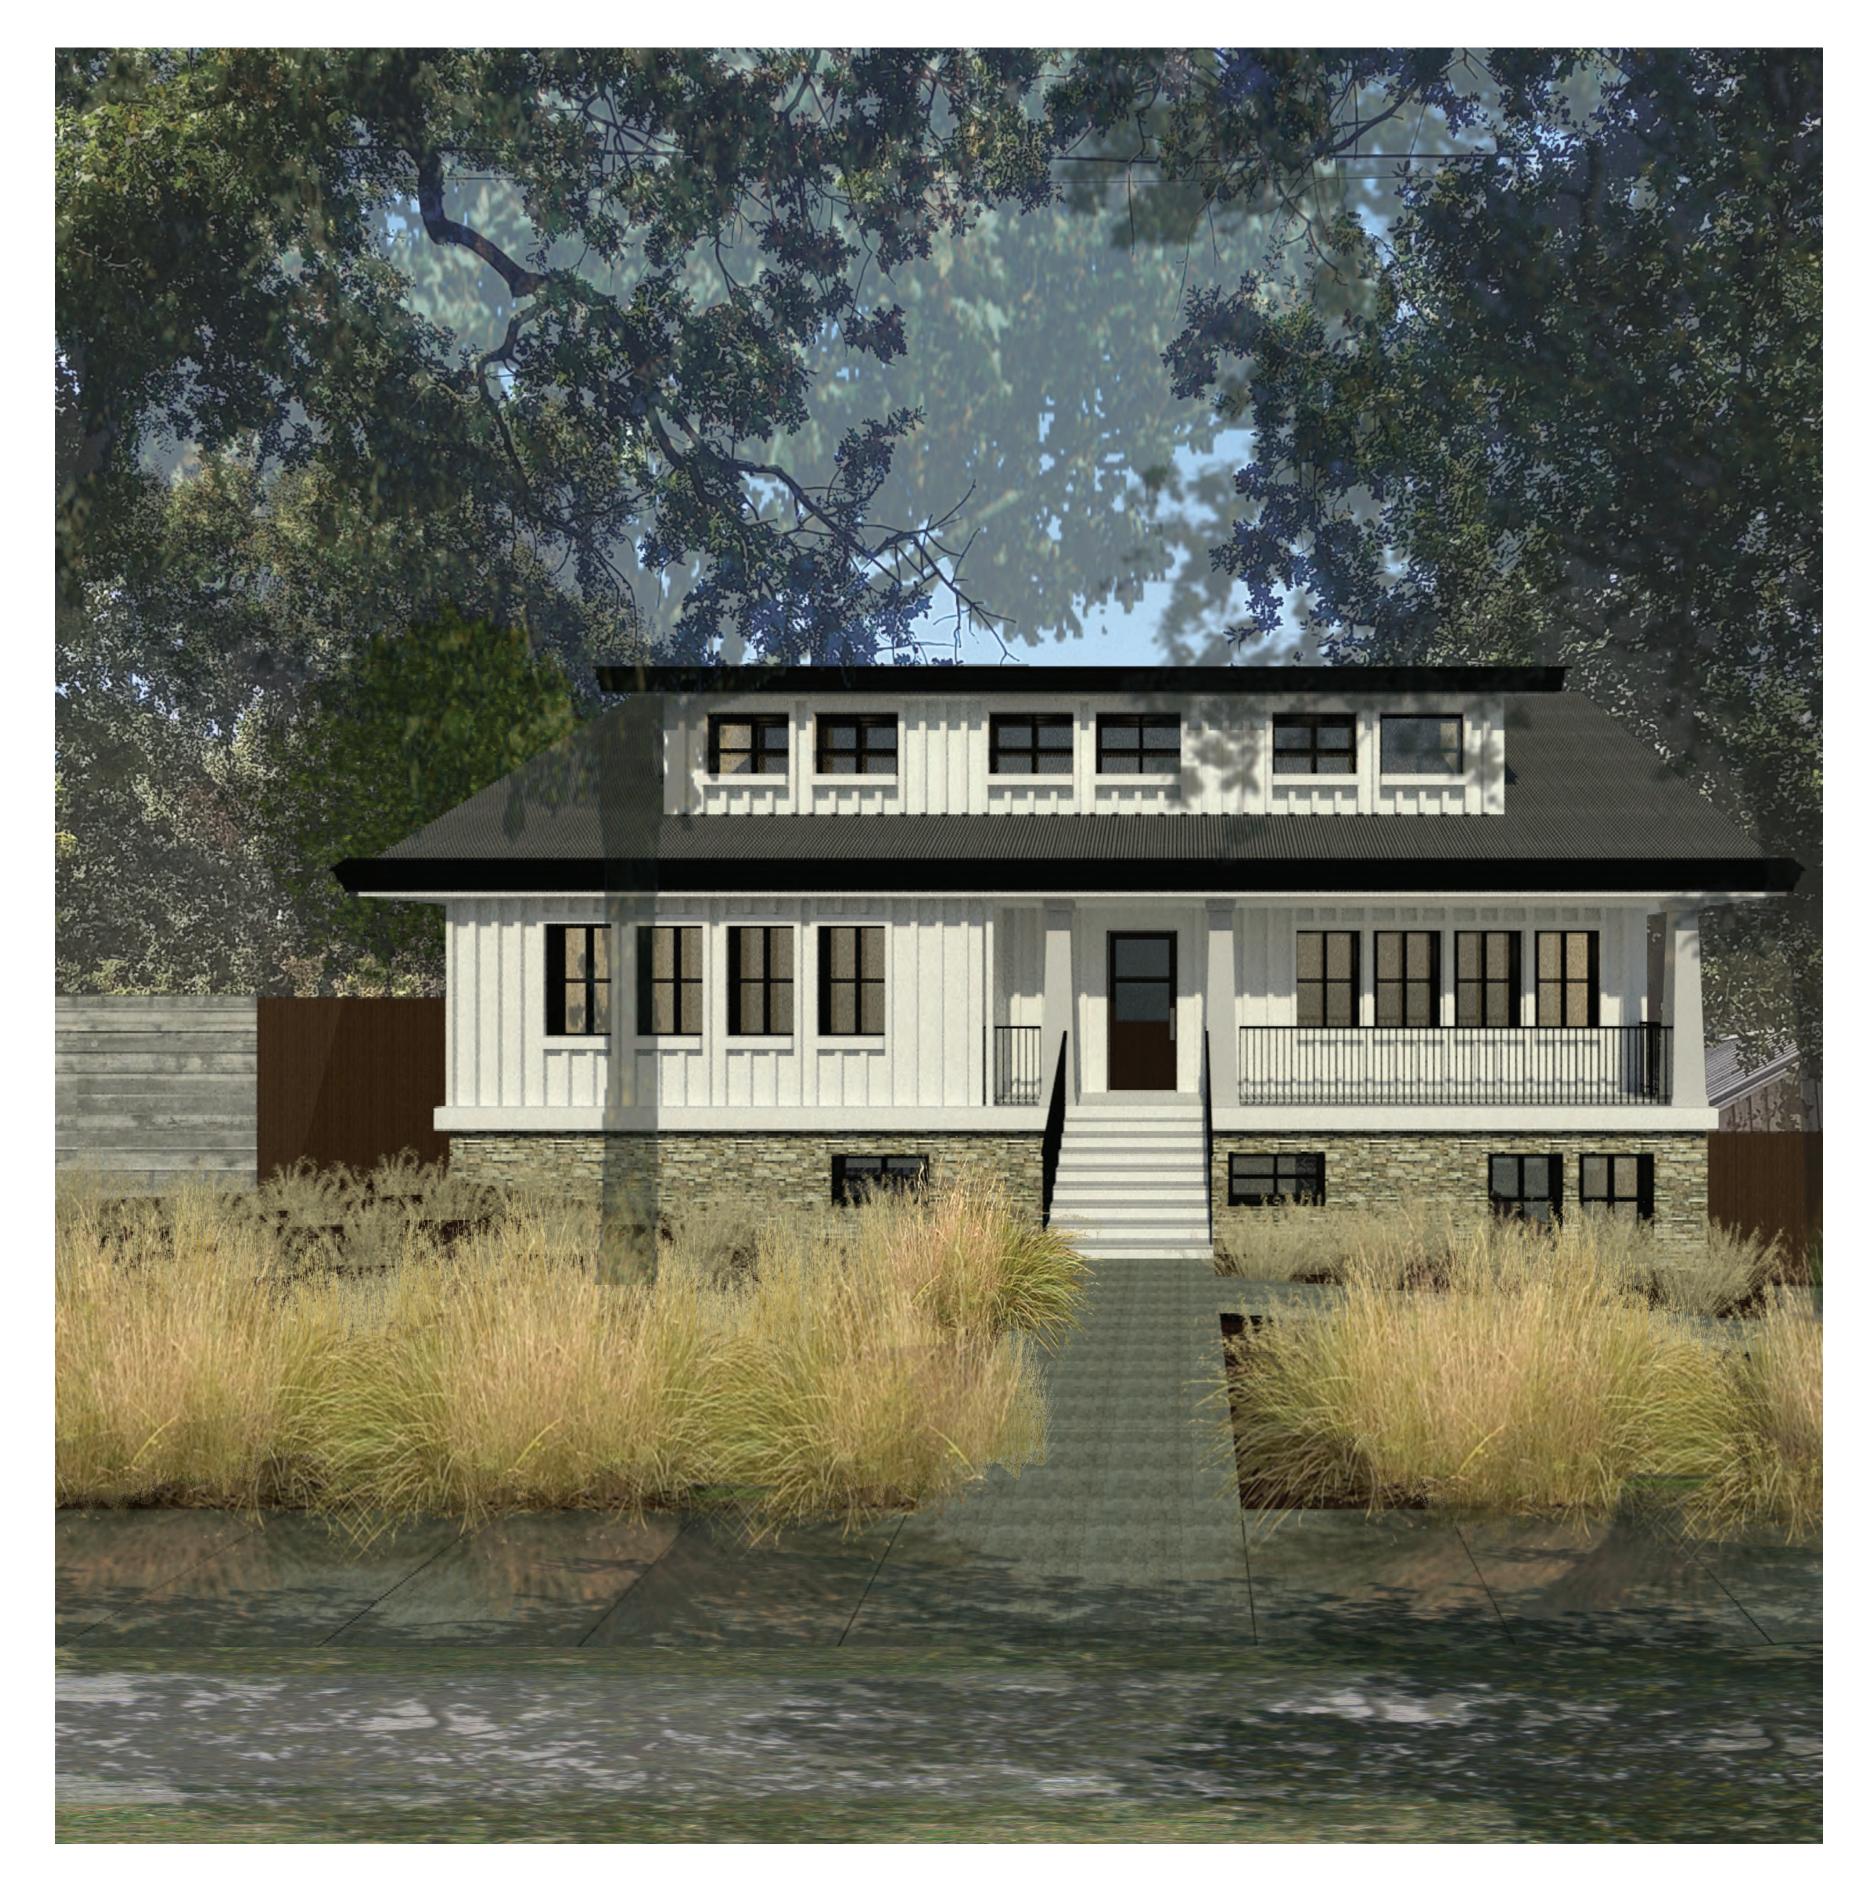

COLOR RENDERING

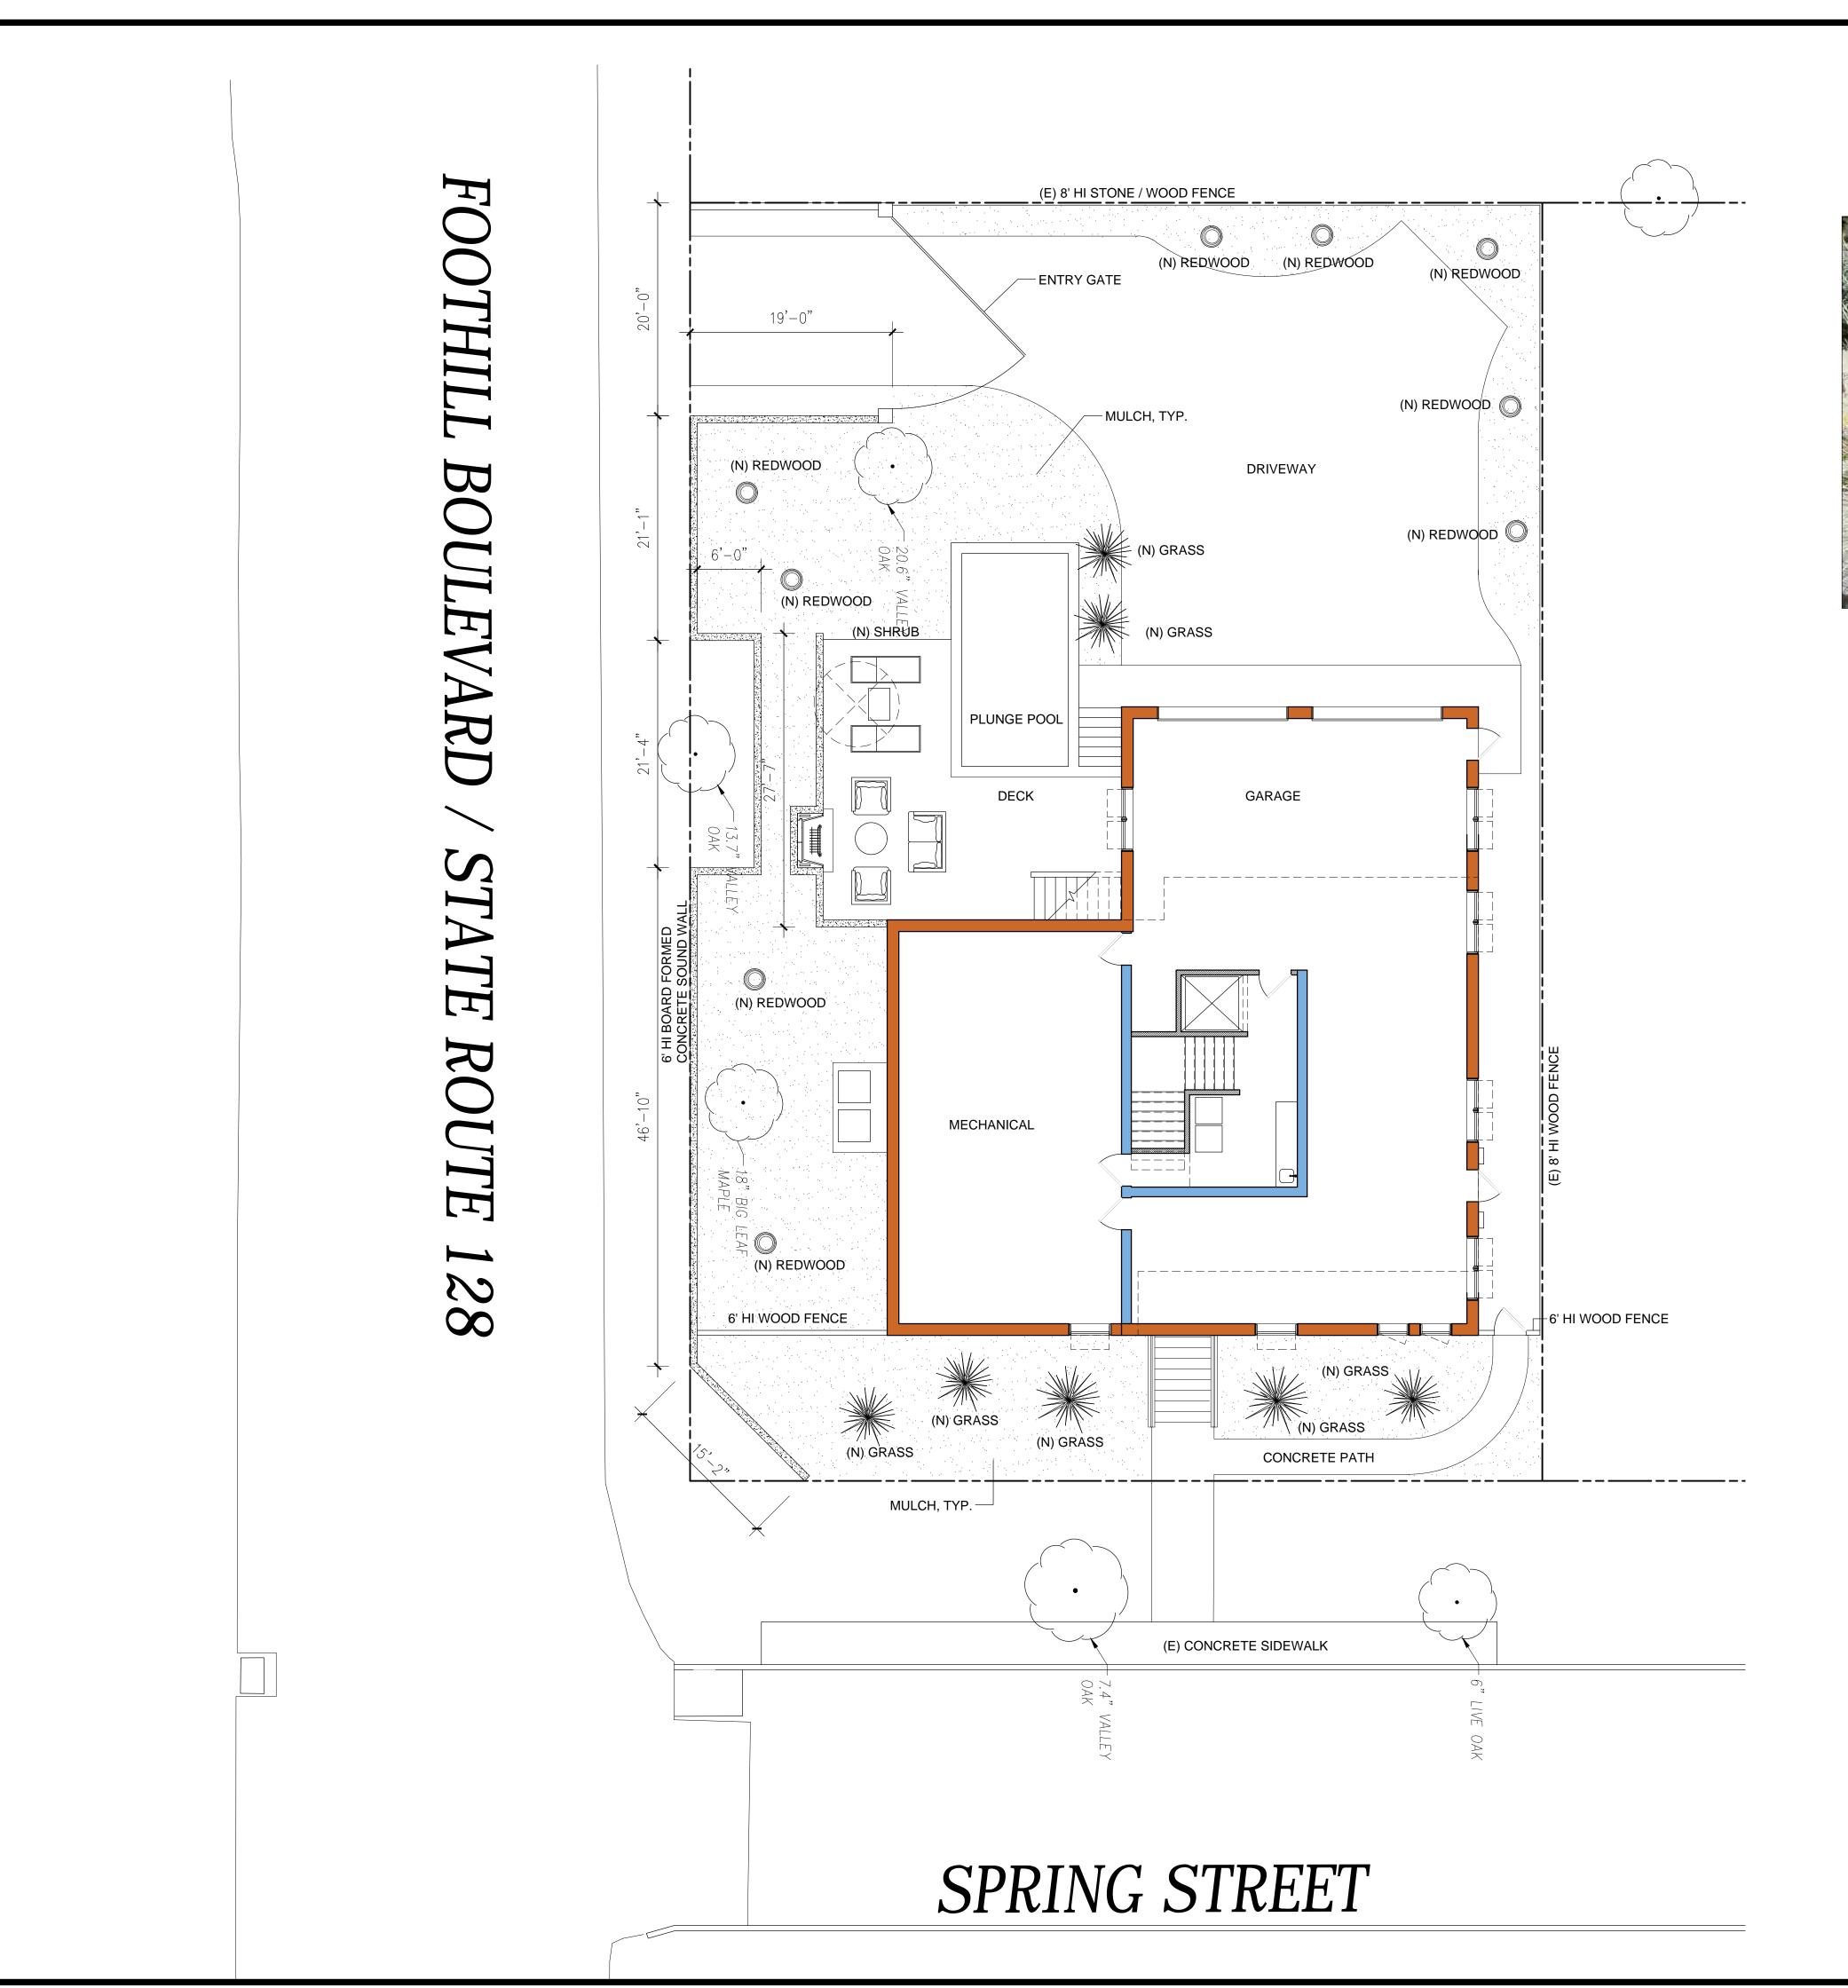



DEER GRASS



REDWOOD

LANDSCAPE / FENCE PLAN


SCALE: 1/8" = 1'-0"

1406 Foothil Calistoga,

rawn by :	DBM
Date :	12/09/18
Scale :	1/8" = 1'-0"
ob No. :	
ubmittals / Re	evisions:

Sheet Name LANDSCAPE

T.1.

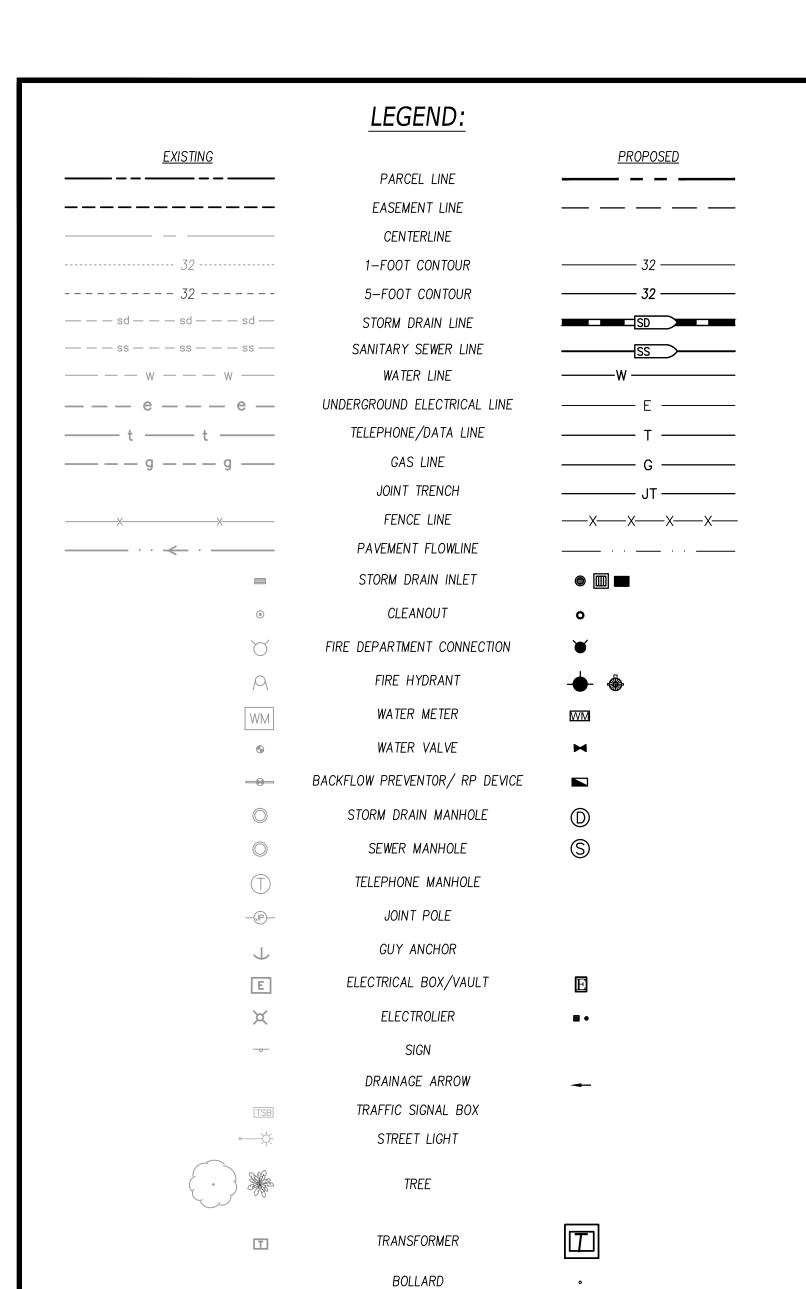


### IMPROVEMENT PLANS FOR PASQUETTI RESIDENCE

APN 011-242-014 1406 FOOTHILL BLVD., CALISTOGA, CA 94515

APN 011-242-008



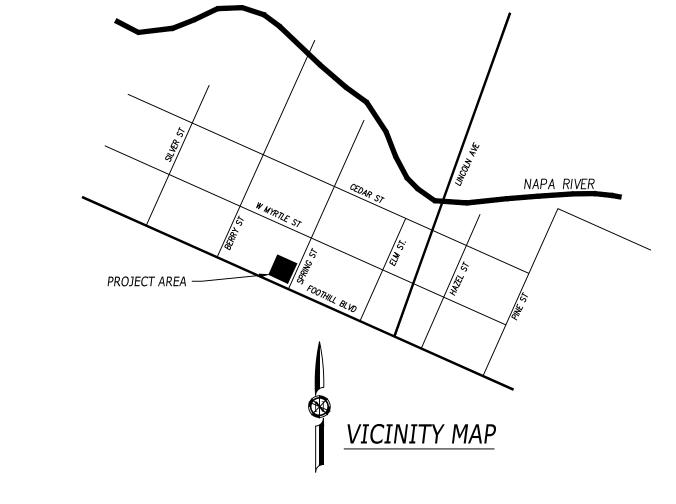

DEVICIONS

	REVISIONS	
MARK	DATE	DESCRIPTION
$\triangle$		
2		
3		
<u> </u>		



PAS BLN 945 SHE COVER

PROJECT#: PASQUETTI


SCALE: SEE SHEET

1/6/2019 APPROVALS DESIGNED BY: DESIGNER CHECKED BY: ENGINEER

SHEET TITLE CIVIL COVER SHEET

SHEET NUMBER

1 of 6

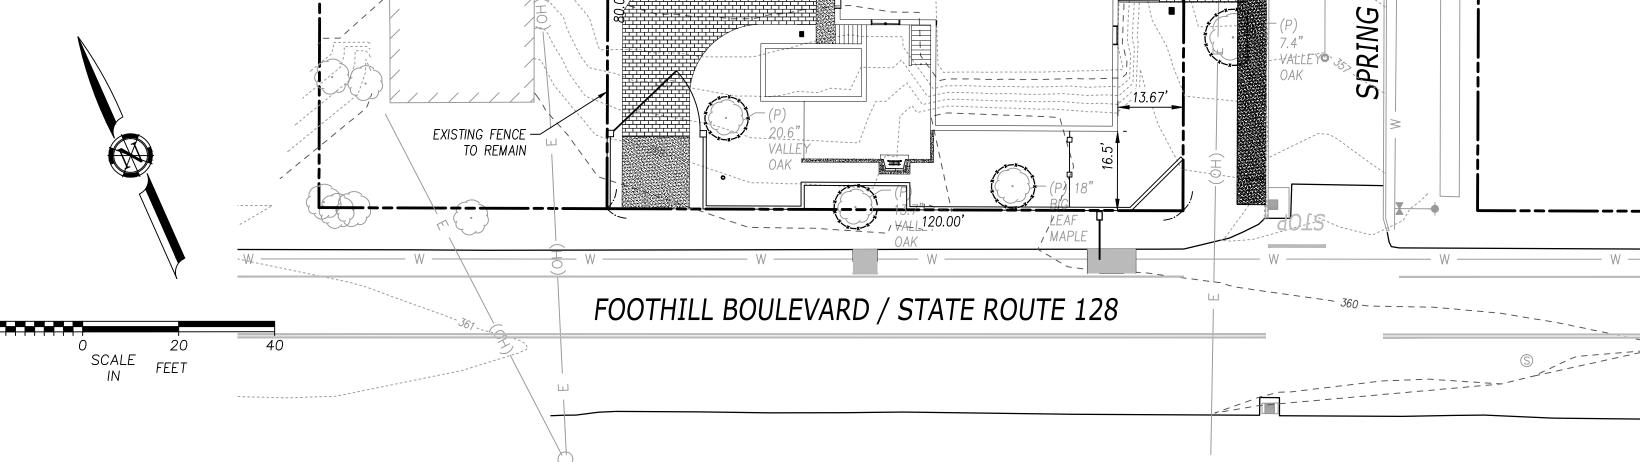

APN 011-242-014

SITE COVERAGE

THEORETICAL WATER USE

#### **ABBREVIATIONS:**

IRON PIPE

_	ANGLE	JP	JOINT POLE
AB	AGGREGATE BASE	L=	LENGTH
AC	ASPHALT CONCRETE	LF	LINEAR FEET
AP	ANGLE POINT	LT	LEFT
BC	BEGIN CURVE	LP	LOW POINT
BCR	BEGIN CURB RETURN	ME	MAINTENANCE EASEMENT
BSW	BACK OF SIDEWALK	MH	MANHOLE
C&G	CURB AND GUTTER	MP	MIDPOINT
CG&S	CURB, GUTTER AND SIDEWALK	OC	ON CENTER
Ę	CENTER LINE	ОН	OVERHEAD
СН	CHORD	PB	PULL BOX
CLR	CLEAR	PCC	POINT OF COMPOUND CURVE
CO	CLEANOUT	PI	POINT OF INTERSECTION
CONC	CONCRETE	PL	PROPERTY LINE
CONST	CONSTRUCT	PΡ	POWER POLE
CR	CURB RETURN	PRC	POINT OF REVERSE CURVE
CS	COMBINED SEWER	PS	PLANTER STRIP
CTRL	CONTROL	PT	POINT
CTV	CABLE TV	PUE	PUBLIC UTILITY EASEMENT
DI	DROP INLET	PVMT	PAVEMENT
DOU	DEPARTMENT OF UTILITIES	RP	REDUCED PRESSURE PRINCIPLE
DRWY	DRIVEWAY		BACKFLOW PREVENTION
DWG	DRAWING		ASSEMBLY
EC	END CURVE	R,R=	RADIUS
ECR	END CURB RETURN	RT	RIGHT
EG	EXISTING GRADE	R/W	RIGHT-OF-WAY
EJ	EXPANSION JOINT	S=	SLOPE
EL, ELEV	ELEVATION	SD	STORM DRAIN
EP	EDGE OF PAVEMENT	SDCO	STORM DRAIN CLEANOUT
EX	EXISTING	SDMH	STORM DRAIN MH
FC	FACE OF CURB	SDWK,SW	SIDEWALK
FD, FND	FOUND	SECT	SECTION
FG	FINISHED GROUND	SHT	SHEET
FH	FIRE HYDRANT	SS	SANITARY SEWER
F_	FLOW LINE	SSMH	SANITARY SEWER MH
FM	FORCE MAIN	STA	STATION
G	GAS	T	TELEPHONE
GB	GRADE BREAK	TC	TOP OF CURB
GFL	GUTTER FLOW LINE	TCE	TEMPORARY CONSTRUCTION
GR	GRATE		ENTRANCE
GV	GATE VALVE	TYP	TYPICAL
HP	HIGH POINT	W,WTR	WATER
HR	HANDICAP RAMP	WV	WATER VALVE
INV	INVERT	ΧW	CROSSWALK

CROSSWALK

#### DDOJECT INCODMATION

PROJECT INFORMATION		
PROPERTY OWNER	JASON AND JENNIFER PASQUETTI — 3032 THUNDER VALLEY COURT, SUITE 200, LINCOLN, CA 95648	
SITE ADDRESS	1406 FOOTHILL BLVD., CALISTOGA, CA 94515	
ZONING	RESIDENTIAL / PROFESSIONAL OFFICE (R-3)	
DOMESTIC & IRRIGATION WATER SOURCE	CITY OF CALISTOGA	
FIRE PROTECTION WATER SOURCE	CITY OF CALISTOGA	
WASTEWATER DISPOSAL	CITY OF CALISTOGA	
PARCEL NOTES		
APN	011-242-014  ACCORDING TO THE FEDERAL EMERGENCY MANAGEMENT	
FLOOD ZONE	AGENCY (FEMA) FLOOD INSURANCE RATE MAP (FIRM) MAP NUMBER 0655C0229E EFFECTIVE SEPTEMBER 26, 2008, THE PROJECT IS NOT LOCATED WITHIN A SPECIA FLOOD HAZARD DISTRICT	
PARCEL AREA	+/- 0.22 ACRES OR ±9,600 S.F.	

#### CIVIL CHEET INDEV

JASON AND JENNIFER PASQUETTI — 3032 THUNDER	CIVIL SHEET INDEX
VALLEY COURT, SUITE 200, LINCOLN, CA 95648	SHEET # SHEET TITLE
1406 FOOTHILL BLVD., CALISTOGA, CA 94515	CO.O CIVIL COVER SHEET
RESIDENTIAL / PROFESSIONAL OFFICE (R-3)	CO.1 CIVIL GENERAL NOTES SHEET
CITY OF CALISTOGA	C1.0 SITE DEMOLITION / TREE PRESERVATION PLAN
	C2.0 SITE GRADING & STORM WATER CONTROL PLAN
CITY OF CALISTOGA	C3.0 EROSION & SEDIMENT CONTROL PLAN
CITY OF CALISTOGA	C4.0 SITE DETAILS
PARCEL NOTES	ENGINEERS OPINION OF EARTHWORK
011-242-014	
ACCORDING TO THE FEDERAL EMERGENCY MANAGEMENT	CUT 225 CUBIC YARDS
AGENCY (FEMA) FLOOD INSURANCE RATE MAP (FIRM) MAP NUMBER 0655C0229E EFFECTIVE SEPTEMBER 26.	FILL 266 CUBIC YARD
2008, THE PROJECT IS NOT LOCATED WITHIN A SPECIAL	NET 41 CUBIC YARDS (FILL / IMPORT)
FLOOD HAZARD DISTRICT	FINAL EARTHWORK QUANTITIES SHALL BE THE
+/- 0.22 ACRES OR ±9,600 S.F.	RESPONSIBILITY OF THE CONTRACTOR.
HOUSE, POOL & DECK 3,656 SF = 38% SITE COVERAGE	
±382 GPD DOMESTIC; ±200 GPD WASTEWATER	

#### GENERAL NOTES:

- THESE DRAWINGS WERE DEVELOPED EXCLUSIVELY FOR THIS PROJECT AND ARE NOT TO BE REPRODUCED OR USED FOR ANT OTHER PROJECT WITHOUT THE WRITTEN PERMISSION OF LAMB
- ALL MATERIALS AND WORKMANSHIP FOR THE WORK DESCRIBED ON THESE PLANS SHALL CONFORM TO THE LATEST EDITIONS OF THE FOLLOWING STANDARDS AS ADOPTED AND AMENDED BY
  - CITY OF CALISTOGA: 2.1. CALIFORNIA BUILDING CODE (2016)
  - 2.2. CALIFORNIA ELECTRIC CODE (2016)
  - 2.3. CALIFORNIA PLUMBING CODE (2016)
  - 2.4. CALIFORNIA I\*IECHANICAL CODE (2016)

  - CALIFORMIA FIRE CODE (2016)
  - CALIFORNIA DEPARTMENT OF TRANSPORTATION (2015)
  - 2.7. CITY OF SANTA ROSA STREET DESIGN & CONSTRUCTION STANDARDS
  - 2.8. CITY OF SANTA ROSA WATER STANDARDS
  - 2.9. CITY OF SANTA ROSA SEWER STANDARDS
- CONTRACTOR SHALL BE FULLY RESPONSIBLE FOR BEING FAMILIAR WITH ALL STANDARDS, CODES AND REGULATIONS APPLICABLE TO THIS PROJECT.
- CONTRACTOR SHALL BE APPROPRIATELY LICENSED WITH THE STATE OF CALIFORNIA TO PERFORM THE WORK SHOWN ON THESE PLANS.
- CONTRACTOR SHALL SUPPLY ALL MATERIALS, EQUIPMENT AND LABOR NECESSARY TO CONSTRUCT THE IMPROVEMENTS ILLUSTRATED ON THESE PLANS.
- CONTRACTOR SHALL PROVIDE SUBMITTALS FOR ALL MATERIALS AND PRODUCTS TO BE USED FOR THE SITE IMPROVEMENTS TO LAMB DEVELOPMENT FOR REVIEW AND APPROVAL
- THE IMPROVEMENTS SHOWN ON THESE PLANS REQUIRE INSPECTION BY THE CITY OF CALISTOGA PUBLIC WORKS DEPARTMENT, PLANNING, BUILDING DEPARTMENT AND FIRE DEPARTMENT. CONTRACTOR IS RESPONSIBLE FOR SCHEDULING ALL INSPECTIONS.
- CONTRACTOR SHALL SCHEDULE A PRECONSTRUCTION MEETING WITH LAMB DEVELOPMENT OR PROPERTY OWNER AND CITY OF CALISTOGA AT LEAST ONE WEEK PRIOR TO THE COMMENCEMENT OF CONSTRUCTION TO REVIEW THE PROJECT PLANS AND SPECIFICATIONS AND CITY OF CALISTOGA REQUIREMENTS.
- CONTRACTOR IS RESPONSIBLE FOR SECURING ALL CONSTRUCTION RELATED PERMITS FROM THE GOVERNING AGENCIES AND MAINTAINING A COPY OF THE PERMITS AND THE APPROVED PLANS ON THE JOB SITE AT ALL TIMES.
- ALL WORK DONE WITHIN THE COUNTY RIGHT OF WAY SHALL BE DONE UNDER AN ENCROACHMENT PERMIT ISSUED BY THE CITY OF CALISTOGA PUBLIC WORKS DEPARTMENT. ALL WORK WITHIN FOOTHILL BLVD SHALL REQUIRE A CALTRANS ENCROACHMENT PERMIT AS DEEMED NECESSARY.
- CONTRACTOR SHALL CONTACT THE CITY OF CALISTOGA PUBLIC WORKS, FIRE AND POLICE DEPARTP'IENTS TO PROVIDE EMERGENCY TELEPHONE NUMBERS AND KEEP THE DEPARTMENTS INFORMED DAILY OF ANY STREETS THAT ARE UNDER CONSTRUCTION AND DETOURS. DETOURS ARE NOT PERMITTED UNLESS APPROVED IN ADVANCE IN WRITING BY THE CITY OF CALISTOGA PUBLIC WORKS DEPARTMENT.
- CONTRACTOR IS SOLELY RESPONSIBLE FOR JOB SITE CONDITIONS AND THE SAFETY OF PROPERTY AND PEOPLE ON THE JOB SITE AT ALL TIMES.
- CONTRACTOR SHALL MAINTAIN THE JOB SITE IN A SAFE CONDITION, IN ACCORDANCE WITH FEDERAL, STATE AND LOCAL REQUIREMENTS, AT ALL TIMES, INCLUDING OUTSIDE OF NORMAL WORKING HOURS. CONTRACTOR SHALL DEFEND, INDEMNIFY AND HOLD THE OWNER AND ENGINEER HARMLESS FROM ALL LIABILITY, REAL OR ALLEGED, IN CONNECTION WITH THE PERFORMANCE OF WORK ON THE PROJECT, EXCEPT LIABILITY ARISING FROM THE SOLE NEGLIGENCE OF THE OWNER OR THE ENGINEER.
- CONTRACTOR SHALL PROVIDE AND MAINTAIN BARRICADES TO PROVIDE FOR THE SAFETY OF THE GENERAL PUBLIC TO THE SATISFACTION OF CITY OF CALISTOGA AND THE OWNER.
- ALL DIMENSIONS SHOWN ON THESE PLANS SHOW MEASUREMENTS IN A HORIZONTAL PLANE UNLESS OTHERWISE SPECIFIED.
- ALL WRITTEN DIMENSIONS SUPERCEDE ANY SCALED DIMENSIONS. IF AN APPARENT DISCREPANCY IS IDENTIFIED CONTACT LAMB DEVELOPMENT IMMEDIATELY FOR A WRITTEN CLARIFICATION.
- IF ANY CONTRACTOR, SUBCONTRACTOR, OR SURVEYOR IDENTIFIES ANY OMISSIONS, DEFICIENCIES, CONFLICTS OR ERRORS IN THESE PLANS AND SPECIFICATIONS OR IF THERE IS ANY DOUBT AS TO THEIR MEANING OR INTENT, THEY SHALL CONTACT LAMB DEVELOPMENT FOR A WRITTEN ADDENDUM OR CLARIFICATION. CONTRACTOR IS NOT ELIGIBLE FOR ADDITIONAL COMPENSATION IF THEY FAIL TO DO SO BEFORE PROVIDING A PROPOSAL.
- CONTRACTOR IS TO PROTECT ALL EXISTING SITE IMPROVEMENTS, UTILITIES, BUILDINGS AND NATURAL FEATURES FROM DAMAGE THROUGHOUT THE DURATION OF CONSTRUCTION. ANY DAMAGE CAUSED BY CONTRACTOR SHALL BE REPAIRED AT CONTRACTOR'S EXPENSE.
- ALL WORK IS TO CEASE IF ARCHEOLOGICAL CULTURAL OR HISTORICAL RESOURCES ARE DISCOVERED DURING CONSTRUCTION. IF SUCH RESOURCES ARE DISCOVERED, THE CITY OF CALISTOGA PLANNING AND BUILDING DEPARTMENT SHALL BE CONTACTED AT (707) 942-2827 AND AN APPROPRIATE COURSE OF ACTION WILL BE DEVELOPED.

#### SURVEY NOTES:

- FADED BACKGROUND REPRESENTS EXISTING TOPOGRAPHIC FEATURES. TOPOGRAPHIC INFORMATION WAS TAKEN FROM THE "MAP OF TOPOGRAPHY OF A PORTION OF THE LANDS OF THE FRANCIS HOUSE" PREPARED BY ALBION SURVEYS, INC., DATED MAY 26, 2016. LAMB DEVELOPMENT ASSUMES NO LIABILITY REGARDING THE ACCURACY OR COMPLETENESS OF THE TOPOGRAPHIC INFORMATION.
- CONTOUR INTERVAL: ONE (1) FOOT, HIGHLIGHTED EVERY FIVE (5) FEET.
- BENCHMARK: VERTICAL DATUM BASED ON CITY OF CALISTOGA BENCHMARK 503-21, ELEVATION 361.80. HORIZONTAL CONTROL IS ASSUMED.
- THE PROPERTY LINES SHOWN ON THESE PLANS DO NOT REPRESENT A BOUNDARY SURVEY. THEY ARE APPROXIMATE AND ARE PROVIDED FOR INFORMATIONAL PURPOSES ONLY.
- 24. CONTRACTOR SHALL PRESERVE ALL EXISTING MONUMENTS THROUGHOUT THE DURATION OF CONSTRUCTION OR HAVE THEM REPLACED AT THEIR OWN EXPENSE BY A LICENSED LAND
- ALL CONSTRUCTION STAKING SHALL BE PERFORMED BY A LICENSED LAND SURVEYOR.

#### **GRADING NOTES:**

- ALL EARTHWORK IS TO CONFORM TO THE REQUIREMENTS OF THE CALIFORNIA BUILDING CODE AND THE CITY OF CALISTOGA PUBLIC WORKS DEPARTMENT STANDARDS.
- ALL CUT AND FILL SLOPES SHALL BE NO STEEPER THAN 2:1 UNLESS OTHERWISE APPROVED BY A GEOTECHNICAL ENGINEER.
- ALL DEBRIS GENERATED DURING DEMOLITION, SITE STRIPPING AND GRADING ACTIVITIES IS TO BE DISPOSED OF PROPERLY OFFSITE BY THE CONTRACTOR.
- CONTRACTOR IS RESPONSIBLE FOR IMPORTING AND / OR EXPORTING MATERIALS AS NECESSARY TO ACHIEVE THE FINISH GRADES ILLUSTRATED ON THESE PLANS.
- CONTRACTOR SHALL CONDUCT ALL GRADING OPERATIONS IN A MANNER THAT PREVENTS WIND BLOWN DIRT AND DUST AND RELATED DAMAGE TO NEIGHBORING PROPERTIES.
- CONTRACTOR SHALL CONFORM TO EXISTING IMPROVEMENTS WITH A SMOOTH TRANSITION TO AVOID ABRUPT CHANGES IN GRADE, LOW SPOTS OR OTHER HAZARDOUS CONDITIONS.
- PROPERTY OWNER SHALL BE RESPONSIBLE FOR MAINTAINING ALL FINISH GRADED SLOPES AFTER THE COMPLETION OF CONSTRUCTION AND REPAIRING ANY EROSION DAMAGE.

#### EXISTING UTILITY NOTES:

- THE EXISTING UTILITY LOCATIONS SHOWN ON THESE PLANS ARE APPROXIMATE AND FOR INFORMATIONAL PURPOSES ONLY. THEY ARE BASED ON INFORMATION PROVIDED BY THE PROPERTY OWNER, THE SURVEYOR AND THE RESPECTIVE UTILITY COMPANIES. LAMB DEVELOPMENT ASSUMES NO LIABILITY REGARDING THE ACCURACY OR THE COMPLETENESS OF THEIR LOCATIONS.
- CONTRACTOR IS RESPONSIBLE FOR VERIFYING EXISTING UTILITY LOCATIONS PRIOR TO ORDERING MATERIALS OR BEGINNING CONSTRUCTION. IF A DISCREPANCY BETWEEN THE PLANNED AND ACTUAL HORIZONTAL OR VERTICAL LOCATION OF AN EXISTING UTILITY EXISTS, CONTACT LAMB DEVELOPMENT FOR AN ALTERNATE DESIGN.
- CONTRACTOR SHALL NOTIFY ALL PUBLIC AND PRIVATE UTILITY COMPANIES TWO WORKING DAYS PRIOR TO THE START OF CONSTRUCTION TO MARK THE LOCATION OF EXISTING UTILITY LINES. CALL UNDERGROUND SERVICE ALERT (USA) AT (800) 227-2600.
- EXISTING UTILITIES ARE TO REMAIN IN SERVICE AT ALL TIMES. CONTRACTOR SHALL PROTECT ALL EXISTING UTILITIES PER THE REQUIREMENTS OF THE UTILITY OWNER.
- CONTRACTOR SHALL COORDINATE ANY REQUIRED UTILITY RELOCATIONS WITH THE UTILITY OWNER.
- EXISTING WATER MAIN MAY BE ASBESTOS CONCRETE PIPE (ACP). CONTRACTOR SHALL COMPLY WITH ALL STATE AND FEDERAL SAFETY REQUIREMENTS FOR WORKING WITH AND DISPOSING OF ACP.

#### **UTILITY NOTES:**

#### WATER PIPING NOTES:

- ALL WATER PIPE 3" IN DIAMETER AND SMALLER IS TO BE SDR 9 (200 PSI MINIMUM). ALL JOINTS AND FITTINGS ARE TO BE SOCKET TYPE SOLVENT WELD.
- ALL WATER PIPE 4" IN DIAMETER AND LARGER IS TO BE C900 CLASS 200 PVC OR DUCTILE IRON PIPE WITH DUCTILE IRON FITTINGS. ALL DUCTILE IRON PIPE AND FITTINGS ARE TO BE 40. WRAPPED IN POLYETHYLENE PER THE MANUFACTURER'S RECOMMENDATIONS.
- CONFIRM FIRE PROTECTION WATER PIPE SIZES WITH FIRE PROTECTION SYSTEM DESIGNER PRIOR TO CONSTRUCTION.

#### STORM DRAIN PIPING NOTES:

- ALL STORM DRAIN PIPE 8" IN DIAMETER AND SMALLER ARE TO BE SDR 35 PVC UNLESS OTHERWISE NOTED.
- ALL STORM DRAIN PIPE 12" IN DIAMETER AND LARGER ARE TO BE SMOOTH WALL HDPE WITH WATER TIGHT JOINTS UNLESS OTHERWISE NOTED.
- ALL 4" DIAMETER STORM DRAIN PIPE IS TO BE INSTALLED WITH MINIMUM SLOPE OF 1% UNLESS OTHERWISE NOTED.
- ALL 6" AND LARGER STORM DRAIN PIPE ARE TO BE INSTALLED WITH A MINIMUM SLOPE OF 0.5% UNLESS OTHERWISE NOTED.
- DOWNSPOUT LOCATIONS ARE APPROXIMATE. VERIFY LOCATION OF CONNECTION POINTS PRIOR TO CONSTRUCTION. ALL DOWN SPOUT LEADERS ARE TO BE 4" SDR 35 PVC UNLESS OTHERWISE
- ALL STORM DRAIN PIPE WITH LESS THAN ONE FOOT OF COVER (FROM TOP OF PIPE TO BOTTOM OF FLEXIBLE PAVEMENT OR TOP OF CONCRETE) IS TO BE BACKFILLED WITH LEAN CONCRETE. SANITARY SEWER PIPING NOTES:
- ALL SANITARY SEWER PIPING IS TO BE SDR 35 PVC UNLESS OTHERWISE NOTED.
- ALL SANITARY SEWER PIPING 6" IN DIAMETER AND SMALLER IS TO BE INSTALLED WITH A MINIMUM SLOPE OF 2%. THE SLOPE OF PIPES 8" AND LARGER MAY BE REDUCED TO 1% MINIMUM.
- COORDINATE CONNECTION TO BUILDING PLUMBING WITH BUILDING CONTRACTOR AND VERIFY ALL INVERTS PRIOR TO CONSTRUCTION.

DEVELOPME 2059 RENPOINT WAY ROSEVILLE, CA 95661 TEL: 916-708-8012 LAMB20@HOTMAIL.COM AMB

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PROJECT#: PASQUETTI

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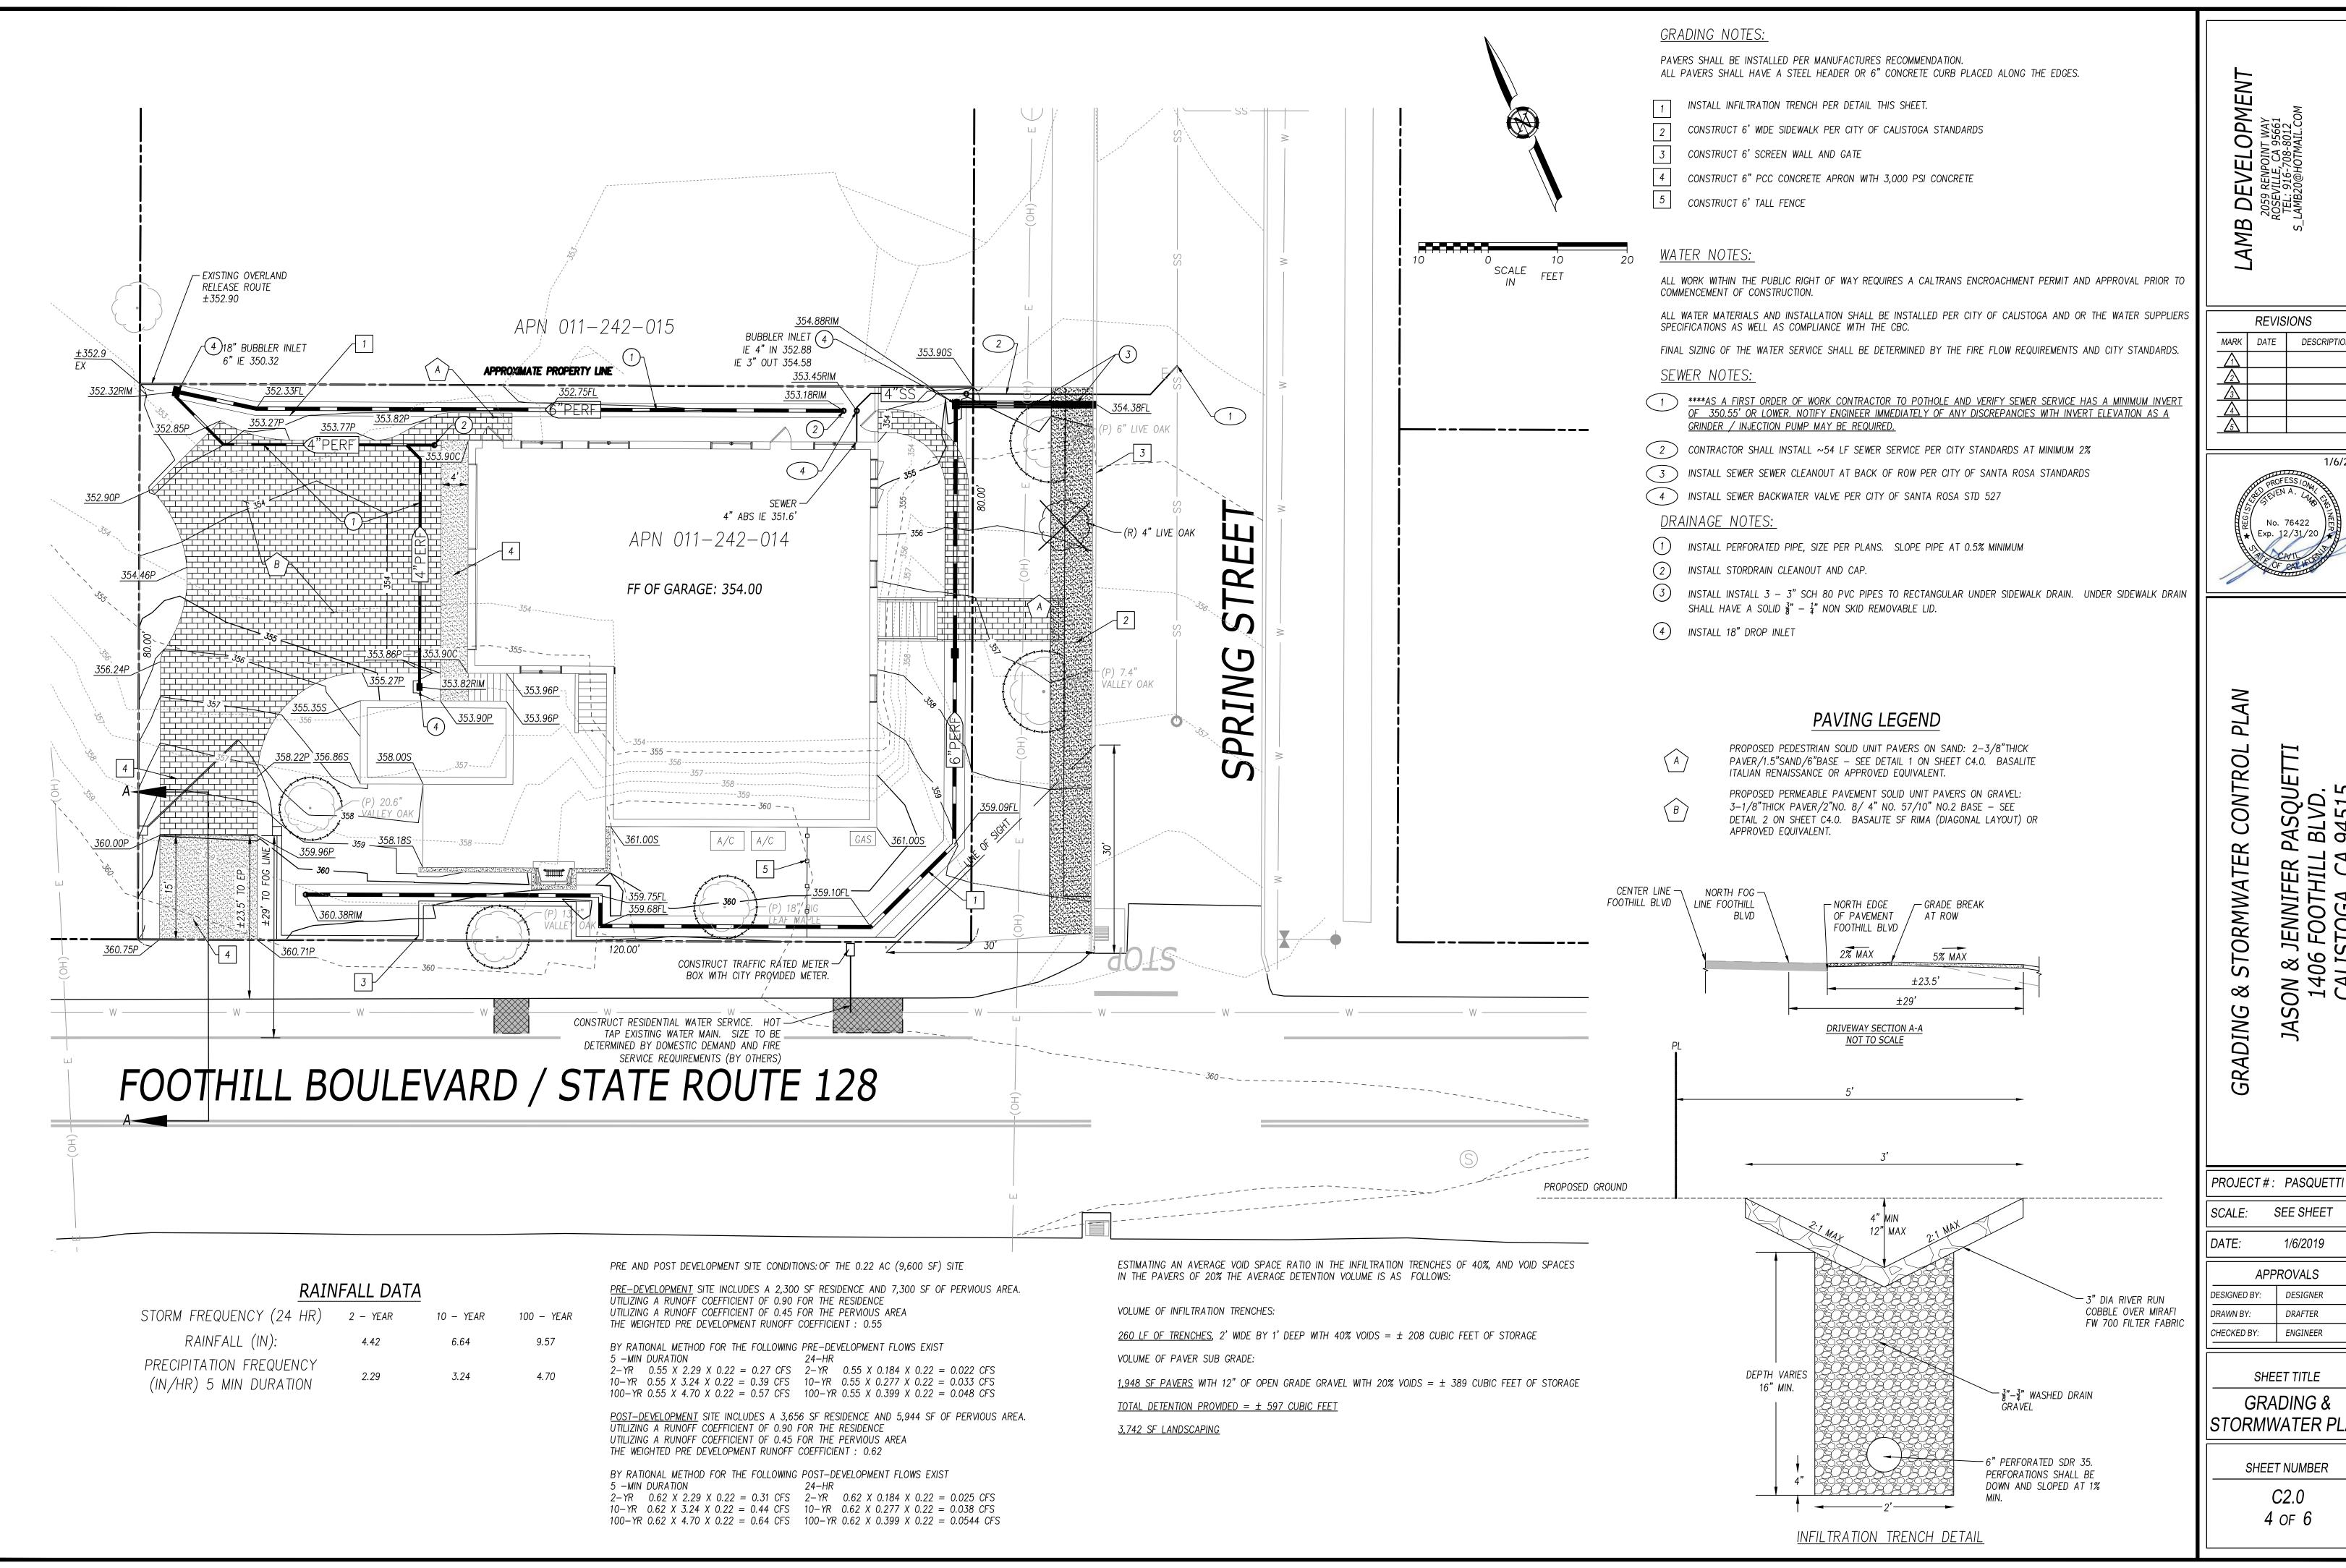
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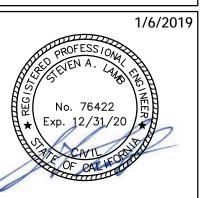
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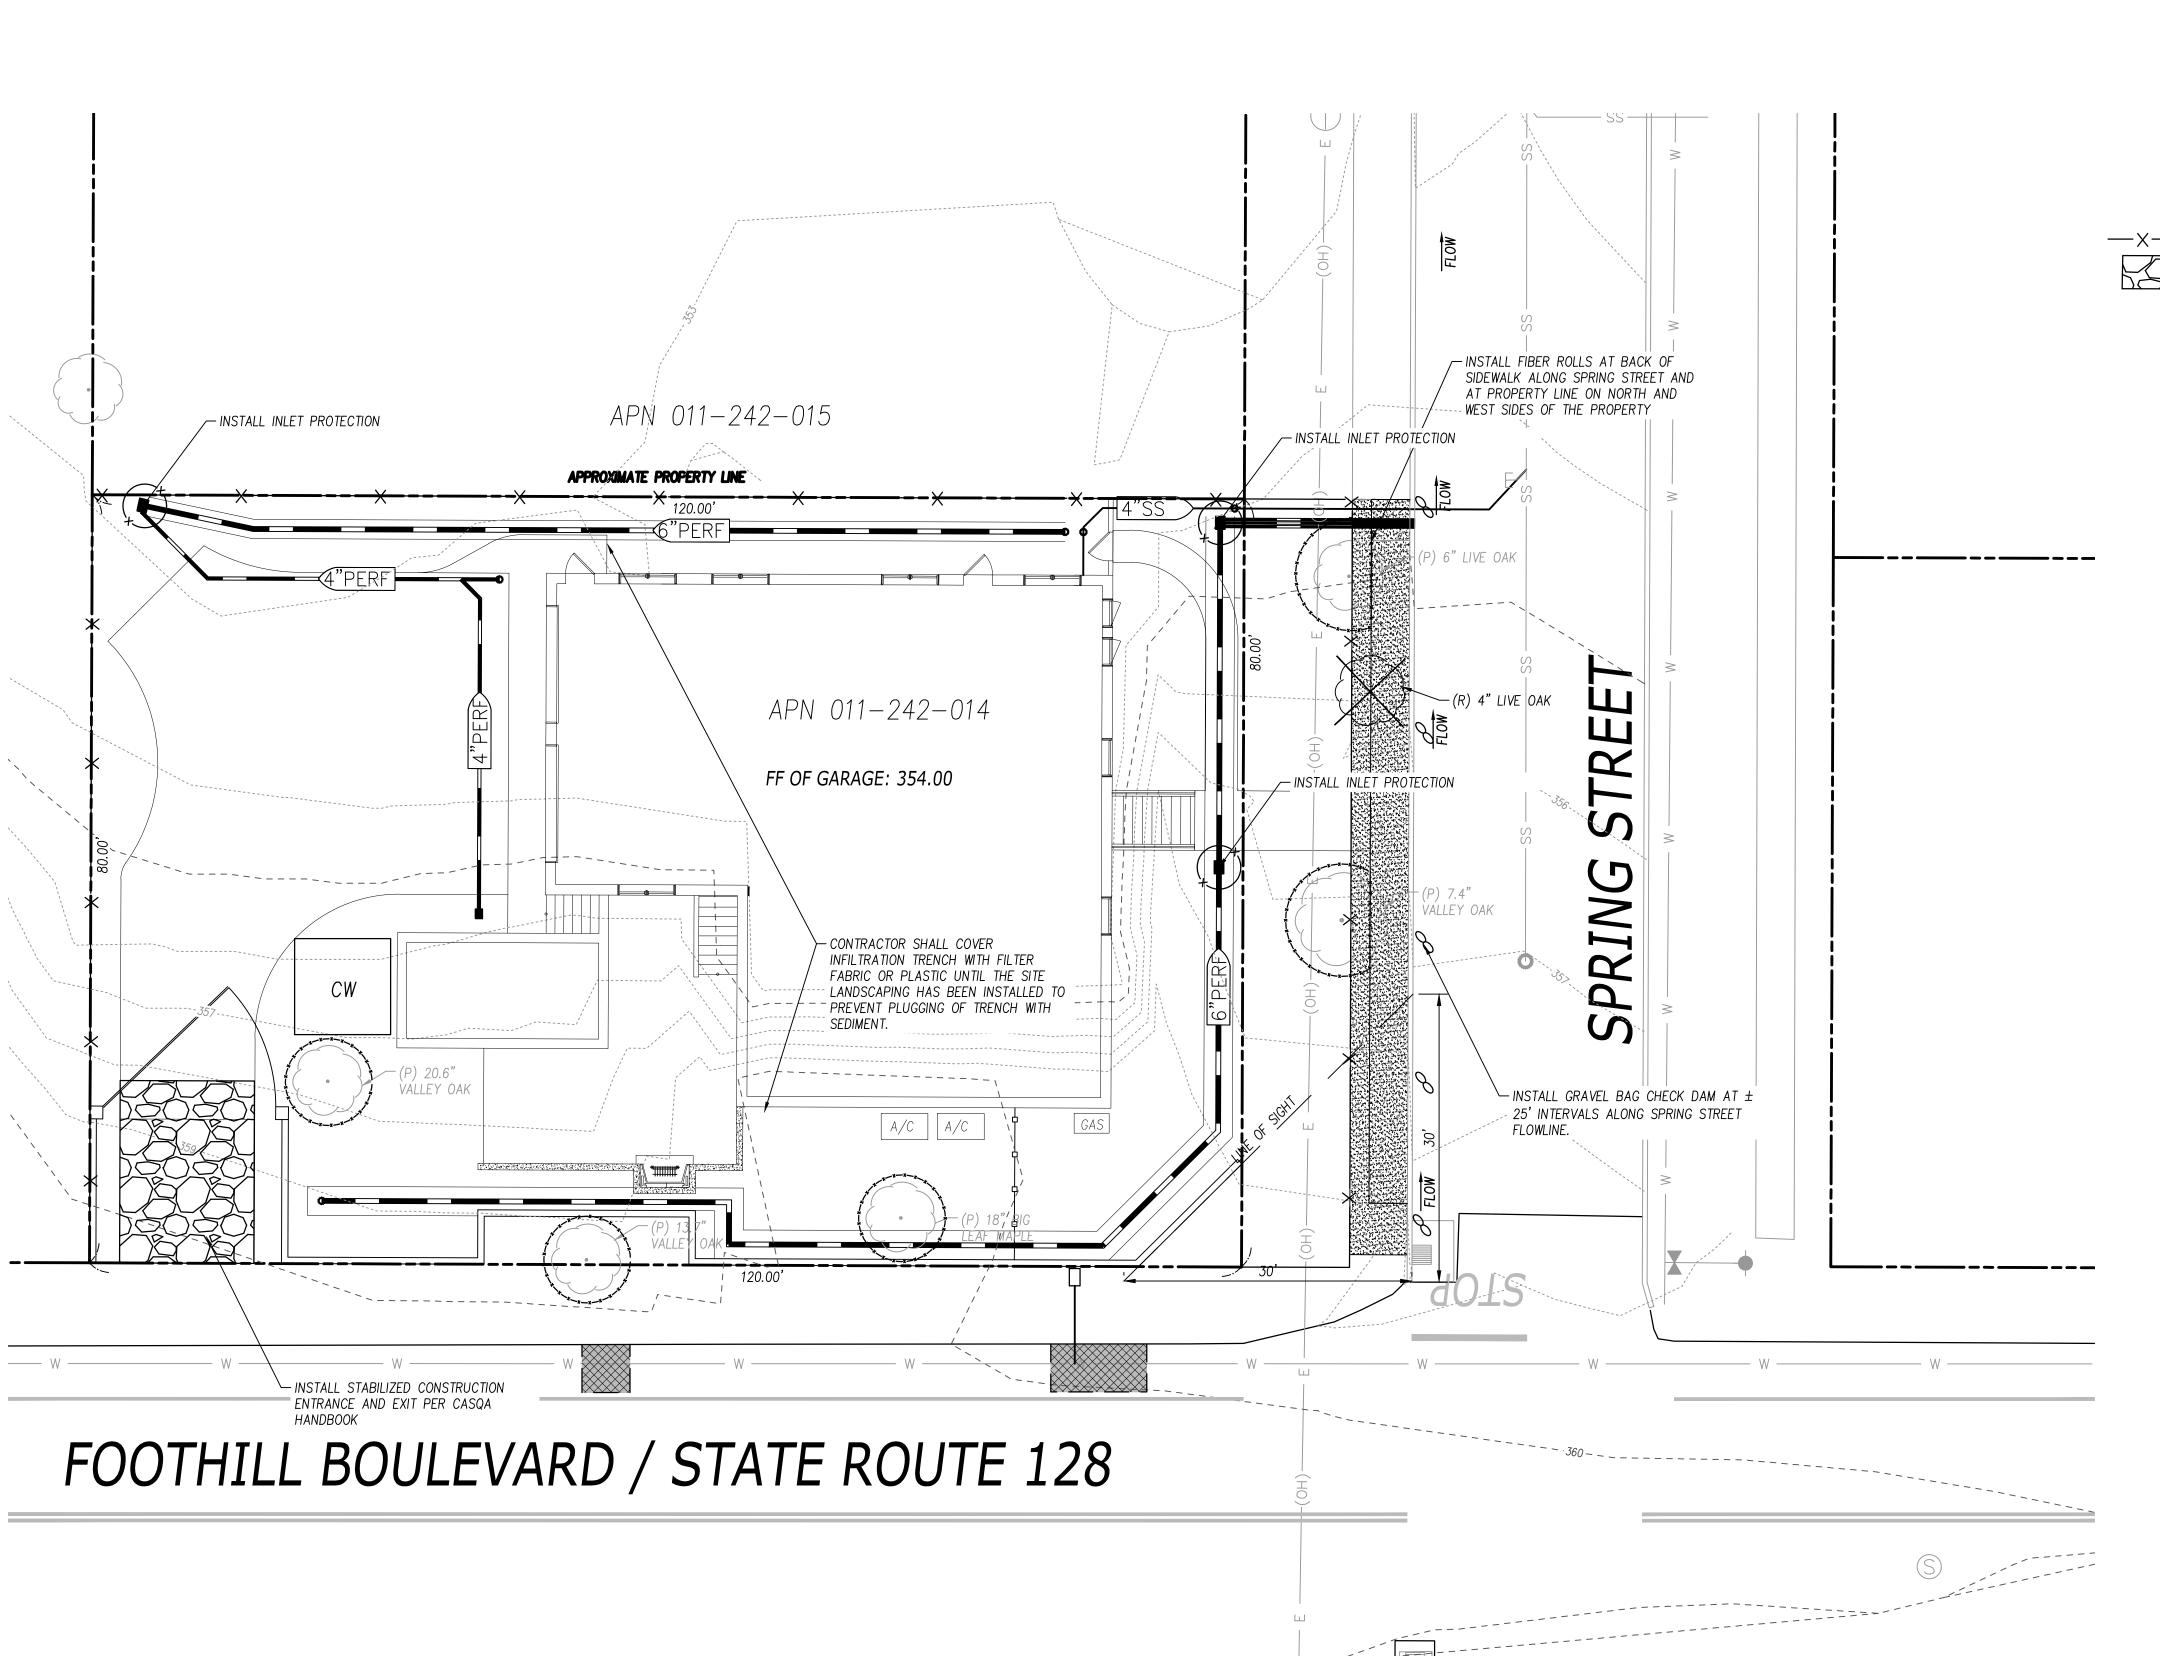
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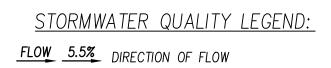
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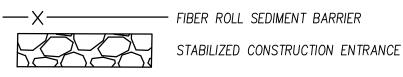
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**GRADING &** STORMWATER PLAN

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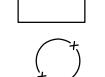








CONCRETE WASHOUT



INLET PROTECTION



GRAVEL BAG CHECK DAM

#### EROSION CONTROL & STORMWATER QUALITY NOTES:

- CONTRACTOR SHALL FOLLOW CITY MS4 GENERAL PERMIT REQUIREMENTS AND COMPLY WITH CITY INSPECTOR DIRECTIVES IF DUST AND / OR EROSION CONTROL
  MEASURES ARE NOT ADEQUATE.
- GROUNDWATER LEVELS AT THIS LOCATION FLUCTUATE AND TRENCHING MAY REQUIRE DEWATERING. ALL DEWATERING OPERATIONS MUST IMPLEMENT APPROPRIATE
  FILTRATION BMPS TO TREAT WATER BEFORE DISCHARGING TO DRAINAGE DITCH.
- 3. CONTRACTOR SHALL IMPLEMENT NAPA COUNTY STANDARD CONSTRUCTION SITE BMPS THROUGHOUT THE DURATION OF CONSTRUCTION.
- ALL TEMPORARY EROSION AND SEDIMENT CONTROL DEVICES (WATER BARS, SILT FENCE & STRAW RATTLES) MUST BE INSTALLED BY OCTOBER 15TH.
- 5. ALL EROSION CONTROL MEASURES MUST BE INSPECTED AND MAINTAINED BT THE CONTRACTOR THROUGHOUT THE RAINY SEASON (OCTOBER 15TH THROUGH APRIL 1ST). INSPECTIONS MUST BE PERFOMED AT LEAST ONCE PER WEEK DURING EXTENDED DRY PERIODS, IMMEDIATELY BEFORE ANTICIPATED RAIN EVENTS, ONCE EVERY 24 HOURS DURING EXTENDED RAIN EVENTS AND IMMEDIATELY FOLLOWING EACH RAIN EVENT.
- ALL DISTURBED AREAS ARE TO BE STABILIZED BY PLANTING OF AN EROSION CONTROL COVER CROP. PRIOR TO APPLYING THE EROSION CONTROL SEED BLEND, THE SEED BED SHOULD BE PREPARED BY UNIFORMLY SCARIFYING THE GROUND SURFACE TO A DEPTH OF TWO TO FOUR INCHES AND CONDITIONING TO BREAK UP LARGE PODS
- 7. THE COVER CROP SEED BLEND SHOULD BE BROADCAST OR DRILLED AFTER THE SEED BED HAS BEEN PREPARED.
- THE COVER CROP SEED MIX SHOULD BE APPLIED AT THE FOLLOWING RATE
- 2. ZORRO FESCUE 10 LB/ACRI
- 3. CRIMSON CLOVER 5 LB / ACRE 4. ROSE CLOVER - 8 LB/ACRE
- 9. ALL SEEDED AREAS ARE TO BE FERTILIZED TO PROMOTE SUCCESSFUL ESTABLISHMENT OF THE COVER CROP. THE RECOMMENDED FERTILIZER IS AMMONIUM PHOSPHATE (16-20-0) APPLIED AT A RATE OF 250 POUNDS PER ACRE.
- 10. AFTER THE SEED AND FERTILIZER HAVE BEEN PLACED THE SEEDED AREA SHOULD BE RAKED, DRAGGED OR HARROWED TO ENSURE THAT SEEDS ARE PROPERLY BEDDED.
- 11. ALL DISTURBED AREAS ARE TO BE MULCHED WITH STRAW AT A RATE OF 3,000 POUNDS PER ACRE TO PROTECT THE BARE SOILS WHILE THE COVER CROP IS GETTING ESTABLISHED.
- 12. STRAW SHOULD BE SPREAD BY HAND IN A MANNER THAT PROMOTES FORMATION OF AN INTERWOVEN MATRIX. CRIMPING STRAW INTO THE SOIL IS HIGHLY RECOMMENDED ON ESPECIALLY WINDY SITES AND IS MANDATORY ON SITES WHERE STRAW IS MECHANICALLY CHOPPED AND BLOWN INTO PLACE.
- 13. ALL SOIL CUT AND FILL SLOPES THAT ARE STEEPER THAN 4:1 (HORIZONTAL TO VERTICAL) AND ALL DRAINAGE SWALES MUST BE COVERED WITH NORTH AMERICAN GREEN CI25BN EROSION CONTROL BLANKET AFTER THE EROSION CONTROL SEED AND FERTILIZER HAVE BEEN PLACED.
- 14. CONTRACTOR MUST MAINTAIN AN ADEQUATE SUPPLY OF EROSION CONTROL MATERIALS ONSITE TO FACILITATE MAINTENANCE AND REPAIR THROUGHOUT THE RAINY SEASON.
  TYPICAL MATERIALS THAT SHOULD BE KEPT ONSITE INCLUDE STRAW WATTLE SEDIMENT BARRIERS, GRAVEL BAGS, EROSION CONTROL BLANKETS, STRAW AND EROSION CONTROL
  SEED MIX.
- 15. ALL SEEDED AREAS MUST BE INSPECTED FOR FAILURES DURING THE RAINY SEASON AND REPAIRED IMMEDIATELY BY TEMPORARY MULCHING OR OTHER REVEGETATION PRACTICES.
- AREAS EXPOSED TO EXCESSIVE WIND AND VEHICLE TRAFFIC SHOULD. BE INSPECTED DAILY FOR DUST CONTROL. SPRINKLE THE EXPOSED AREA WITH WATER OR APPLY STABILIZERS AT APPROPRIATE INTERVALS BASED ON NEED. DO NOT SPRINKLE EXCESSIVELY AND CAUSE NON—STORMWATER DISCHARGE FROM THE SITE.
- INSPECT ALL SEDIMENT BARRIERS, INLET PROTECTION DEVICES AND OTHER STORMWATER QUALITY BEST MANAGEMENT PRACTICES BEFORE AND AFTER RAIN EVENTS AND WEEKLY THROUGHOUT THE RAINY SEASON. DURING EXTENDED RAINFALL EVENTS, INSPECT INLET PROTECTION DEVICES AT LEAST ONCE EVERY 24 HC PROPERLY DISPOSE OF ACCUMULATED SEDIMENT. APPROPRIATELY STABILIZE ALL BARE AREAS AROUND THE INLET.
- WASTE COLLECTION AREAS SHALL BE LOCATED AWAY FROM WATERCOURSES AND STORMWATER CONVEYANCE SYSTEMS.
- 9. DUMPSTERS SHALL BE SECURELY COVERED AT NICHT AND DURING WET WEATHER DUMPSTERS SHALL BE INSPECTED FREQUENTLY FOR LEAKS. ANY LEAKING MATERIAL FROM DUMPSTER SHALL BE CONTRACTOR SHALL ARRANGE FOR ADEQUATE DEBRIS DISPOSAL SHALL SHALL BE TO BE TO THE DEBRIS DISPOSAL SHALL BE TO THE DEBRIS
- 20. CONTRACTOR SHALL BE RESPONSIBLE FOR CLEANING AND SWEEPING ROADWAYS AND PAVED AREAS WHERE WORK IS BEING CONDUCTED AT THE END OF EACH WORKING DAY. SWEEPING IS NOT EFFECTIVE IF SEDIMENT IS WET OR CAKED. WET OR CAKED SEDIMENT SHALL BE SCRAPED.
- 21. CONTRACTOR SHALL MONITOR ONSITE SOLID WASTE STORAGE AND DISPOSAL PROCEDURES TO MINIMIZE POTENTIAL FOR STORMWATER CONTAMINATION.
- CONTRACTOR SHALL ROUTINELY POLICE THE CONSTRUCTION SITE FOR LITTER AND DEBRIS.
- 3. ANY HAZARDOUS WASTE GENERATED FROM THE SITE SHALL BE PROPERLY LABELED AND SHALL BE DISPOSED OF AT AUTHORIZED TREATMENT, STORAGE AND DISPOSAL FACILITIES.
- TEMPORARY HAZARDOUS WASTE MATERIAL STORAGE SHALL BE LOCATED AWAY FROM ALL WATER COURSES AND STORM WATER CONVEYANCE SYSTEMS.
- HAZARDOUS WASTE MATERIALS SHALL BE STORED IN AREAS NOT SUSCEPTIBLE TO RAIN AND CONTRACTOR SHALL PROVIDE SECONDARY CONTAINMENT IN CASE OF SPILLS OR LEAKS. IN THE EVENT OF A HAZARDOUS SPILL ON LEAK, CONTRACTOR SHALL NOTIFY THE STATE OFFICE OF EMERGENCY SERVICES (800) 852—7550 AND THE NAPA COLUMY PLANNING BUILDING AND ENVIRONMENTAL SERVICES DEPARTMENT (707) 253—4471
- SPILLS SHALL BE IMMEDIATELY CLEANED UP AND CONTAMINATED SOILS AND CLEAN UP MATERIALS SHALL BE DISPOSED OF PROPERLY, DRY SPILLS SHALL BE SWEPT NOT WASHED OR HOSED. WET SPILLS ON IMPERMEABLE SURFACES SHALL BE ABSORBED AND ABSORBENT MATERIALS PROPERLY DISPOSED OF. WET SPILLS ON SOIL SHALL BE DUG UP AND ALL EXPOSED SOILS PROPERLY DISPOSED OF.
- 27. MAJOR MAINTENANCE / REPAIR AND WASHING OF CONSTRUCTION EQUIPMENT SHALL OCCUR OFFSI
- 28. CONSTRUCTION EQUIPMENT SHALL BE MAINTAINED REGULARLY AND INSPECTED FREQUENTLY FOR DAMAGED HOSES, LEAKY GASKETS OR OTHER SERVICE PROBLE
- 29. CONTRACTOR SHALL VERIFY WEEKLY THAT SUFFICIENT SPILL CONTROL AND CLEAN UP MATERIALS ARE LOCATED NEAR MATERIAL STORAGE, UNLOADING AND USE AREAS.
- 30. CONTRACTOR SHALL UPDATE ONSITE SPILL PREVENTION AND CONTROL PLANS AND STOCK APPROPRIATE CLEAN UP MATERIALS WHENEVER CHANGES OCCUR ON
- CONTRACTOR IS RESPONSIBLE FOR TRAINING EMPLOYEES AND SUBCONTRACTORS ON CONSTRUCTION SITE MANAGEMENT AND BEST MANAGEMENT PRACTICES.

AMB DEVELOPMENT
2059 RENPOINT WAY
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EROSION & SEDIMENT CONTROL PL JASON & JENNIFER PASQUETTI 1406 FOOTHILL BLVD. CALISTOGA, CA 94515

PROJECT#: PASQUETTI

SCALE: SEE SHEET

DATE: 1/6/2019

APPROVALS

DESIGNED BY: DESIGNER

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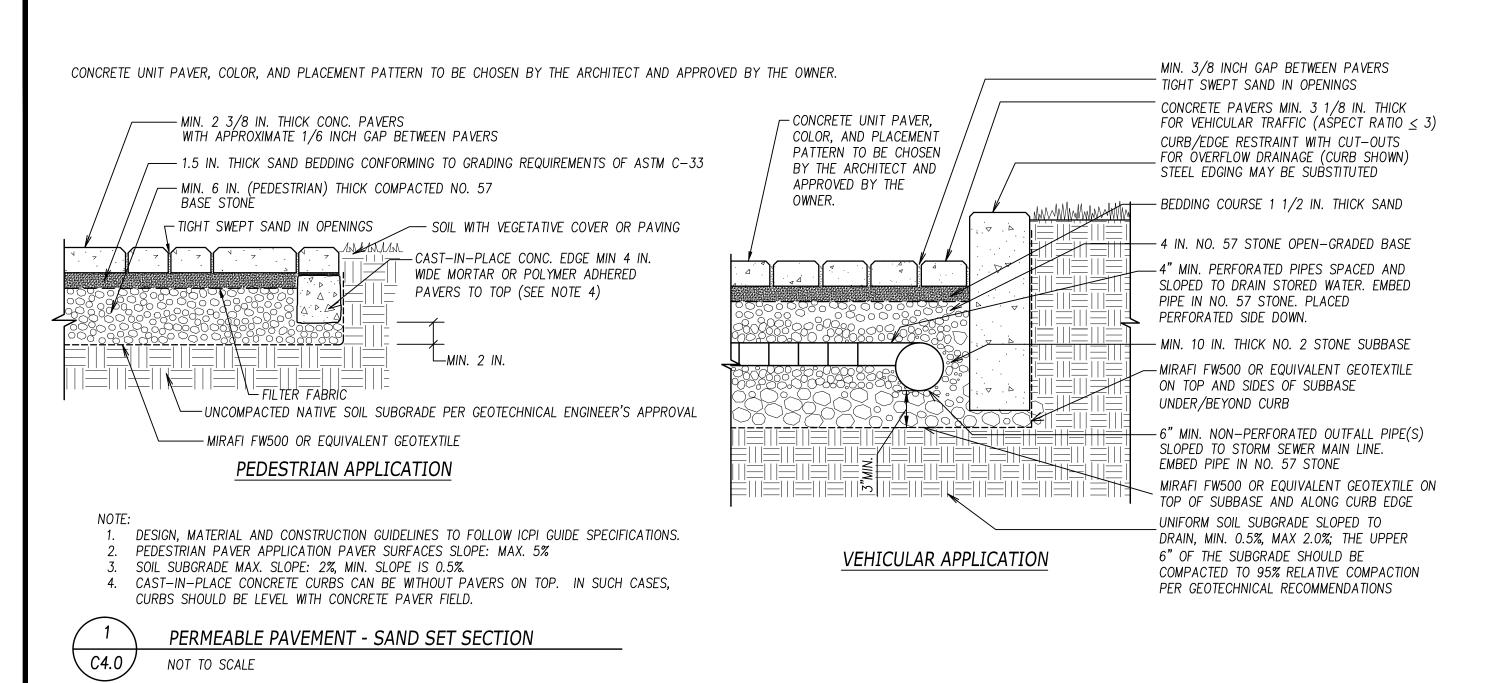
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CONTROL PLAN

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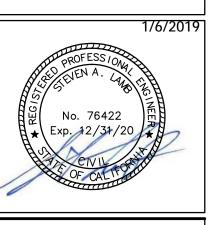
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NOTE: IT IS RECOMMENDED THAT INSTALLATION BE PERFORMED BY INDUSTRY—CERTIFIED PROFESSIONAL AND ACCORDING TO VENDOR SPECIFICATIONS.

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ROSEVILLE, CA 95661
TEL: 916-708-8012
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JASON & JENNIFER PASQUETTI 1406 FOOTHILL BLVD. CALISTOGA, CA 94515

DETAILS

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SCALE: SEE SHEET

DATE: 1/6/2019

APPROVALS

DESIGNED BY: DESIGNER

DRAWN BY: DRAFTER

CHECKED BY: ENGINEER

SHEET TITLE

SITE DETAILS

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