



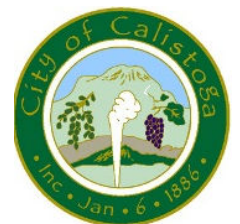

LOCATION MAP
226 High Street
APN 011-381-013

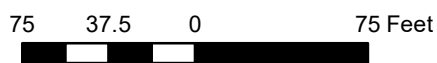

226 High Street Addition

We first purchased 226 High St. Calistoga 10 years ago. Since we retired almost 3 years ago we have been spending the majority of our time in Calistoga which has become our new primary home base. Due to this primary relocation to Calistoga from San Francisco we find that we need more space.

The existing house is a one story, flat-roofed building approximately 17.5 tall. There is also an existing detached two-story garage with a second floor guest unit above. This garage sits on higher ground uphill from the house. It is approximately 10-12' higher than the house.

The existing house is approximately 7.5 feet below the height limit. We are planning to add approximately 623 sf on the first floor level for a larger Master Suite. Due to the ground sloping down on the west end of our house we find there is space for 522 sf below the first floor. In order to maintain the architectural integrity and continuity of the existing house with the flat roof we need a height variance of 4.5 feet for the addition. We are not building higher than the existing structure but are adding space below because of the sloping grade of our lot which is not visible to the public.

Babette and Steven Pinsky
September 19, 2019



Attachment 4

From: Douglas Allan doug.calistoga@gmail.com
Subject: Addition to house
Date: September 20, 2019 at 9:03 AM
To: Steven stevenpinsky@gmail.com
Cc: Stephanie Allan stephaniej.allan@gmail.com

Steven,
Thanks for showing me the plans for your addition. We do not have any objections.

Douglas Allan
doug.calistoga@gmail.com
(707) 339-6641
224 High St, Calistoga, CA 94515

Photos of area where addition is proposed



Pinsky Residence

Attachment 6

ABBREVIATIONS

| | | | |
|----------|------------------|---------|------------------------|
| ARCH. | ARCHITECTURAL | INT. | INTERIOR |
| BTWN. | BETWEEN | MAX. | MAXIMUM |
| BLDG. | BUILDING | MIN. | MINIMUM |
| BLK. | BLOCK | MECH. | MECHANICAL |
| BM. | BEAM | MFGR. | MANUFACTURER |
| CSMT. | CASEMENT | MICRO. | MICROWAVE |
| CLR. | CLEAR | MTL. | METAL |
| CL'G. | CEILING | NAT. | NATURAL |
| C.J. | CEILING JOIST | (N) | NEW |
| COL. | COLUMN | NO. | NUMBER |
| CONC. | CONCRETE | O.C. | ON CENTER |
| CONT. | CONTINUOUS | PLYWD. | PLYWOOD |
| DRY. | DRYER | RIS. | RISERS |
| DIA. | DIAMETER | R.O. | ROUGH OPENING |
| DIM. | DIMENSION(S) | R.R. | ROOF RAFTERS |
| D.W. | DISHWASHER | REV. | REVISION |
| DWGS. | DRAWINGS | REFR. | REFRIGERATOR |
| ELEV. | ELEVATION | REQD. | REQUIRED |
| EQ. | EQUAL | SHT. | SHEET |
| (E) | EXISTING | SL. | SLIDER |
| EXT. | EXTERIOR | SIM. | SIMILAR |
| F.A.U. | FORCED AIR UNIT | STL. | STEEL |
| FIN. | FINISH, FINISHED | STRUCT. | STRUCTURAL |
| FLR. | FLOOR | TEMP. | TEMPERED |
| F.J. | FLOOR JOIST | TR. | TREADS |
| FTG. | FOOTING | T.&G. | TONGUE & GROOVE |
| FRZ. | FREEZER | T.O. | TOP OF |
| G.A. | GAUGE | TYP. | TYPICAL |
| GALV. | GALVANIZED | U.N.O | UNLESS NOTED OTHERWISE |
| G.D. | GARBAGE DISPOSAL | V.I.F. | VERIFY IN FIELD |
| GRD. | GRADE | WASH. | WASHER |
| GYP. BD. | GYP. BOARD | W.H. | WATER HEATER |
| HDR. | HEADER | WD. | WOOD |
| HGT. | HEIGHT | | |

APPLICABLE CODES


The City of Calistoga has adopted the following building codes.

- 2016 California Administrative Code
- 2016 California Building Code
- 2016 California Residential Code
- 2016 California Mechanical Code
- 2016 California Plumbing Code
- 2016 California Electrical Code
- 2016 Energy Code
- 2016 California Green Building Code
- 2016 California Fire Code
- 2016 Existing Building Code
- 2016 California Referenced Standards Code
- City of Calistoga local amendments to the above adopted codes


LEGEND

- # DOOR
- # WINDOW
- X Detail #
A-XX Sheet # DETAIL
- A-XX X INTERIOR ELEVATIONS
- X Sect. #
A-XX Sheet # SECTION
- X Sect. #
A-XX Sheet # EXTERIOR ELEVATION
- X-X' (UNLESS NOTED OTHERWISE)
- X SLOPE
- X-X' ELEVATION HEIGHTS


ASSESSOR MAP

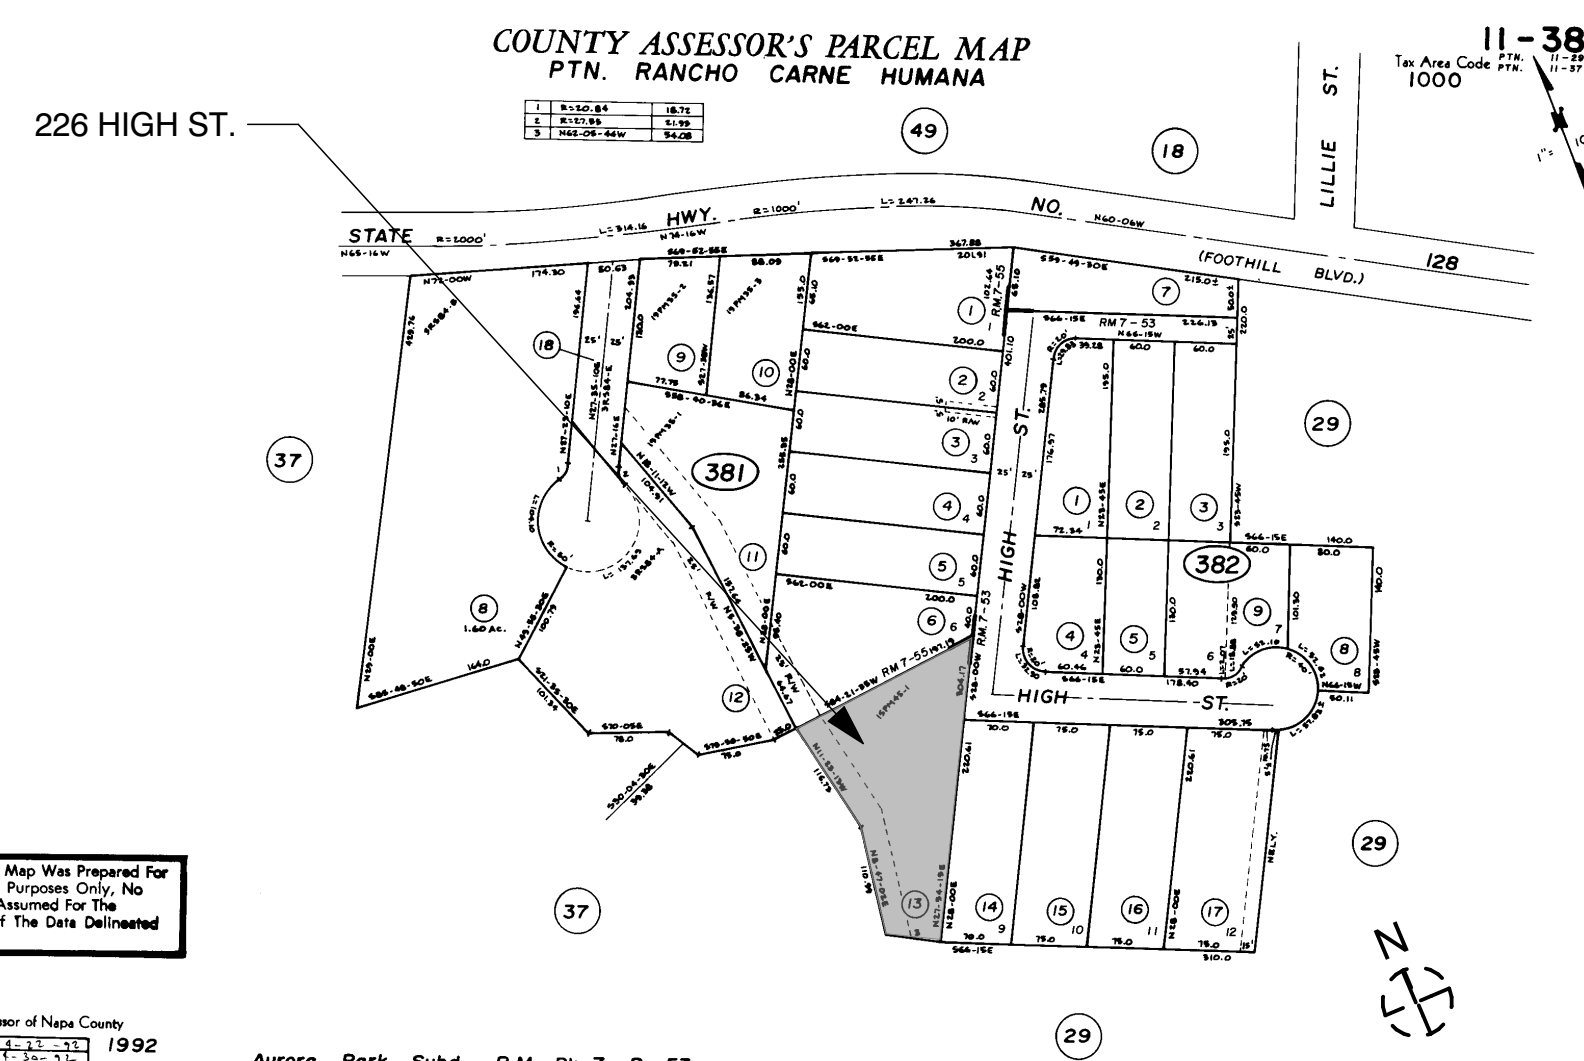

ZONING MAP

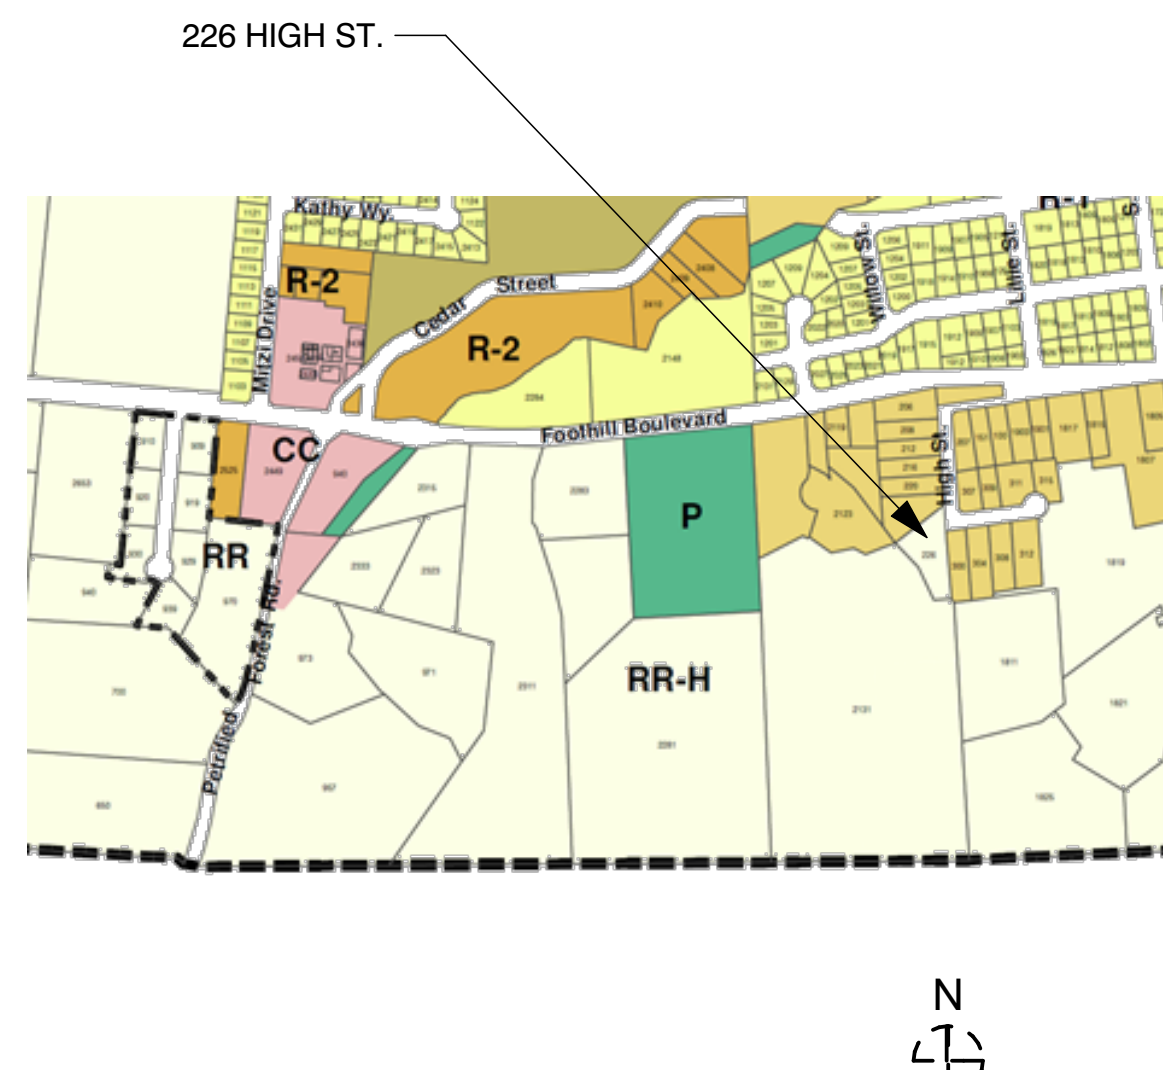

VICINITY MAP

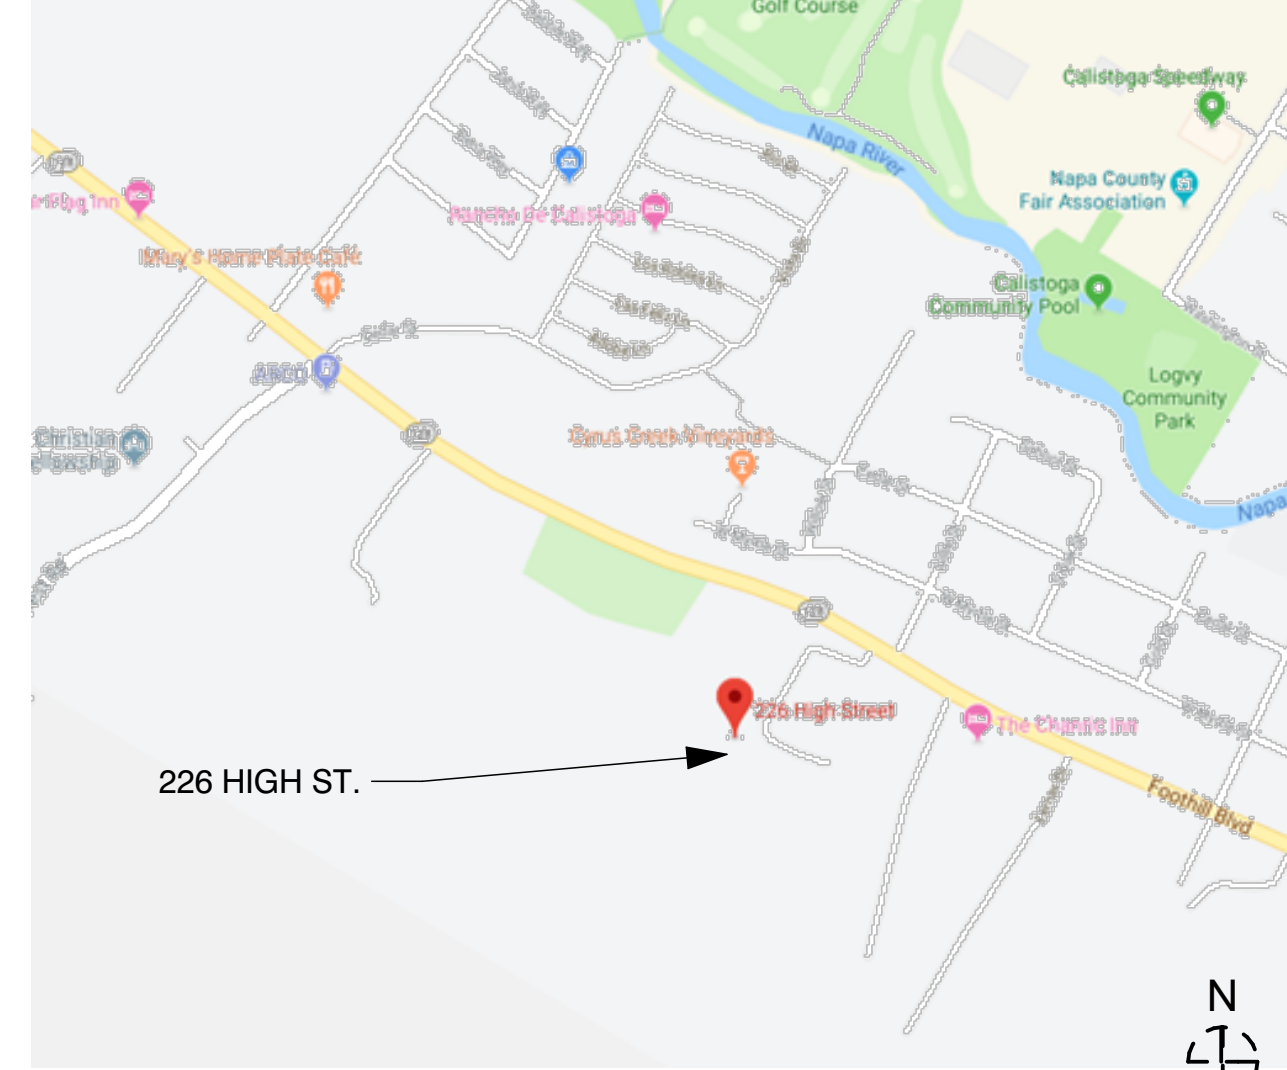

CONTACTS

| | |
|--------------------------------|---|
| CLIENT: | Steven and Babbette Pinsky 226 High Street Calistoga, CA 94515 |
| ARCHITECT: | Beckstrom Architecture/Planning + Consulting Inc. PO Box 1317, Los Gatos, CA 95030 650 847-8351, eric@beckstromarchitecture.com |
| STRUCTURAL ENGINEER: | Efe Sozkesen MS, PE 4x Engineering, Inc., 4340 Stevens Creek Blvd. Suite # 240 San Jose, CA 95129 408 642-5464 |
| CONTRACTOR: | Reveal Partners 1501 Cortland Ave. San Francisco, CA 94110 415-710-3336 james@sreveal.com |
| TITLE 24/ GREENPOINT RATER: | Title 24 Data Corp David Wigg 633 Monterey Trail, POB 2199, Frazier Park, CA 93225-2199 800-237-8824; title24@frazmtn.com |

CONTENTS

| ARCHITECTURAL | |
|---------------|---------------------------------|
| A0.0 | COVER SHEET |
| A1.0 | SITE PLAN |
| A2.0E | LOWER LEVEL-EXISTING |
| A2.1E | FIRST/SECOND FLOOR-EXISTING |
| A2.1 | CRAWLSPACE/PIER/FOUNDATION PLAN |
| A2.2 | LOWER LEVEL PLAN |
| A2.3 | FIRST FLOOR PLAN |
| A2.4 | SECOND FLOOR/ROOF PLAN |
| A3.0E | EXISTING ELEVATIONS |
| A3.1E | EXISTING ELEVATIONS |
| A3.2 | PROPOSED ELEVATIONS |
| A3.3 | PROPOSED ELEVATIONS |

PROJECT DATA & DESCRIPTION

| | |
|--------------------------------|---|
| Assessor's Parcel Number(APN): | 011-381-013-000 |
| ZONING: | RR-H |
| LOT SIZE(GROSS): | .75 ACRE 32,760 SF |
| CONSTRUCTION TYPE: | TYPE V, TYPE U |
| OCCUPANCY GROUP: | R3 - SINGLE FAMILY DWELLING / 1-STORY, GROUP U PRIVATE GARAGE/ADU, 2 STORY |

PROJECT DESCRIPTION
CONSTRUCT ADDITION TO RELOCATE MASTER BEDROOM WITH A NEW LOWER LEVEL STORAGE ROOM

MISC. NOTES

CONSTRUCTION FIRE SAFETY
A fire extinguisher shall be placed on each floor of each building during construction.

| REVISIONS | BY |
|-----------|----|
| △ | EB |
| △ | |
| △ | |
| △ | |

BECKSTROM
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 650.847.8351
 P.O. BOX 1317, LOS GATOS, CA 95030
 eric@beckstromarchitecture.com
 www.beckstromarchitecture.com

An Addition to the
Pinsky Residence
 226 High Street
 Calistoga, CA

Variance
Submission

| | |
|----------------|-----------------------|
| SEAL: | |
| DRAWING TITLE: | COVER SHEET |
| DRAWN: | EB |
| DATE: | 9/19/2019 |
| SCALE: | 1' = 1'-0" |
| JOB NO.: | 6 |
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| SHEET: | A0.0 |

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- ANY STUD MAY BE BORED OR DRILLED PROVIDED THAT THE DIA. OF THE RESULTING HOLE IS NO MORE THAN 60% OF THE STUD WIDTH AND THE EDGE OF THE HOLE IS NO MORE THAN 5/8" FROM THE EDGE OF THE STUD, AND THE HOLE IS NOT LOCATED IN THE SAME SECTION AS A CUT OR NOTCH OR USE OF AN APPROVED STUD SHOE IS PERMITTED WHEN THEY ARE INSTALLED IN ACCORDANCE WITH THE MANUFACTURER'S RECOMMENDATIONS, PER CRC 602.6.2.
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- AT THE TIME OF FINAL INSPECTION, A MANUAL, CD, WEB-BASED REFERENCE OR OTHER MEDIA ACCEPTABLE TO THE ENFORCING AGENCY WHICH COMPLIES WITH THE SPECIFICATIONS IN CALGREEN 4.410.1.
- ADHESIVES, SEALANTS, AND CAULKS USED ON THE PROJECT SHALL MEET THE REQUIREMENTS OF SCAQMD RULE 1168 VOC LIMITS UNLESS MORE STRINGENT LOCAL OR REGIONAL AIR POLLUTION OR AIR QUALITY MANAGEMENT DISTRICT RULES APPLY.
- ARCHITECTURAL PAINTS AND COATINGS SHALL COMPLY WITH VOC LIMITS IN TABLE 1 OF THE AIR RESOURCES BOARD ARCHITECTURAL SUGGESTED CONTROL MEASURE, AS SHOWN IN CALGREEN TABLE 4.504.3, UNLESS MORE STRINGENT LOCAL LIMITS APPLY.
- AEROSOL PAINTS AND COATINGS SHALL MEET THE PRODUCT-WEIGHTED MIR LIMITS FOR ROC IN SECTION 94522(a)(3) AND OTHER REQUIREMENTS, INCLUDING PROHIBITIONS ON USE OF CERTAIN TOXIC COMPOUNDS AND OZONE DEPLETING SUBSTANCES, IN SECTION 94522 (c)(2) AND (d)(2) OF THE CA CODE OF REGULATIONS, TITLE 17, COMMENCING WITH SECTION 94520; AND IN AREAS UNDER THE JURISDICTION OF THE BAAQMD SHALL ADDITIONALLY COMPLY WITH THE PERCENT VOC BY WEIGHT OF PRODUCT LIMITS OF REGULATION 8, RULE 49.
- HARDWOOD PLYWOOD, PARTICLEBOARD AND MFC COMPOSITE WOOD PRODUCTS USED ON THE INTERIOR OR EXTERIOR OF THE BUILDING SHALL MEET THE REQUIREMENTS OF OR FORMALDEHYDE AS SPECIFIED IN ARP'S AIR TOXICS CONTROL MEASURE FOR COMPOSITE WOOD CA CODE OF REGULATIONS, TITLE 17, SECTION 93120.1(a).
- WHERE CONCRETE SLAB FOUNDATIONS OR CONCRETE SLAB-ON-GROUND FLOORS ARE REQUIRED TO HAVE A VAPOR RETARDER, A CAPILLARY BREAK SHALL BE INSTALLED IN COMPLIANCE WITH ONE OF THE FOLLOWING:
A) A 4-INCH THICK BASE OF 1/2" OR LARGER CLEAN AGGREGATE SHALL BE PROVIDED WITH A VAPOR RETARDER IN DIRECT CONTACT WITH CONCRETE AND A CONCRETE MIX DESIGN WHICH WILL ADDRESS BLEEDING, SHRINKAGE AND CURLING SHALL BE USED
B) OTHER EQUIVALENT METHODS APPROVED BY THE ENFORCING AGENCY
C) A SLAB DESIGN SPECIFIED BY A LICENSED DESIGN PROFESSIONAL
- BUILDING MATERIALS WITH VISIBLE SIGNS OF WATER DAMAGE SHALL NOT BE INSTALLED. WALL AND FLOOR FRAMING SHALL NOT BE ENCLOSED WHEN THE FRAMING MEMBERS EXCEED 19% MOISTURE CONTENT.
- INSULATION PRODUCTS WHICH ARE VISIBLY WET OR HAVE A HIGH MOISTURE CONTENT SHALL BE REPLACED OR ALLOWED TO DRY PRIOR TO ENCLOSURE IN WALL OR FLOOR CAVITIES. MANUF. DRYING RECOMMENDATIONS SHALL BE FOLLOWED FOR WET-APPLIED INSULATION PRODUCTS PRIOR TO ENCLOSURE.
- WHEN REQUIRED BY THE ENFORCING AGENCY, SPECIAL INSPECTORS SHALL PROVIDE INSPECTIONS OR OTHER DUTIES NECESSARY TO SUBSTANTIATE COMPLIANCE WITH APPLICABLE CODES. SPECIAL INSPECTORS MUST BE QUALIFIED AND ABLE TO DEMONSTRATE COMPETENCE TO THE ENFORCING AGENCY IN THE DISCIPLINE IN WHICH THEY ARE INSPECTING.
- DOCUMENTATION OF COMPLIANCE SHALL INCLUDE, BUT IS NOT LIMITED TO, CONSTRUCTION DOCUMENTS, PLANS, SPECIFICATIONS, BUILDER OR INSTALLER CERTIFICATION, INSPECTION REPORTS, OR OTHER METHODS ACCEPTABLE TO THE LOCAL ENFORCING AGENCY.

DEMOLITION NOTES




- ALL DEMOLITION WORK SHALL AT ALL TIMES BE UNDER THE IMMEDIATE SUPERVISION OF A PERSON WITH THE PROPER EXPERIENCE, TRAINING, AND AUTHORITY.
- ALL REMOVED BUILDING MATERIALS, APPLIANCES, AND FIXTURES MAY BE SALVAGED AT THE OWNER'S DISCRETION. VERIFY WITH OWNER PRIOR TO DEMOLITION WHAT IS TO BE REMOVED WITH CARE, SALVAGED, AND STORED AT A LOCATION DESCRIBED BY THE OWNER.
- DEMOLITION CONTRACTOR TO REDIRECT / RECONNECT ANY ACTIVE EXISTING UTILITY, DRAINAGE, AND SPRINKLER LINES WHICH ARE DISTURBED BY DEMOLITION. CAP ALL ABANDONED LINES.
- CONTRACTOR IS TO BE FAMILIAR WITH DEMOLITION AND FIELD VERIFY ALL DEMOLITION PRIOR TO BEGINNING WORK. REPORT ANY DISCREPANCIES TO ARCHITECT.
- CONTRACTOR SHALL BE RESPONSIBLE FOR ALL SELECTIVE DEMOLITION AS REQUIRED FOR IMPROVEMENTS PROPOSED, RENOVATIONS, AND ALTERATIONS TO (E) GARAGE AND (E) RESIDENCE.
- OWNER AND ARCHITECT TO WALK JOB WITH CONTRACTOR PRIOR TO COMMENCEMENT OF DEMOLITION.
- RECYCLE AND/OR SALVAGE FOR REUSE A MINIMUM OF 50% (BY WEIGHT) OF THE NONHAZARDOUS CONSTRUCTION AND DEMOLITION WASTE IN ACCORDANCE WITH CALGREEN 4.408.2.
- SUBMIT A CONSTRUCTION WASTE MANAGEMENT PLAN:
A) IDENTIFYING THE CONSTRUCTION AND DEMOLITION WASTE MATERIALS TO BE DIVERTED FROM DISPOSAL BY RECYCLING, REUSE ON THE PROJECT OR SALVAGE FOR FUTURE USE OR SALE
B) SPECIFYING IF CONSTRUCTION AND DEMOLITION WASTE MATERIALS WILL BE SORTED ON-SITE OR BULK MIXED
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DRAINAGE NOTES

- EXISTING SITE DRAINS ONTO THE EXISTING VEGETATED SITE WHICH SURROUNDS THE EXISTING HOUSE.
- PER LID SITE DESIGN MEASURES:
- EXISTING ROOF DRAINAGE TO DISCHARGE ACROSS SPLASH BLOCKS AND INTO EXISTING LANDSCAPED AND VEGETATED AREAS
- EXISTING GRAVEL DRIVEWAY DRAINS TO LANDSCAPED AND VEGETATED AREAS ALONG THE SIDE OF THE DRIVEWAY

PROJECT SUMMARY TABLE

| LOT CALCULATIONS | |
|--|-----------------|
| LOT AREA, sf (+/- .75 ACRES) | 32,760.00 |
| (E) COVERAGE | |
| HOUSE | 1,823.00 |
| GARAGE | 595.00 |
| GARAGE ADU (FLR 2) | 595.00 |
| EXTERIOR COVERAGE TOTAL | 3,013.00 |
| % COVERAGE | 9.20% |
| (N) COVERAGE | |
| (N) ADDITION | 633.00 |
| HOUSE/GARAGE/ADU + ADDITION TOTAL | 3,646.00 |
| (N) % COVERAGE | 11.13% |
| ALLOWED % COVERAGE | 40.00% |
| COVERAGE REMAINING | 28.87% |

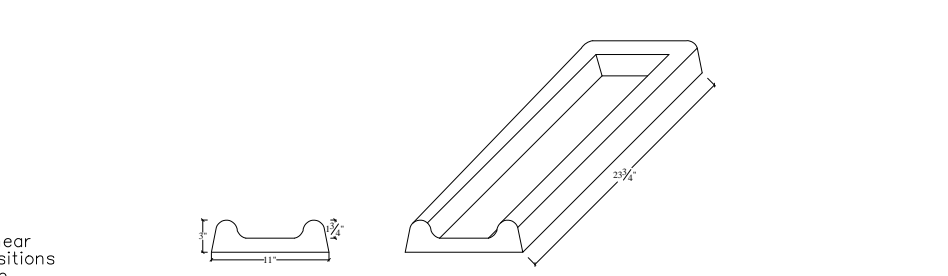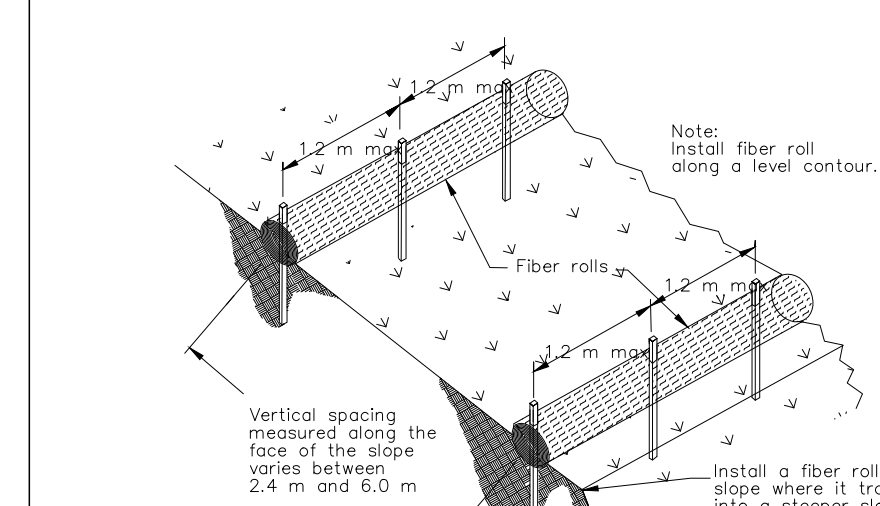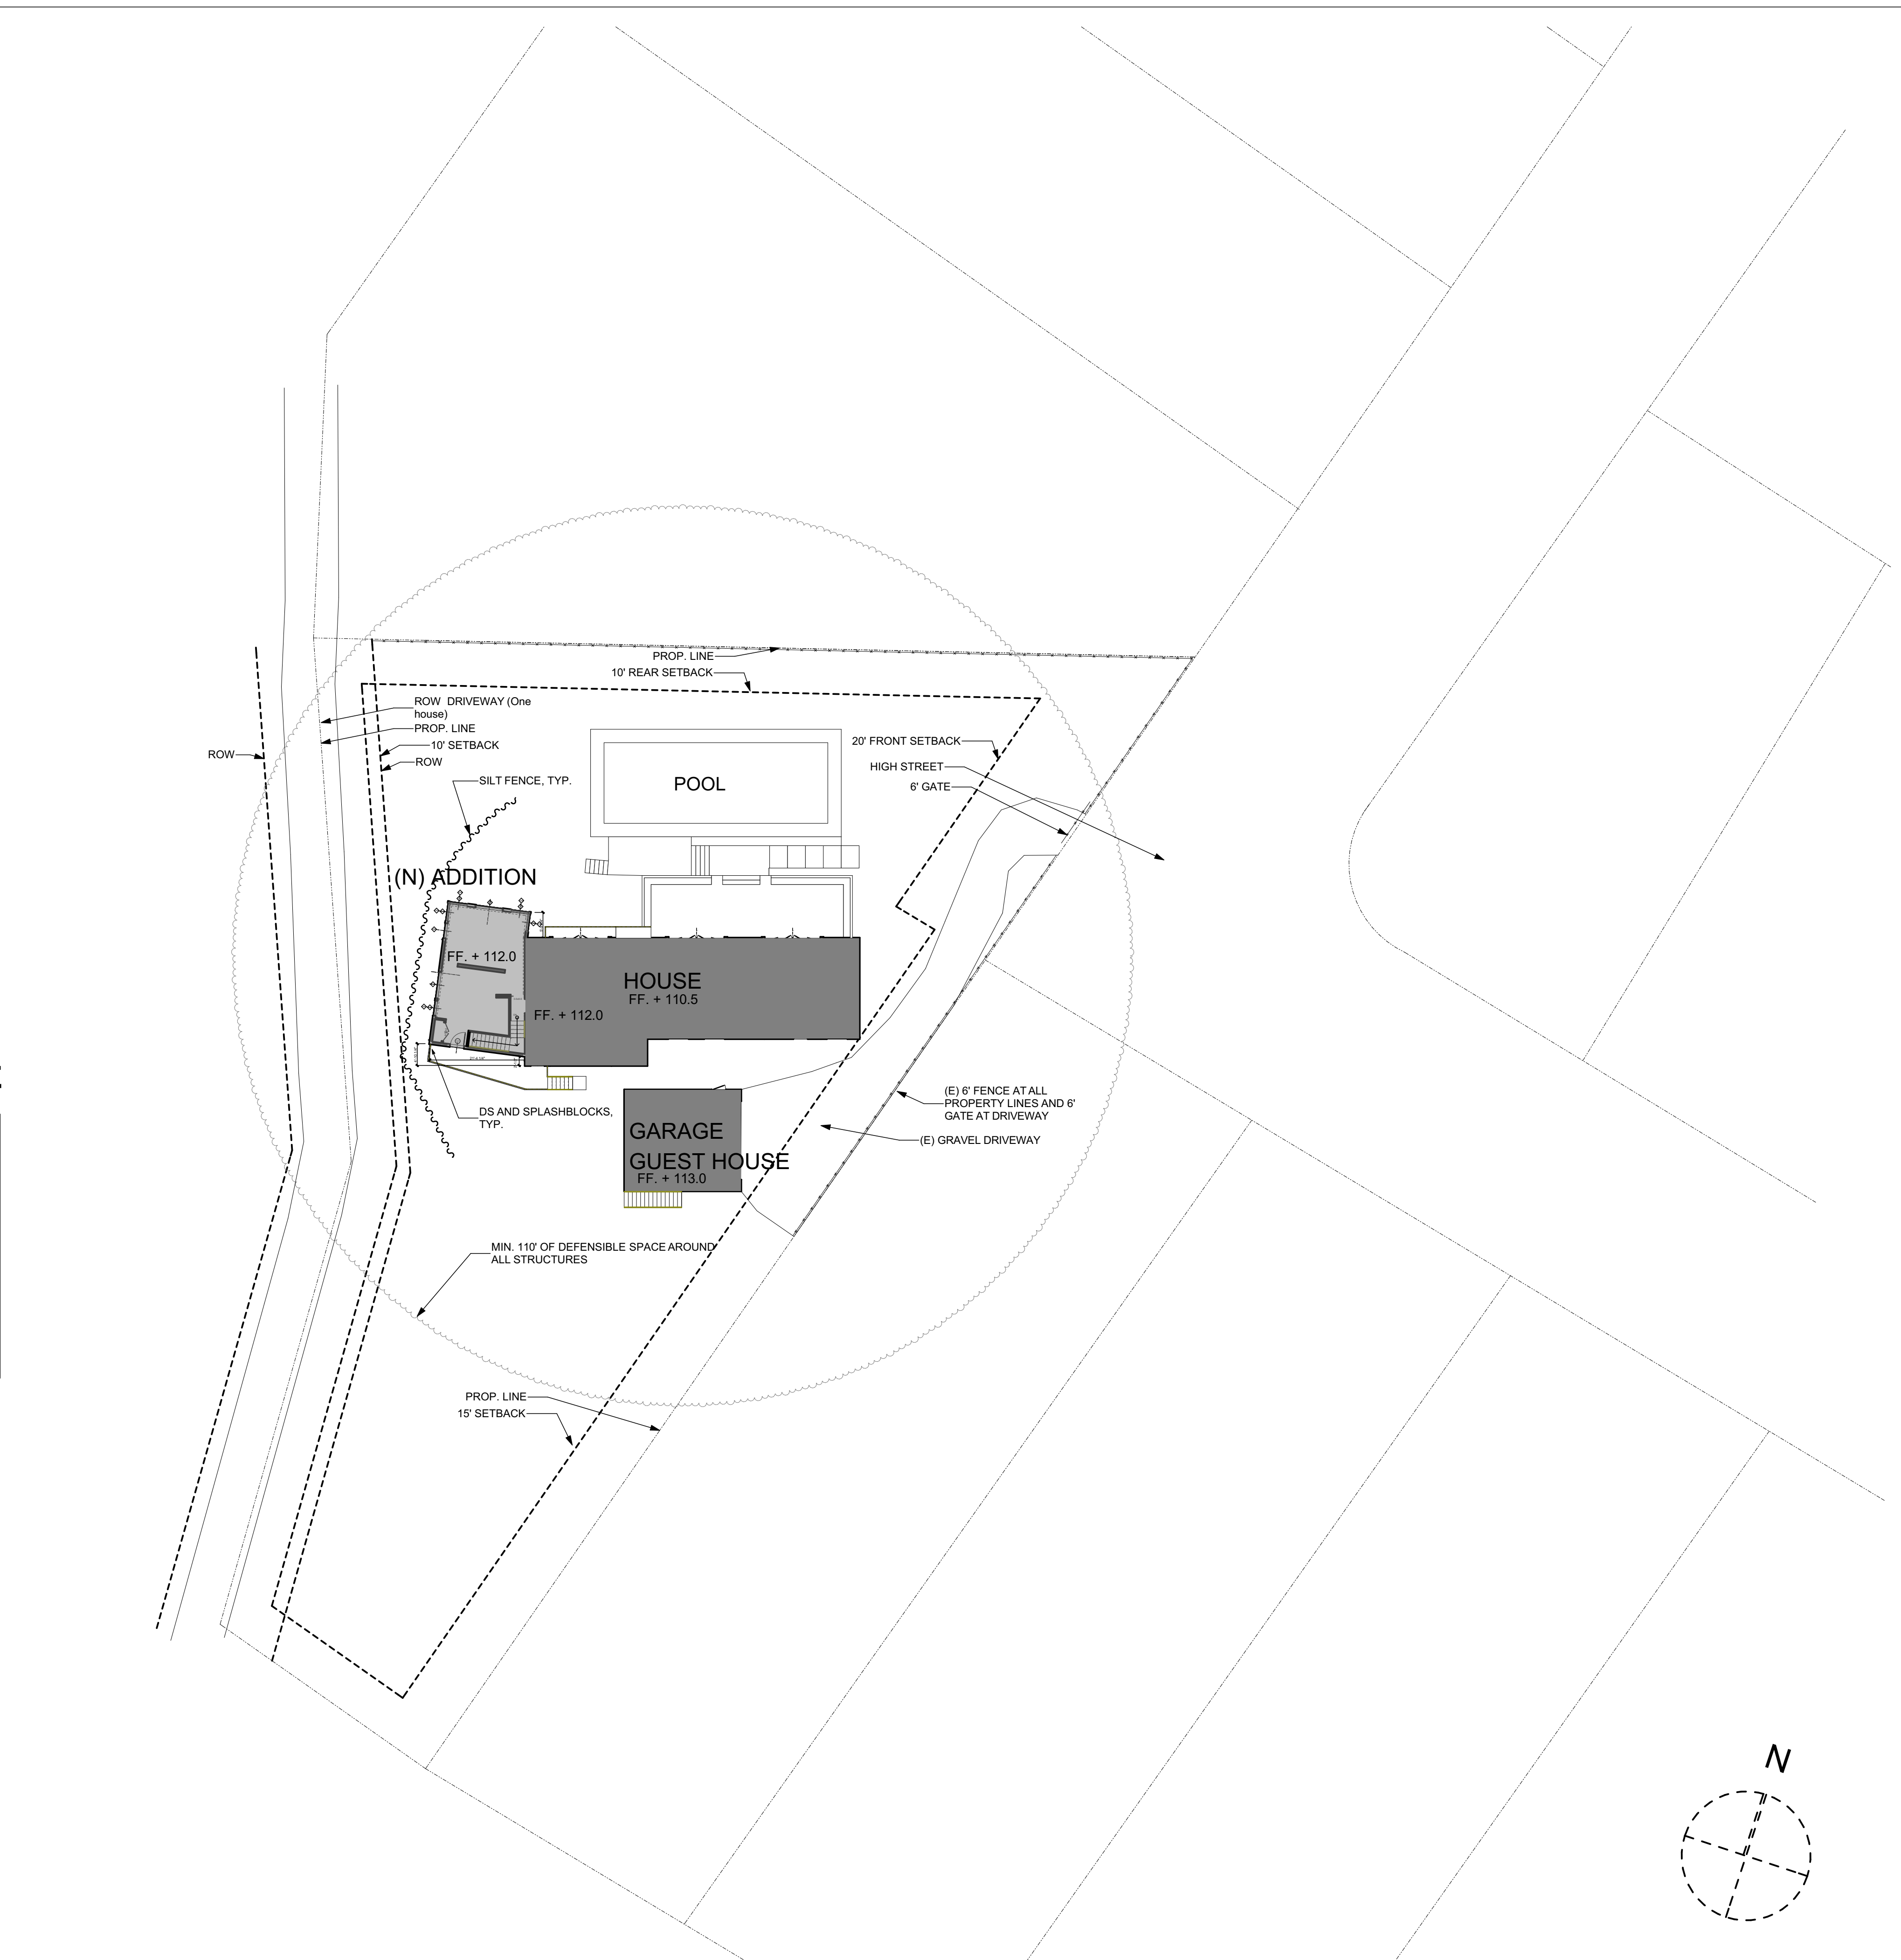

FIRST FLOOR - SITE PLAN
SCALE: 1" = 20'

| REVISIONS | BY |
|-----------|----|
| △ | EB |
| △ | |
| △ | |
| △ | |

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An Addition to the
Pinsky Residence
226 High Street
Calistoga, CA

Variance
Submission



DRAWING TITLE:
SITE PLAN

DRAWN: EB
DATE: 9/19/2019
SCALE: 20', 1:2.833, 1:2.164, 1" = 1'-0"
JOB NO.: 6
FILENAME: 1868 Pinsky CD3.0.pln

SHEET
A1.0

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- *CALGREEN RESIDENTIAL MANDATORY MEASURES


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- ANNULAR SPACES AROUND PIPES, ELECTRIC CABLES, CONDUITS, OR OTHER OPENINGS IN SOLE/BOTTOM PLATES AT EXTERIOR WALLS SHALL BE CLOSED WITH CEMENT MORTAR, CONCRETE MASONRY OR SIMILAR METHOD ACCEPTABLE TO THE ENFORCING AGENCY TO PREVENT PASSAGE OF RODENTS.
- AT THE TIME OF FINAL INSPECTION, A MANUAL, CD, WEB-BASED REFERENCE OR OTHER MEDIA ACCEPTABLE TO THE ENFORCING AGENCY WHICH COMPLIES WITH THE SPECIFICATIONS IN CALGREEN 4.410.1.
- ADHESIVES, SEALANTS, AND CAULKS USED ON THE PROJECT SHALL MEET THE REQUIREMENTS OF VOC AND RULE 1168 VOC LIMITS UNLESS MORE STRINGENT LOCAL OR REGIONAL AIR POLLUTION OR AIR QUALITY MANAGEMENT DISTRICT RULES APPLY.
- ARCHITECTURAL PAINTS AND COATINGS SHALL COMPLY WITH VOC LIMITS IN TABLE 1 OF THE AIR RESOURCES BOARD ARCHITECTURAL SUGGESTED CONTROL MEASURE, AS SHOWN IN CALGREEN TABLE 4.504.3, UNLESS MORE STRINGENT LOCAL LIMITS APPLY.
- AEROSOL PAINTS AND COATINGS SHALL MEET THE PRODUCT-WEIGHTED MIR LIMITS FOR ROC IN SECTION 94522(a)(3) AND OTHER REQUIREMENTS, INCLUDING PROHIBITIONS ON USE OF CERTAIN TOXIC COMPOUNDS AND OZONE DEPLETING SUBSTANCES, IN SECTION 94522(a)(2) AND (a)(9) OF THE CA CODE OF REGULATIONS, TITLE 17, COMMENCING WITH SECTION 94520; AND IN AREAS UNDER THE JURISDICTION OF THE BAAQMD SHALL ADDITIONALLY COMPLY WITH THE PERCENT VOC BY WEIGHT OF PRODUCT LIMITS OF REGULATION 8, RULE 49.
- HARDWOOD PLYWOOD, PARTICLEBOARD AND MDF COMPOSITE WOOD PRODUCTS USED ON THE INTERIOR OR EXTERIOR OF THE BUILDING SHALL MEET THE REQUIREMENTS OF FORMALDEHYDE AS SPECIFIED IN ARES'S AIR TOXICS CONTROL MEASURE FOR COMPOSITE WOOD CA CODE OF REGULATIONS, TITLE 17, SECTION 93120.1(a).
- WHERE CONCRETE SLAB FOUNDATIONS OR CONCRETE SLAB-ON-GROUND FLOORS ARE REQUIRED TO HAVE A VAPOR RETARDER, A CAPILLARY BREAK SHALL BE INSTALLED IN COMPLIANCE WITH ONE OF THE FOLLOWING:
 - A 4-INCH THICK BASE OF 1/2" OR LARGER CLEAN AGGREGATE SHALL BE PROVIDED WITH A VAPOR RETARDER IN DIRECT CONTACT WITH CONCRETE AND A CONCRETE MIX DESIGN WHICH WILL ADDRESS BLEEDING, SHRINKAGE AND CURLING SHALL BE USED
 - OTHER EQUIVALENT METHODS APPROVED BY THE ENFORCING AGENCY
 - A SLAB DESIGN SPECIFIED BY A LICENSED DESIGN PROFESSIONAL
- BUILDING MATERIALS WITH VISIBLE SIGNS OF WATER DAMAGE SHALL NOT BE INSTALLED. WALL AND FLOOR FRAMING SHALL NOT BE ENCLOSED WHEN THE FRAMING MEMBERS EXCEED 19% MOISTURE CONTENT.
- INSULATION PRODUCTS WHICH ARE VISIBLY WET OR HAVE A HIGH MOISTURE CONTENT SHALL BE REPLACED OR ALLOWED TO DRY PRIOR TO ENCLOSURE IN WALL OR FLOOR CAVITIES. MANUF. DRYING RECOMMENDATIONS SHALL BE FOLLOWED FOR WET-APPLIED INSULATION PRODUCTS PRIOR TO ENCLOSURE.
- WHEN REQUIRED BY THE ENFORCING AGENCY, SPECIAL INSPECTORS SHALL PROVIDE INSPECTIONS OR OTHER DUTIES NECESSARY TO SUBSTANTIATE COMPLIANCE WITH APPLICABLE CODES. SPECIAL INSPECTORS MUST BE QUALIFIED AND ABLE TO DEMONSTRATE COMPETENCE TO THE ENFORCING AGENCY IN THE DISCIPLINE IN WHICH THEY ARE INSPECTING. DOCUMENTATION OF COMPLIANCE SHALL INCLUDE, BUT IS NOT LIMITED TO, CONSTRUCTION DOCUMENTS, PLANS, SPECIFICATIONS, BUILDER OR INSTALLER CERTIFICATION, INSPECTION REPORTS, OR OTHER METHODS ACCEPTABLE TO THE LOCAL ENFORCING AGENCY.
- DUCT SYSTEM ARE SIZED AND DESIGNED AND EQUIPMENT IS SELECTED USING THE FOLLOWING:
 - ESTABLISHED HEAT LOSS AND GAIN ACCORDING TO ANSI/ACCA MANUAL J
 - DUCT SYSTEMS ARE SIZED ACCORDING TO ANSI/ACCA MANUAL D-2009
 - SELECT HEATING AND COOLING EQUIPMENT ACCORDING TO ANSI/ACCA MANUAL S-2004
- AUTOMATIC IRRIGATION CONTROLLERS - SHALL BE WEATHER R SOIL MOISTURE BASED

* 2016 CALGREEN RESIDENTIAL MANDATORY MEASURES

LOWER LEVEL

SCALE: 1/4" = 1'-0"

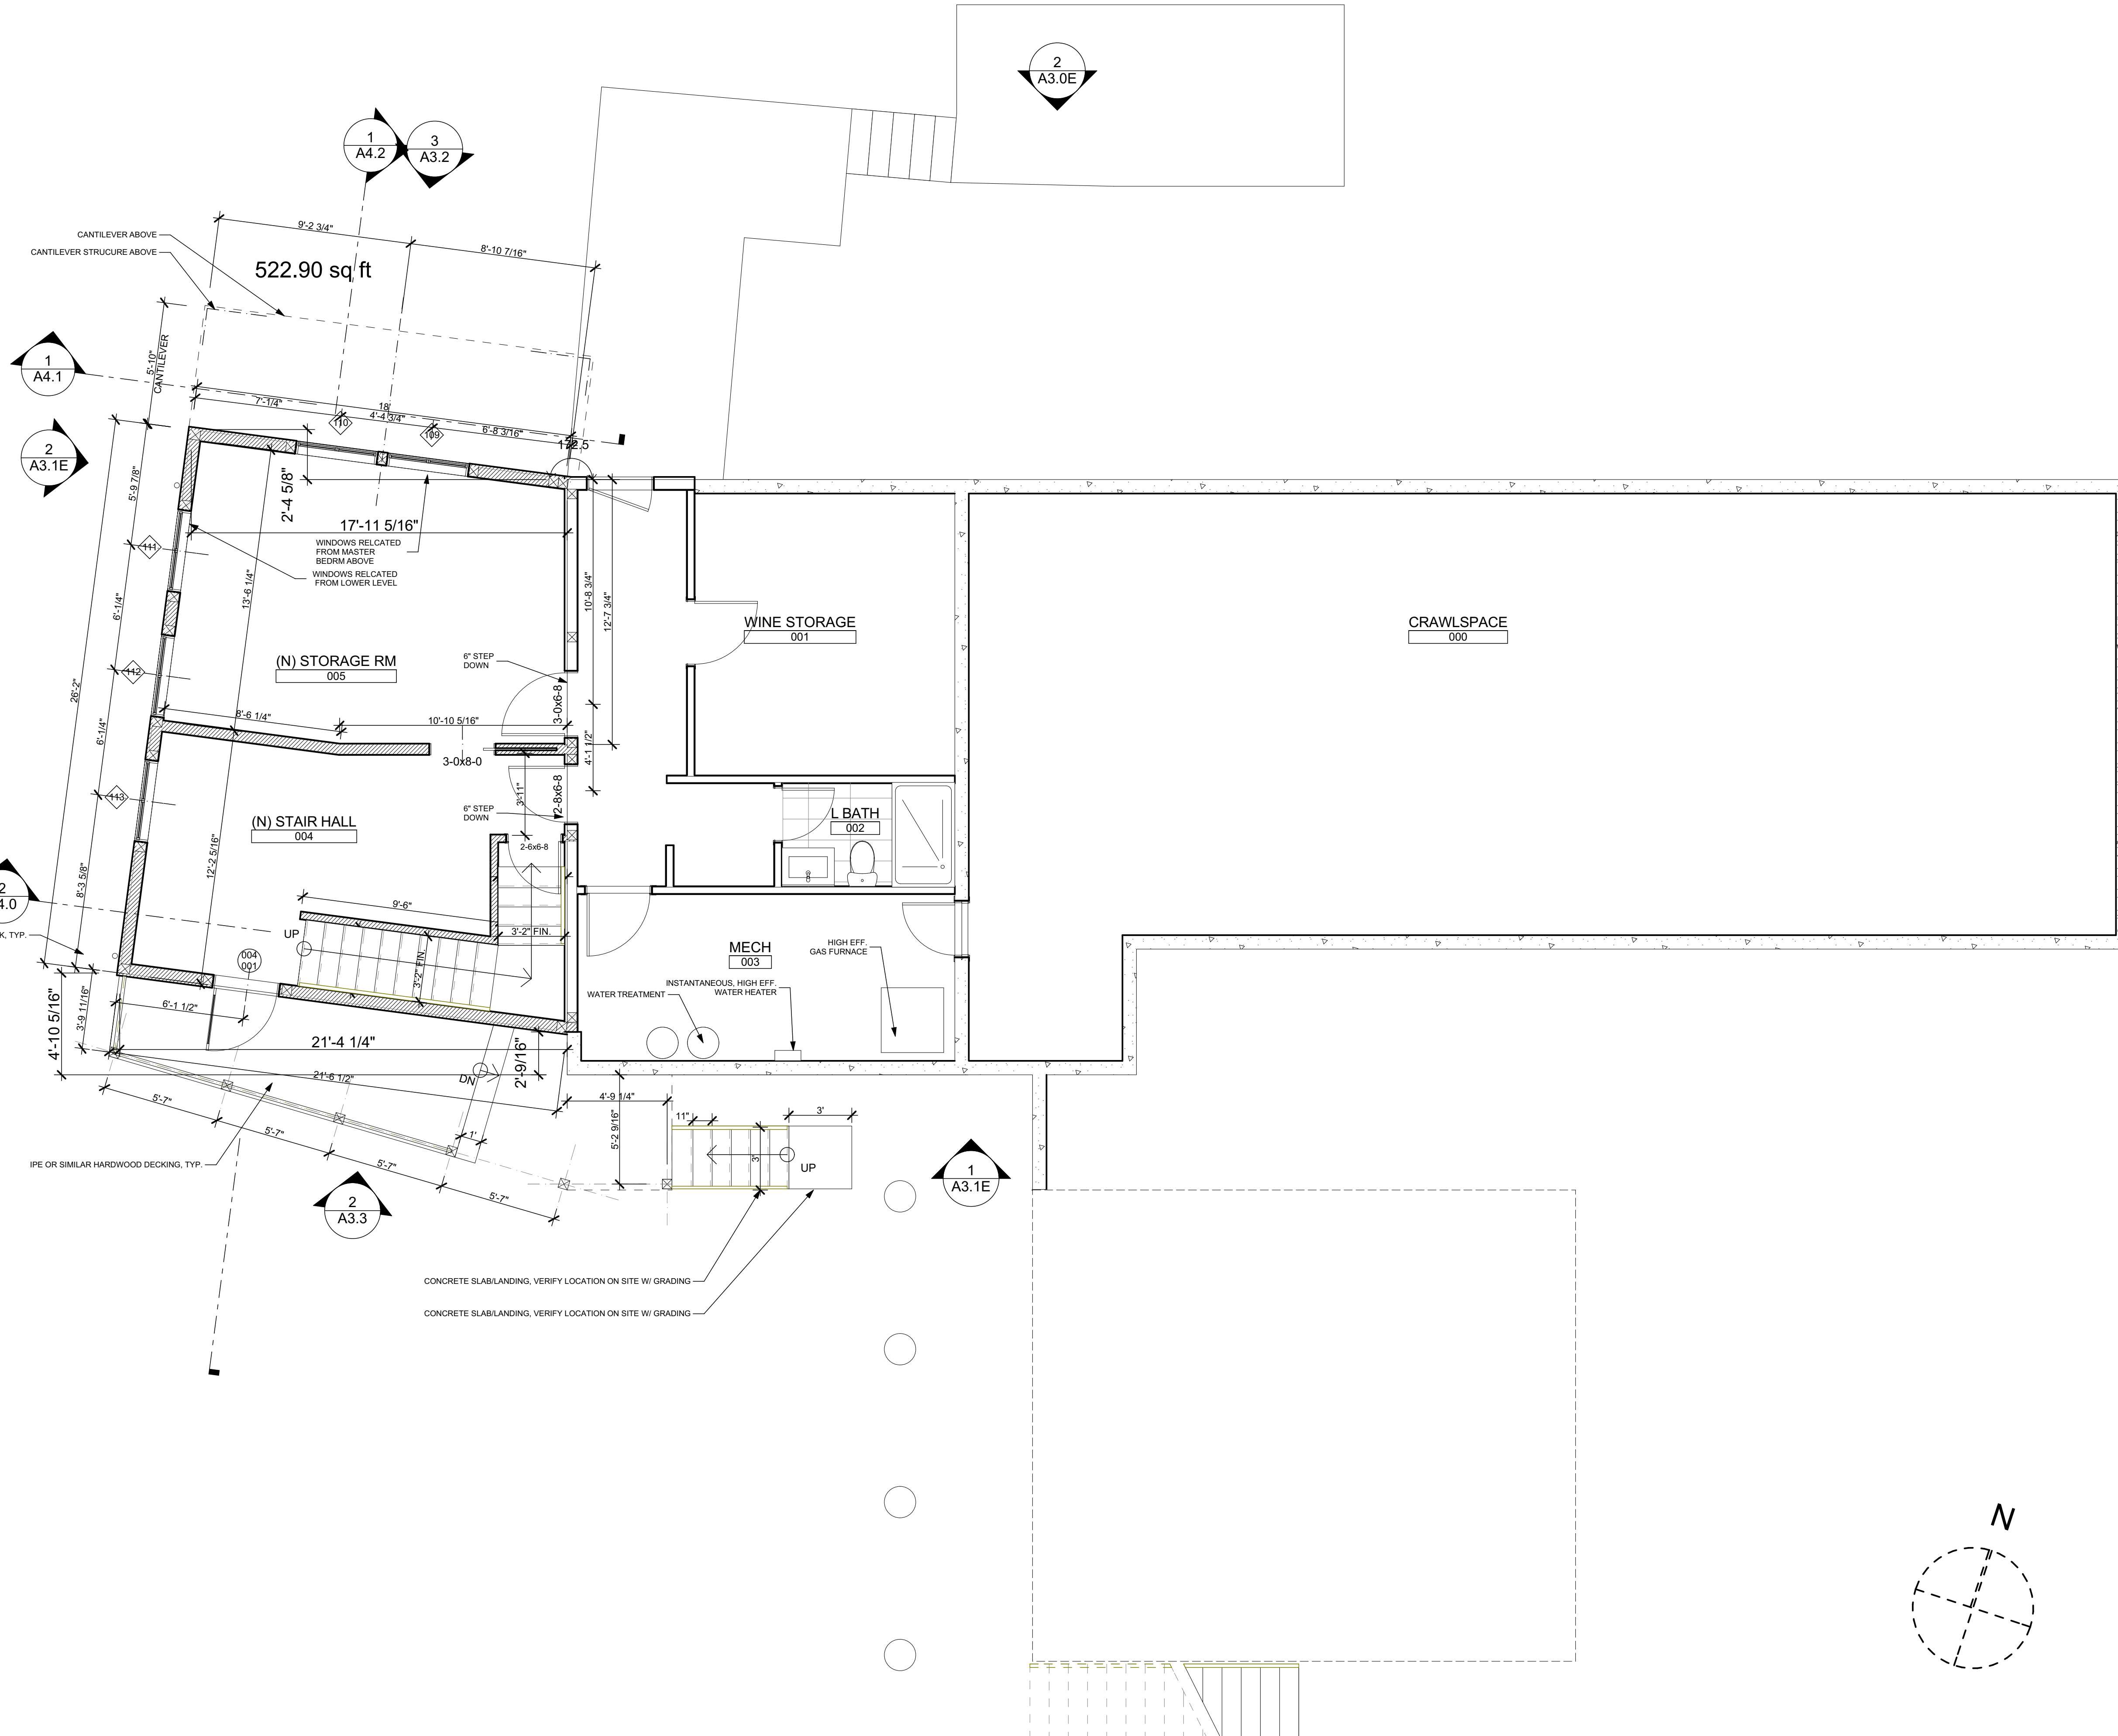


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 Calistoga, CA

Variance
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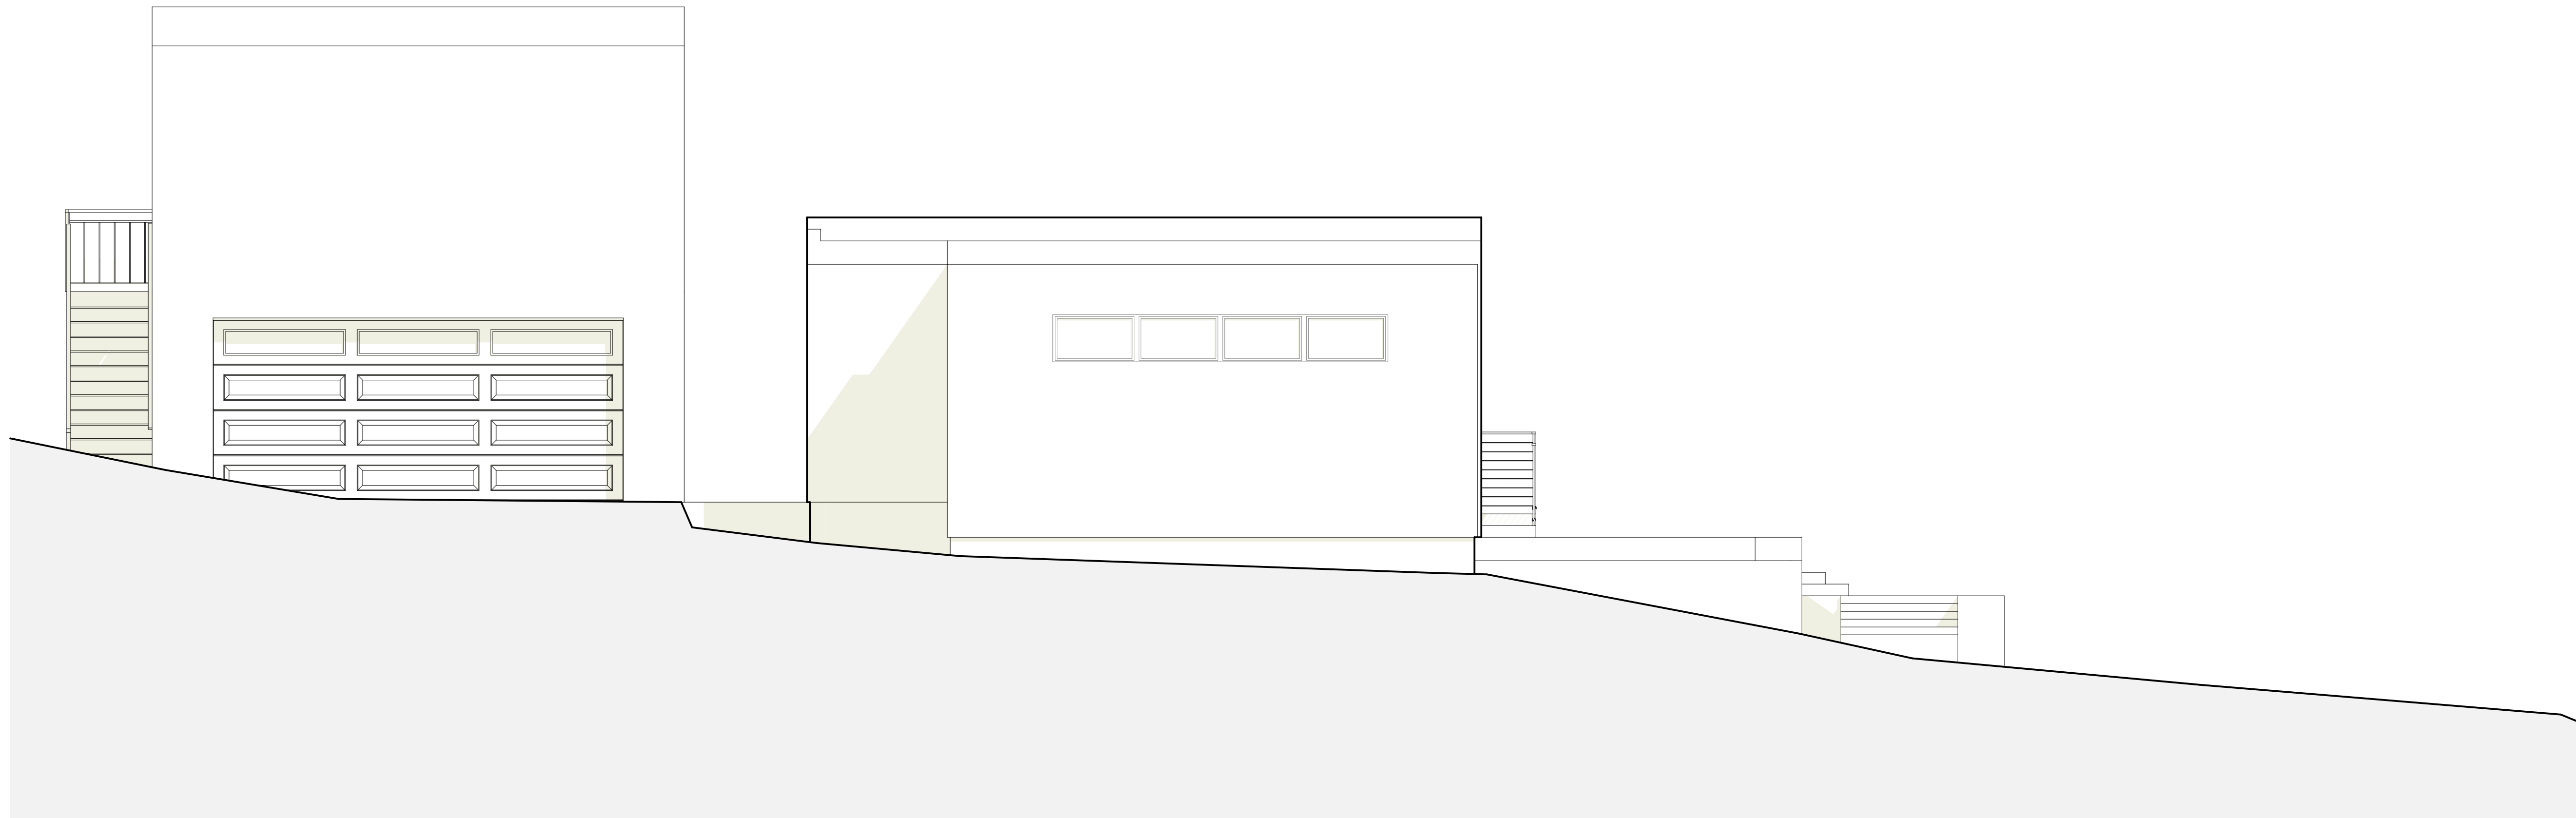
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NORTH ELEVATION

SCALE: 1/4" = 1'-0"

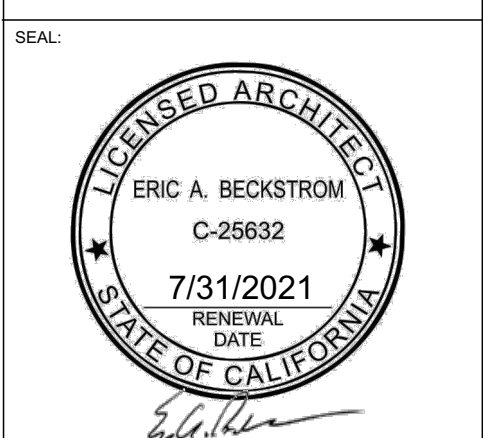

EAST ELEVATION

SCALE: 1/4" = 1'-0"

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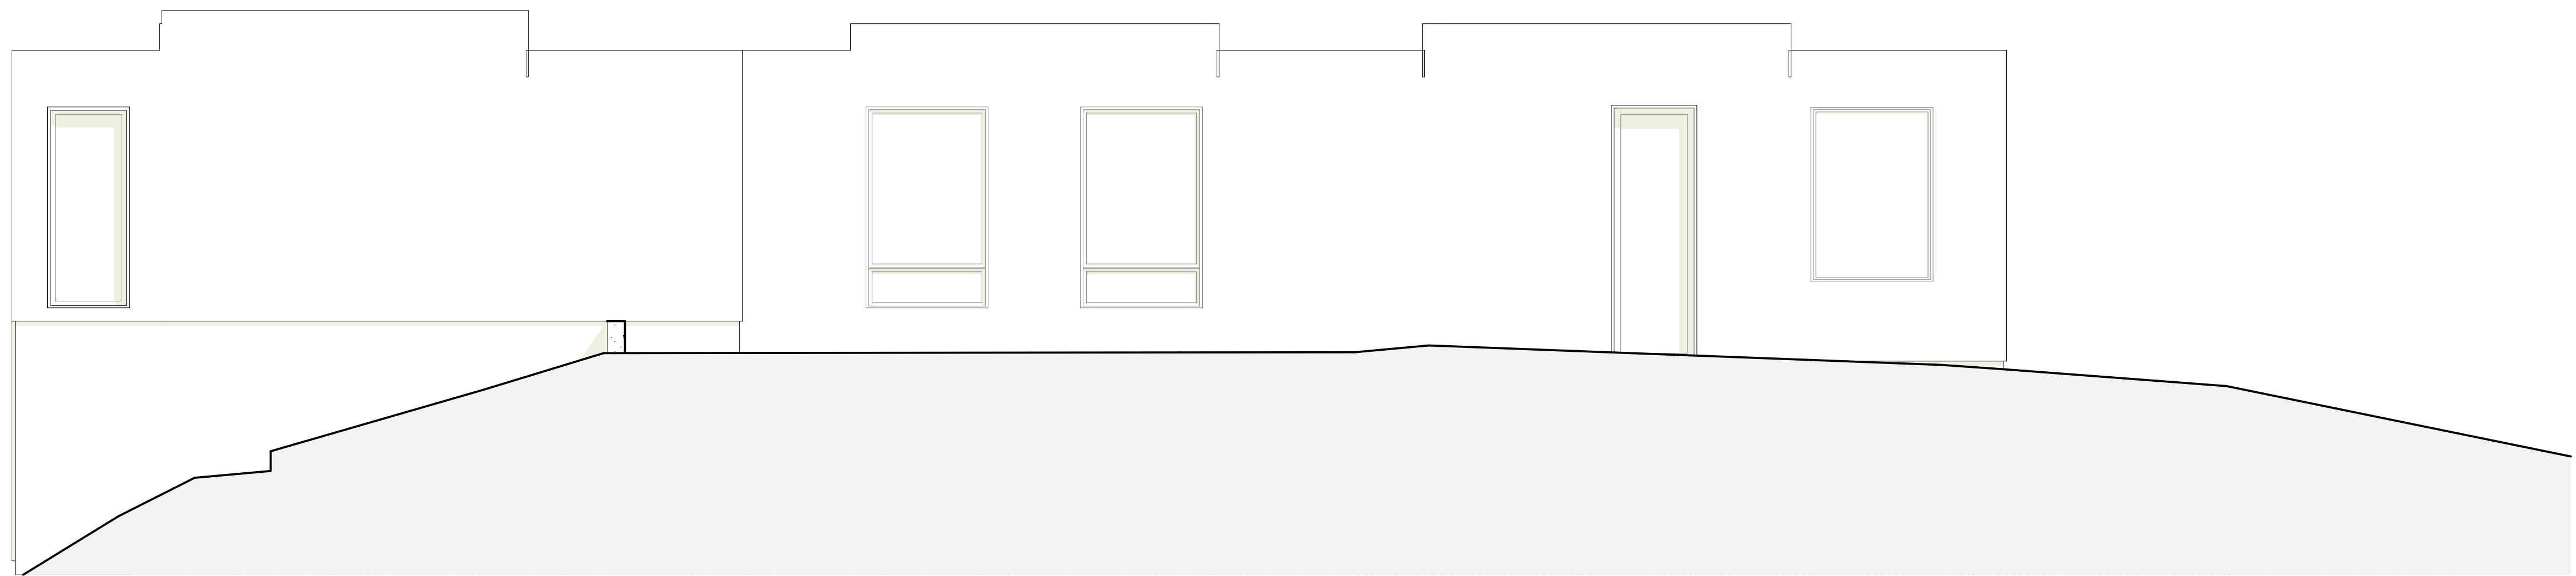
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DRAWING TITLE:
EXISTING ELEVATIONS

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SOUTH ELEVATION
SCALE: 1/4" = 1'-0"



WEST/ANGLE ELEVATION
SCALE: 1/4" = 1'-0"

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DRAWING TITLE:
EXISTING ELEVATIONS

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|----------|-----------------------|
| DRAWN | EB |
| DATE | 9/19/2019 |
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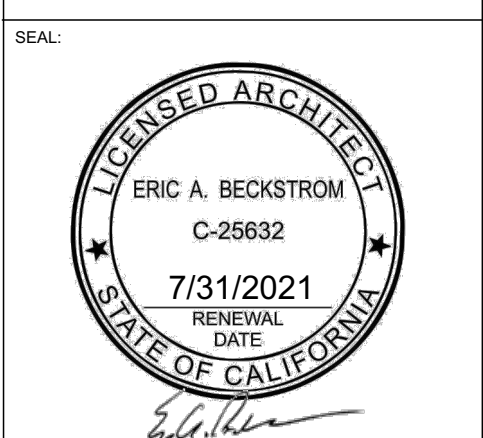
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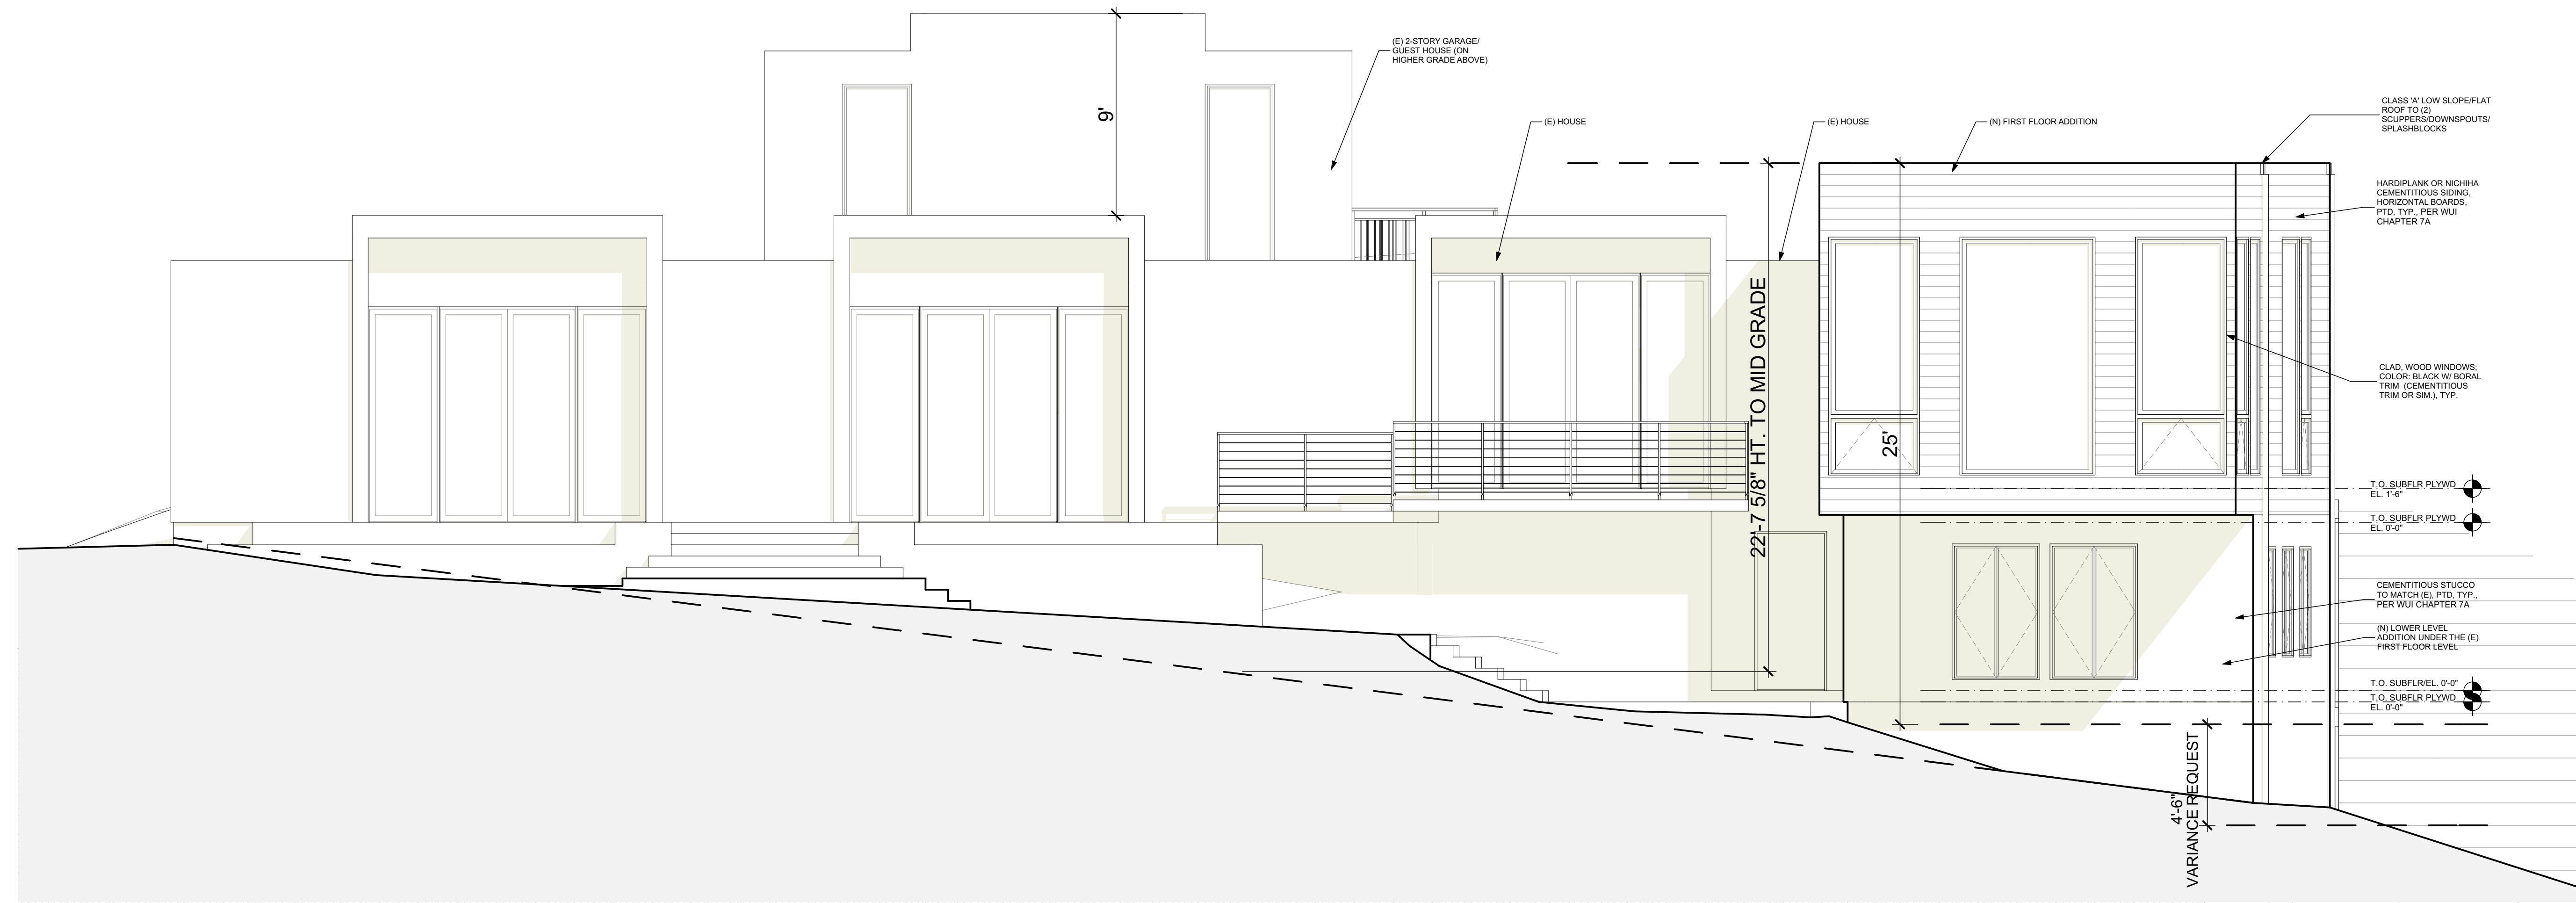
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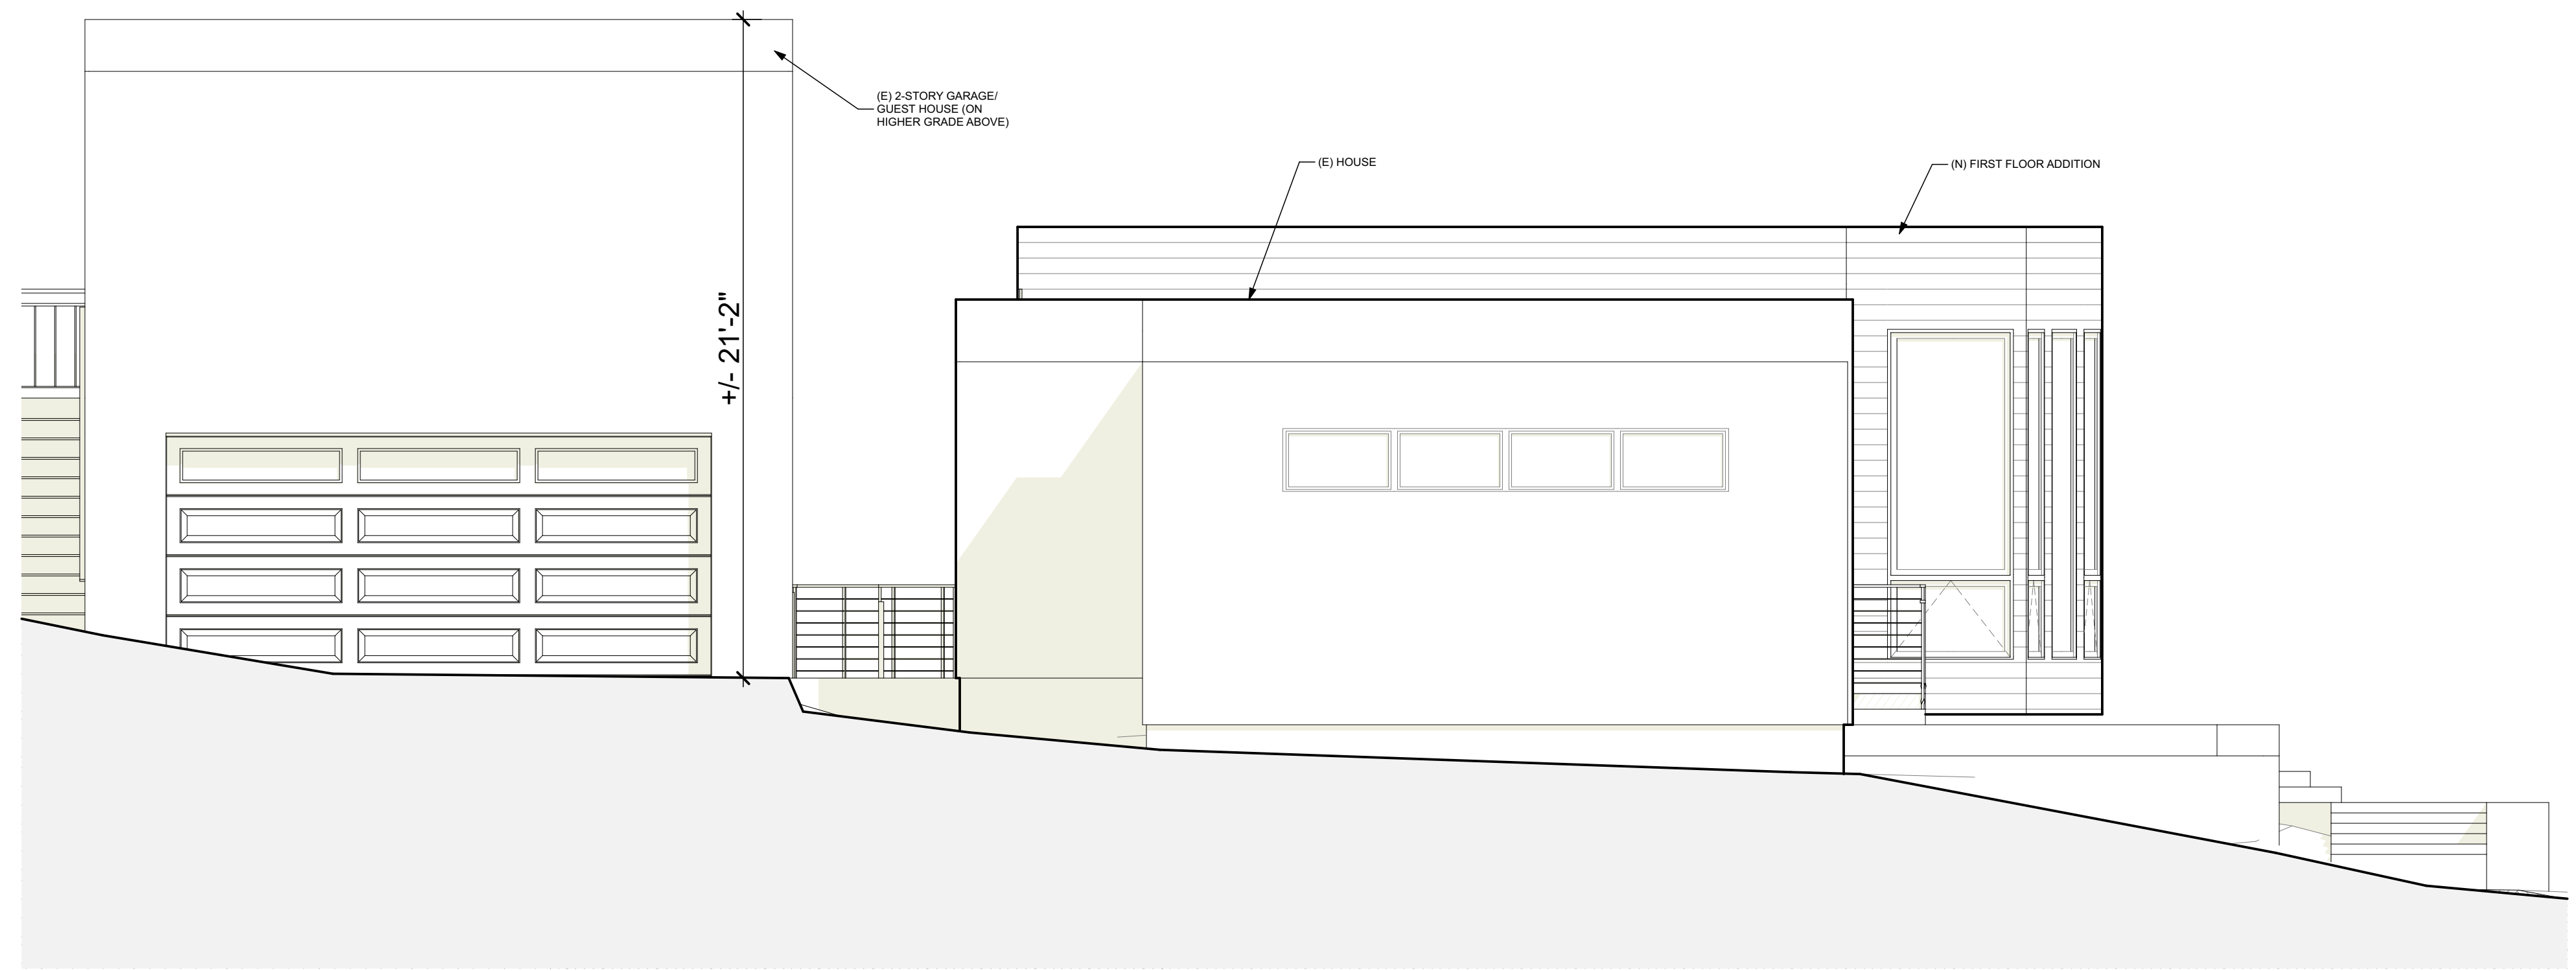
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PROPOSED ELEVATIONS

DRAWN: EB
 DATE: 9/19/2019
 SCALE: 1/4" = 1'-0"
 JOB NO.: 6
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NORTH ELEVATION
 SCALE: 1/4" = 1'-0"



EAST ELEVATION
 SCALE: 1/4" = 1'-0"



NORTH/ANGLE ELEVATION
 SCALE: 1/4" = 1'-0"


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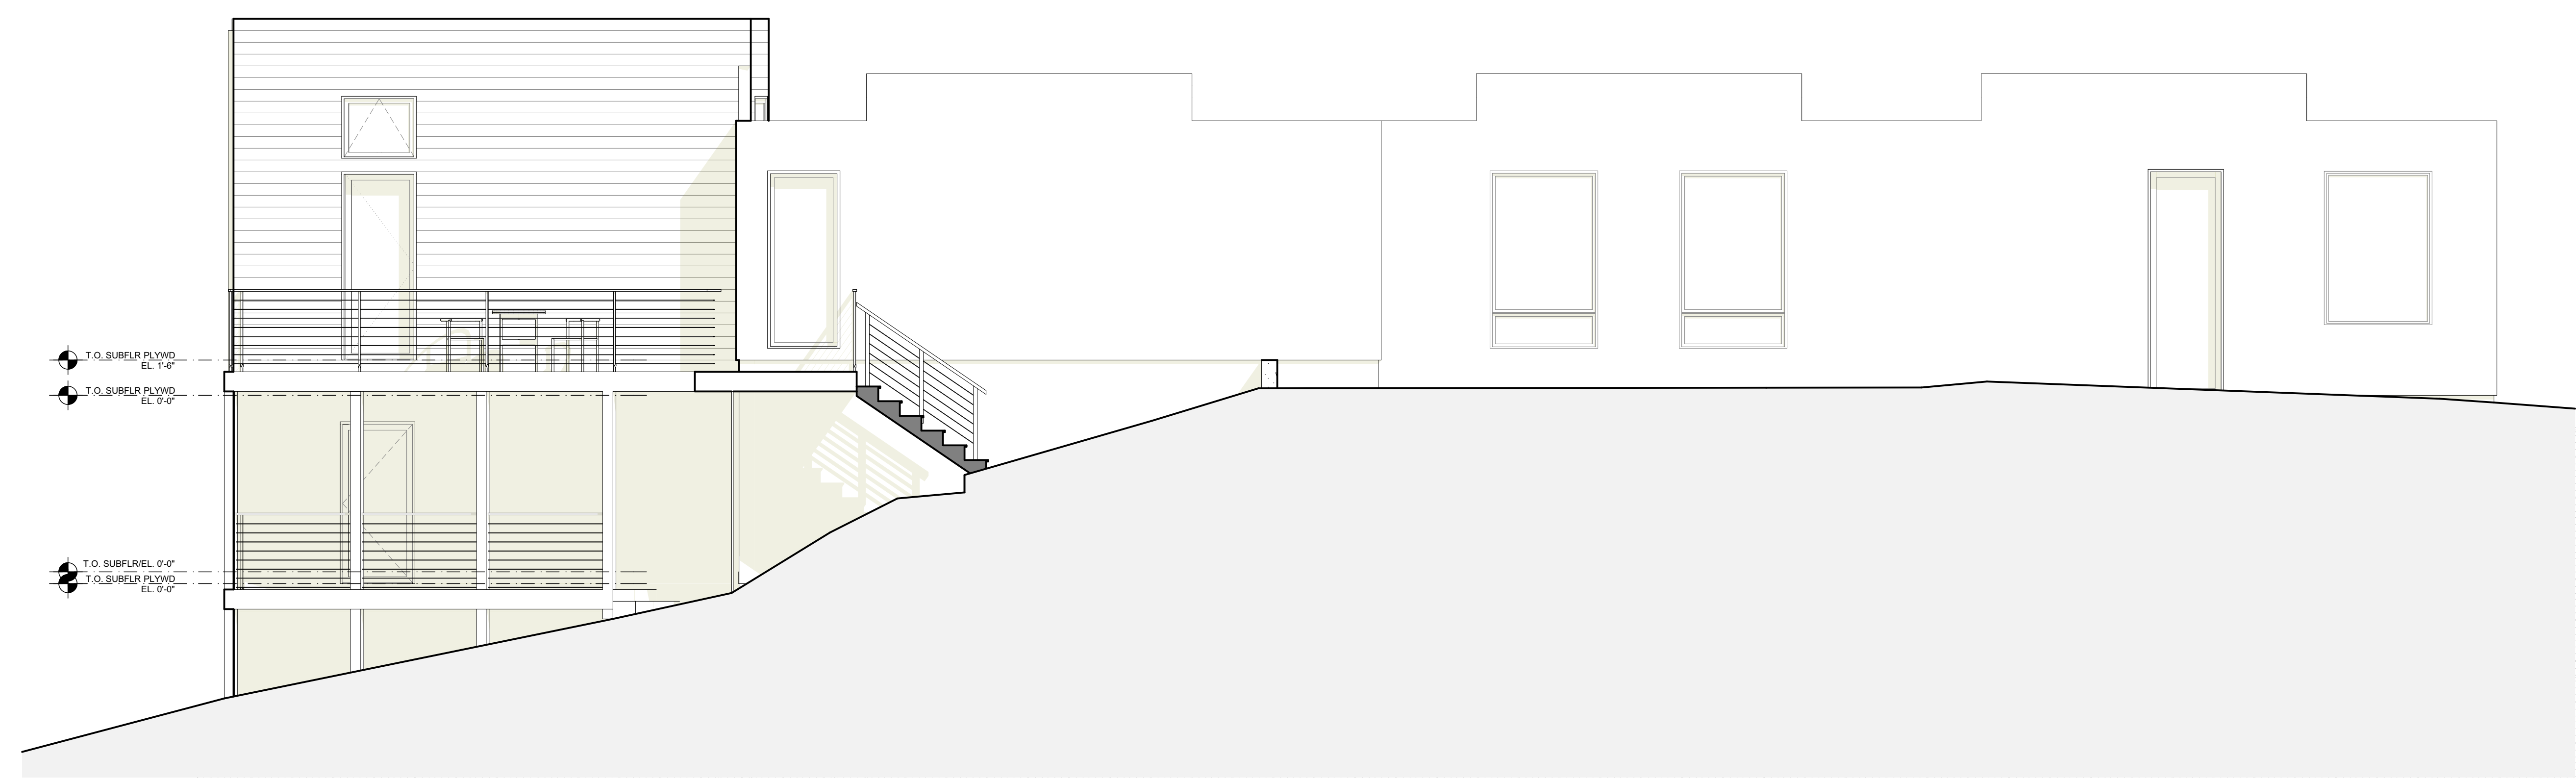
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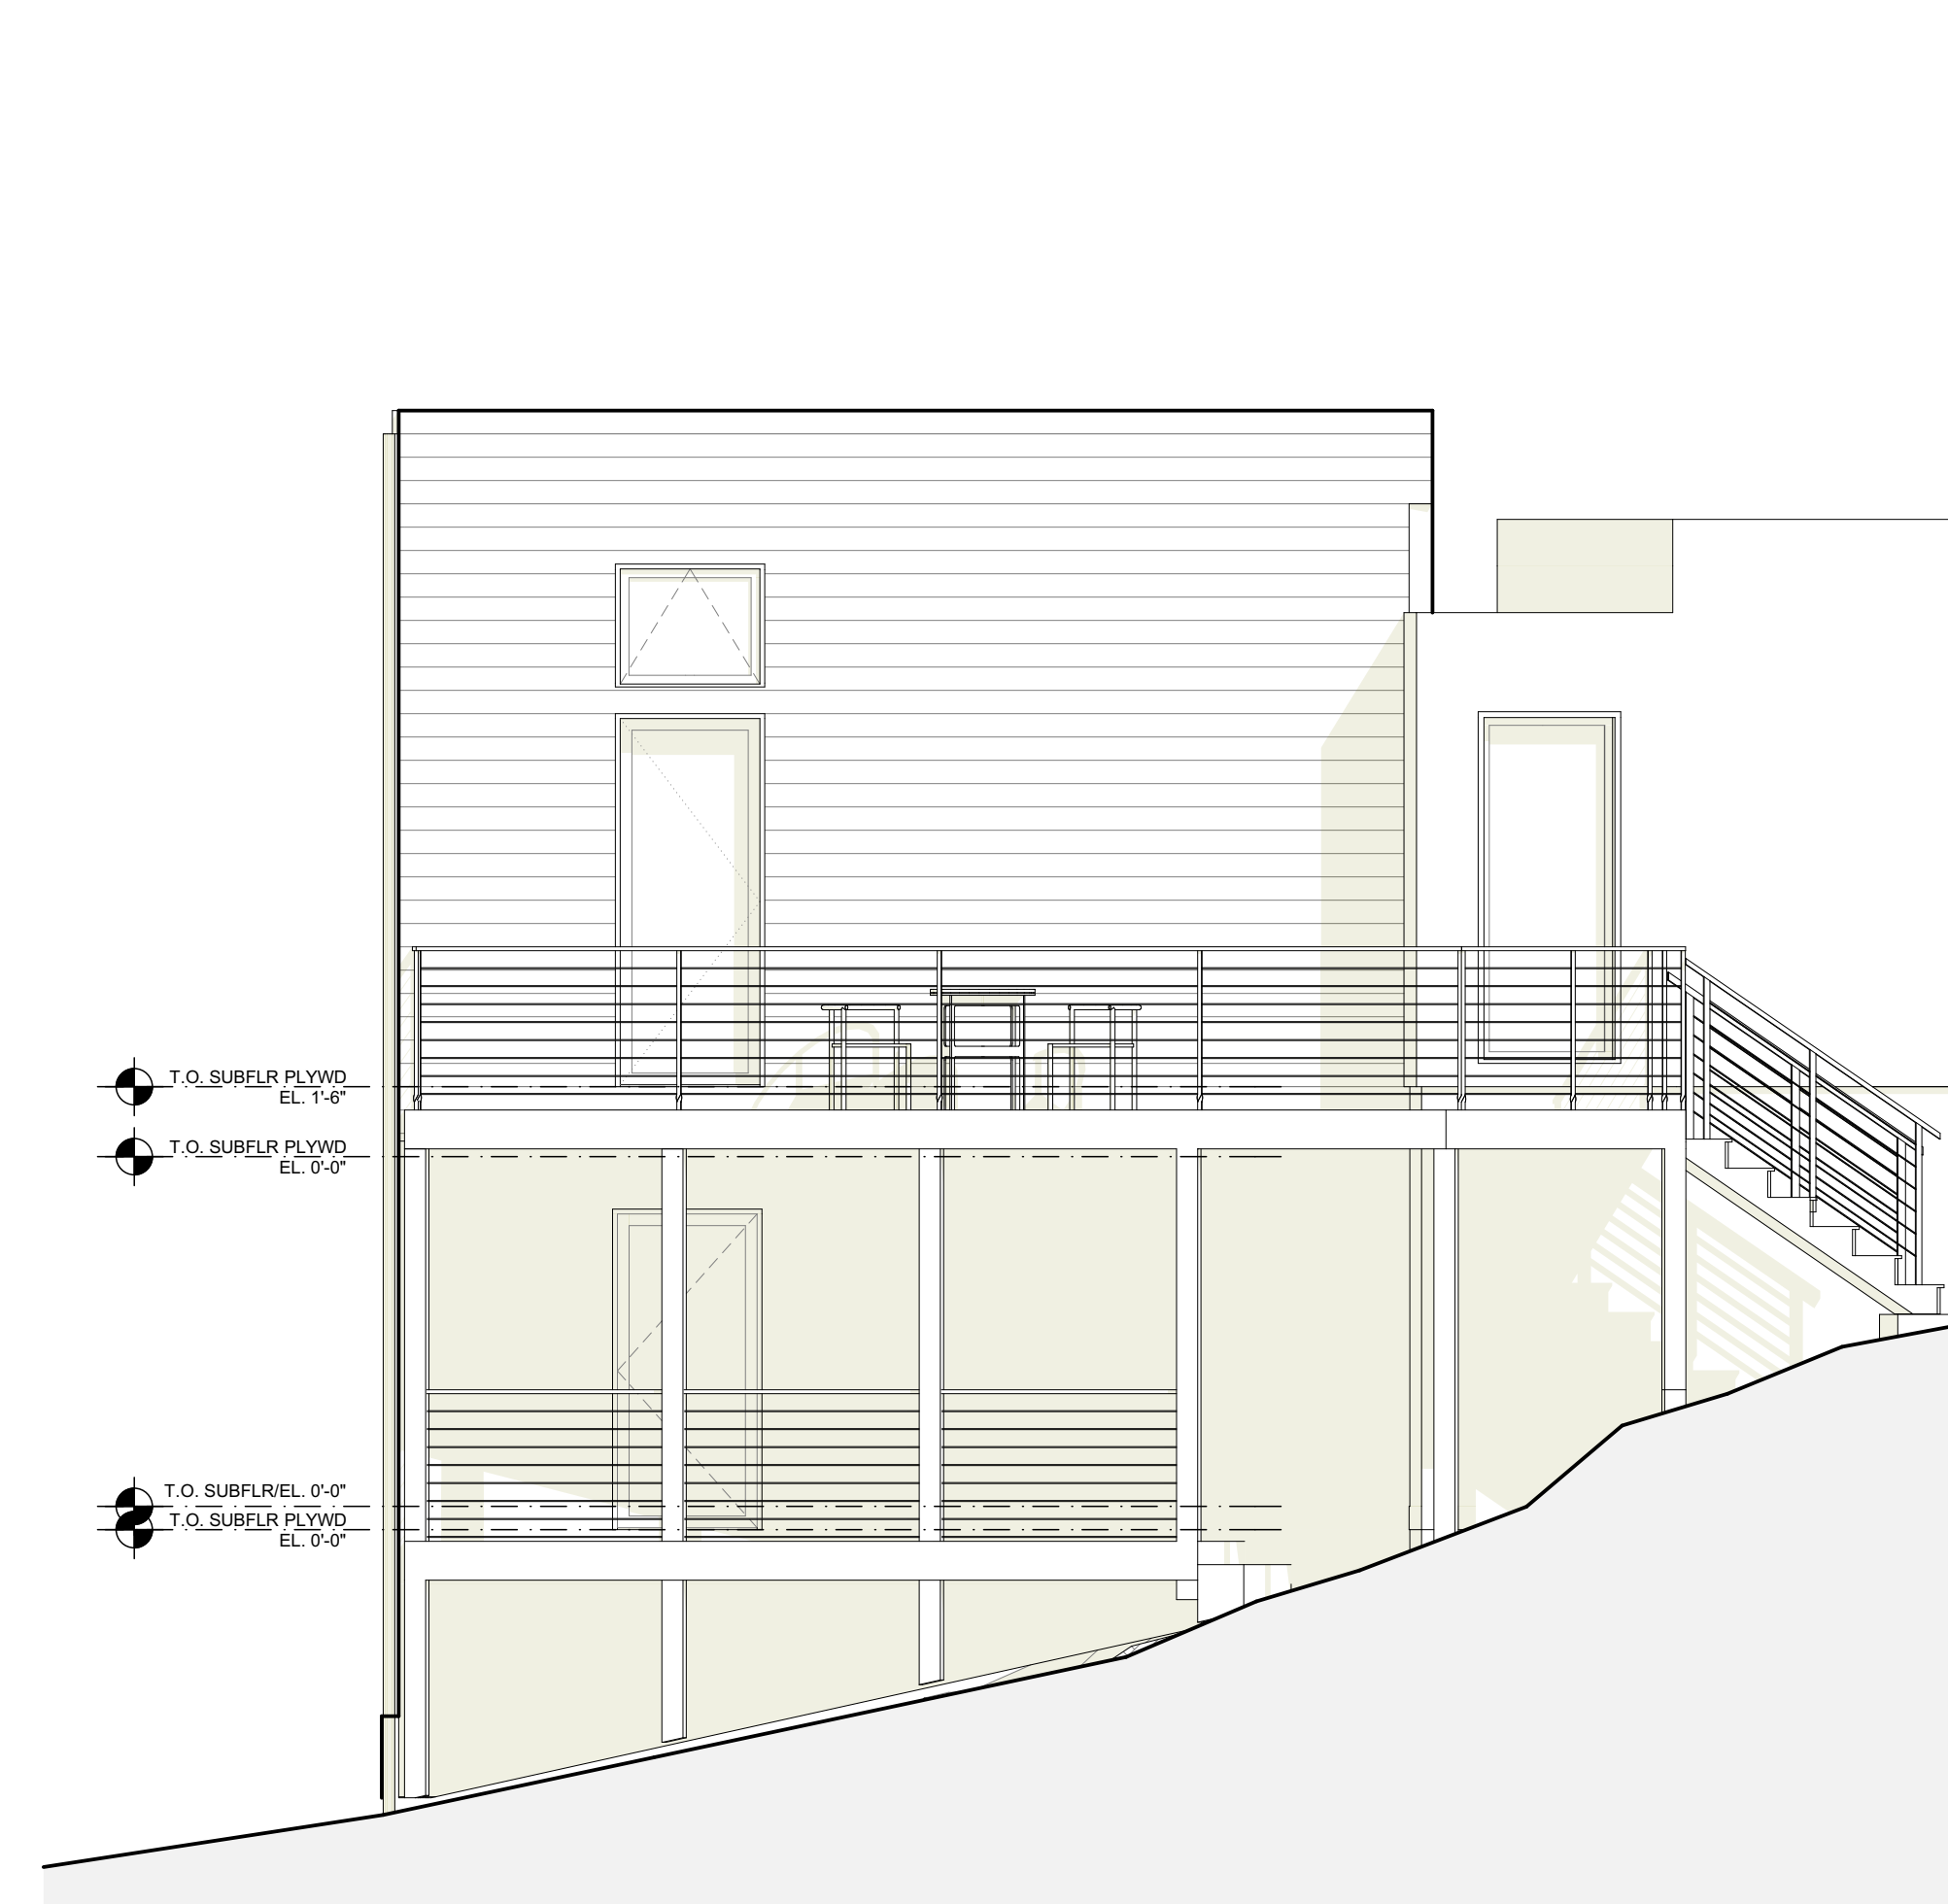
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| SCALE: | 1/4" = 1'-0" |
| JOB NO.: | 6 |
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| SHEET: | A3.3 |



SOUTH ELEVATION
 SCALE: 1/4" = 1'-0"



SOUTH/ANGLE ELEVATION
 SCALE: 1/4" = 1'-0"

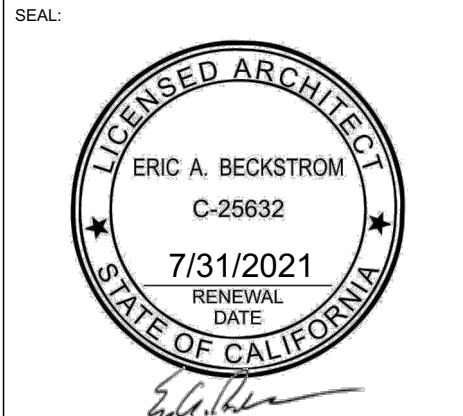

WEST/ANGLE ELEVATION
 SCALE: 1/4" = 1'-0"

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